#### **GENERAL NOTES - SITE PLAN**

- A. ARCHITECTURAL DATUM 0'-0" EQUALS +6.90' ABOVE SEA LEVEL. REFER TO CIVIL GRADING PLAN.
- B. FOR PAVING LAYOUT, FENCING, LANDSCAPING, IRRIGATION, SITE FURNISHINGS AND LANDSCAPE LIGHTING, S.L.D.
- C. FOR ON-SITE AND OFF-SITE DEMOLITION, SITE UTILITIES, EASEMENTS, VEHICLE PAVING, AND STRIPING, PARKING AREA SIGNAGE, GRADING AND STREET IMPROVEMENTS S.C.D.
- D. FOR SITE LIGHTING S.E.D., S.L.D., AND A3 SERIES ARCHITECTURAL ELEVATIONS.
- E. COORDINATE ALL DIGGING WITH EXISTING UTILITIES.
- F. PAINT ALL EXPOSED UTILITIES, SUCH AS BACKFLOW PREVENTERS, METERS, TRANSFORMERS, ETC. TO EXTENT PERMISSIBLE BY LOCAL UTILIES. COLOR TO BE SELECTED BY ARCHITECT.
- G. FOR DEMOLITION PLAN, S.C.D. FOR TREE PROTECTION PLAN, S.L.D.
- H. SEE JOINT TRENCH DESIGN DRAWINGS FOR DRY UTILITY LAYOUT.

I. ACCESSIBLE PATH OF TRAVEL AS INDICATED ON PLAN IS A BARRIER-FREE ACCESS ROUTE WITHOUT ANY ABRUPT LEVEL CHANGES EXCEEDING 1/2" IF BEVELED AT 1:2 MAX SLOPE AND SURFACE IS STABLE, FIRM, AND SLIP RESISTANT. CROSS SLOPE DOES NOT EXCEED 2% AND SLOPE IN THE TRAVEL CONTAINS 'PASSING SPACES' MINIMUM OF 60" X 60", LOCATED NOT GREATER THAN 200' APART. SEGMENTS OF ACCESSIBLE PATH OF TRAVEL HAVING CONTINUOUS GRADIENTS HAVE LEVEL AREAS, A MINIMUM OF 60" LONG, NOT GREATER THAN 400' APART. (CBC 11B-402.2)

FOR ADDITIONAL ARCH SYMBOLS, SEE GENERAL SHEETS

ACCESSIBLE ROUTE, SEE NOTE I. SETBACK PHASING LINE -----LADDER PAD

	KEYNOTES
2.01	PROPERTY LINE (BLUE, DOUBLE-DASHED LINE)
2.02	SETBACK LINE
12.96	SHORT-TERM BICYCLE PARKING, S.L.D.
21.05	FIRE DEPARTMENT CONNECTION, S.FP.D.
22.25	AT-GRADE FLOW-THROUGH PLANTER, S.C.D., S.L.D.
22.26	RAISED FLOW-THROUGH PLANTER, S.C.D., S.L.D., SEE 29/A8.21
22.27	AT-GRADE BIORETENTION BASIN, S.C.D., S.L.D.
33.01	TRANSFORMER, SEE DRY UTILITY & CIVIL DWGS
34.61	EMERGENCY VEHICLE ACCESS

North Housing, Block A

PAUL M MCELWEE

Alameda, CA 94501

JOB NO. DRAWN CHECKED

JOB CAPTAIN ISSUE

7	DATE	DESCRIPTION
	08/27/21	ENTITLEMENT SET
	12/8/21	SD SET
	12/13/21	ENTITLEMENT RESUBMITTAL #1
	03/22/22	100% DD SET
	09/29/22	PERMIT SUBMITTAL
	03/01/23	Senior Resubmittal 1
	03/01/23	PSH 1 Resubmittal 1
	03/01/23	PSH 2 Resubmittal 1
)	04/28/23	PSH 1 Resubmittal 2


6 04/28/23 PSH 2 Resubmittal 2 06/28/23 BID SET

DRAWING TITLE SITE PLAN

TRUE NORTH

NORTH HOUSING, BLOCK A, SITE PLAN

1" = 20'-0"

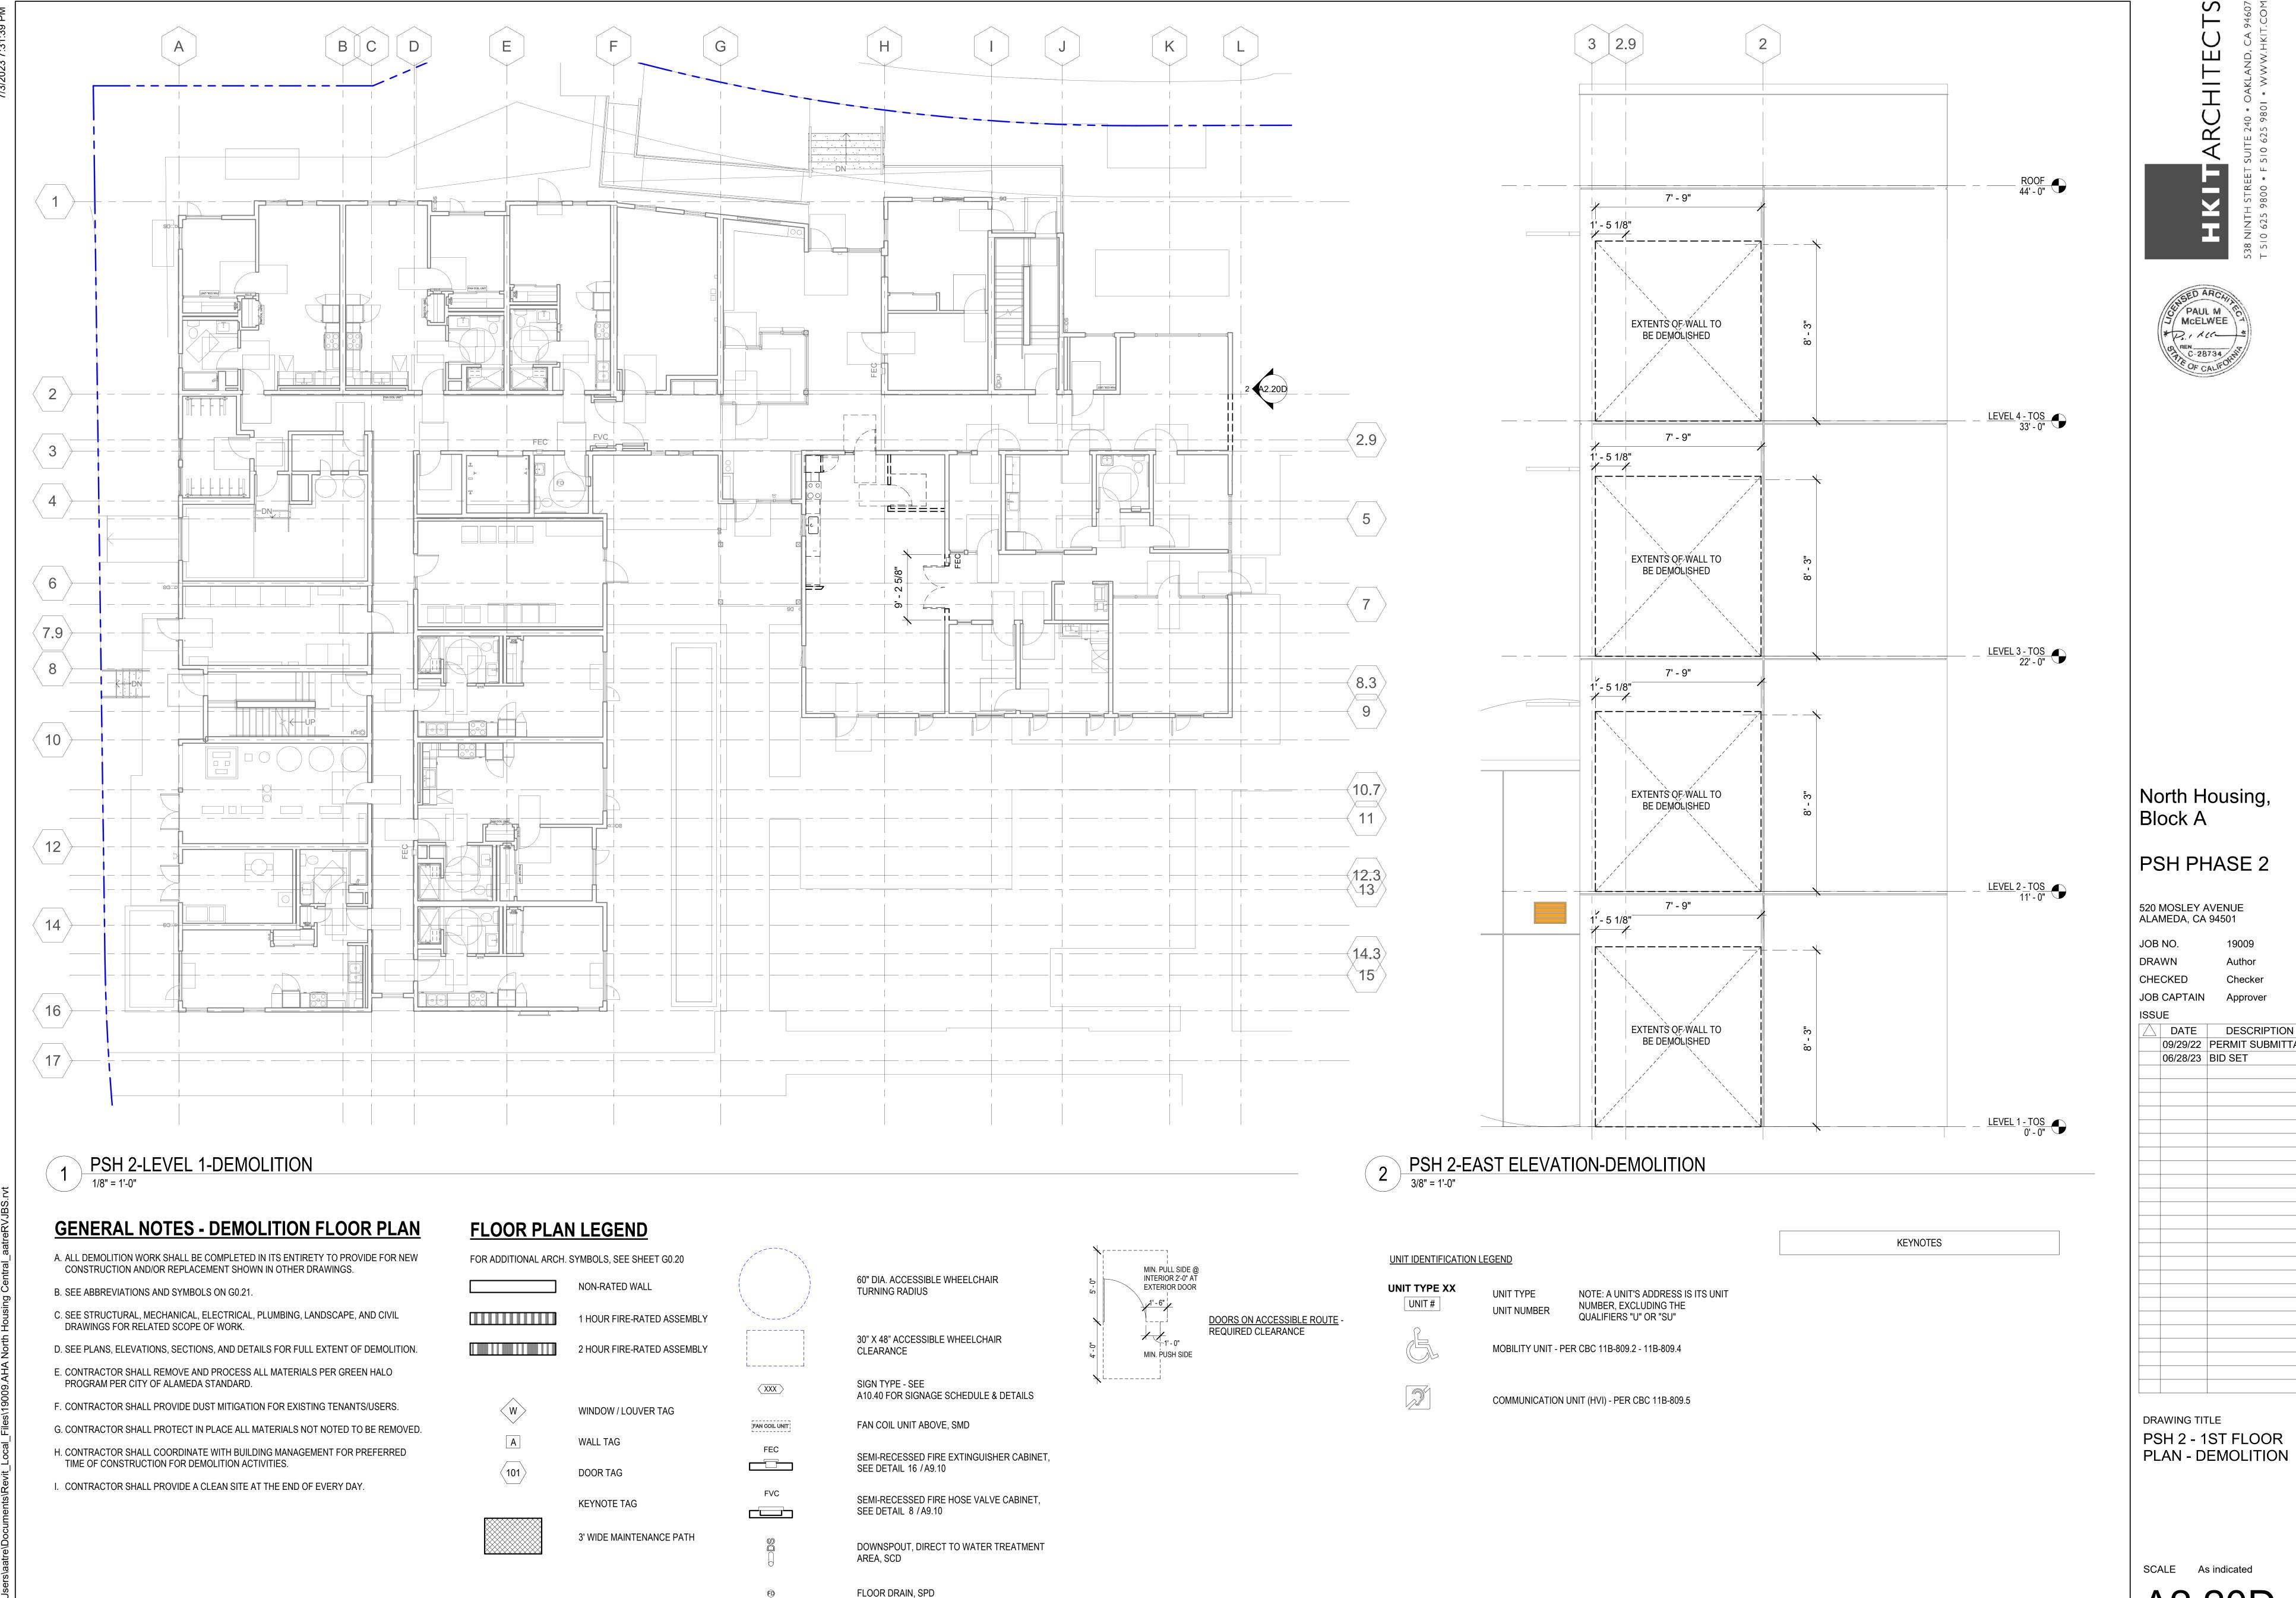



North Housing, Block A

PSH PHASE 2

520 MOSLEY AVENUE ALAMEDA, CA 94501

JOB NO.

DRAWN

Checker

JOB CAPTAIN

DESCRIPTION

09/29/22 PERMIT SUBMITTAL 06/28/23 BID SET

DRAWING TITLE PSH 2 - 1ST FLOOR

K. AT ROOF, PROVIDE CRICKETS AT ALL MECHANICAL EQUIPMENT, LARGE CURB LOCATIONS, AND OTHER ELEMENTS TO DIRECT WATER AROUND AND TO

APPROPRIATE DRAINAGE.

North Housing,

DESCRIPTION 08/27/21 | ENTITLEMENT SET 12/13/21 ENTITLEMENT RESUBMITTAL #1

03/22/22 | 100% DD SET 08/22/22 | 50% CD SET

09/29/22 PERMIT SUBMITTAL 3 03/01/23 PSH 2 Resubmittal 1

6 04/28/23 PSH 2 Resubmittal 2

06/28/23 BID SET

PSH 2 - 1ST FLOOR





North Housing, Block A

PSH PHASE 2

520 MOSLEY AVENUE ALAMEDA, CA 94501

CHECKED Checker

JOB CAPTAIN

DESCRIPTION 08/27/21 ENTITLEMENT SET 12/8/21 SD SET 12/13/21 ENTITLEMENT RESUBMITTAL #1 03/22/22 | 100% DD SET

08/22/22 50% CD SET 09/29/22 PERMIT SUBMITTAL 3 03/01/23 PSH 2 Resubmittal 1

6 04/28/23 PSH 2 Resubmittal 2 06/28/23 BID SET

DRAWING TITLE PSH 2 - 2ND FLOOR PLAN

K. AT ROOF, PROVIDE CRICKETS AT ALL MECHANICAL EQUIPMENT, LARGE CURB LOCATIONS, AND OTHER ELEMENTS TO DIRECT WATER AROUND AND TO

APPROPRIATE DRAINAGE.



North Housing, Block A

520 MOSLEY AVENUE ALAMEDA, CA 94501

DRAWN

CHECKED Checker

JOB CAPTAIN

DESCRIPTION 08/27/21 | ENTITLEMENT SET 12/8/21 SD SET

12/13/21 ENTITLEMENT RESUBMITTAL #1

03/22/22 | 100% DD SET 08/22/22 | 50% CD SET

09/29/22 PERMIT SUBMITTAL

3 03/01/23 PSH 2 Resubmittal 1

6 04/28/23 PSH 2 Resubmittal 2

06/28/23 BID SET

DRAWING TITLE PSH 2 - 3RD FLOOR PLAN

FLOOR DRAIN, SPD

CLASSIFICATION IN CBC TABLE 803.13

APPROPRIATE DRAINAGE.

K. AT ROOF, PROVIDE CRICKETS AT ALL MECHANICAL EQUIPMENT, LARGE CURB LOCATIONS, AND OTHER ELEMENTS TO DIRECT WATER AROUND AND TO



#### North Housing, Block A

#### SENIOR PHASE

2000 LAKEHURST CIRCLE

ALAMEDA, CA 94501

JOB NO.

DRAWN CHECKED Checker

JOB CAPTAIN **ISSUE** 


> DESCRIPTION 08/27/21 | ENTITLEMENT SET 12/8/21 SD SET 12/13/21 ENTITLEMENT


RESUBMITTAL #1 03/22/22 | 100% DD SET


08/22/22 | 50% CD SET 09/29/22 PERMIT SUBMITTAL 3 03/01/23 PSH 2 Resubmittal 1

06/28/23 BID SET

DRAWING TITLE PSH 2 - 4TH FLOOR PLAN

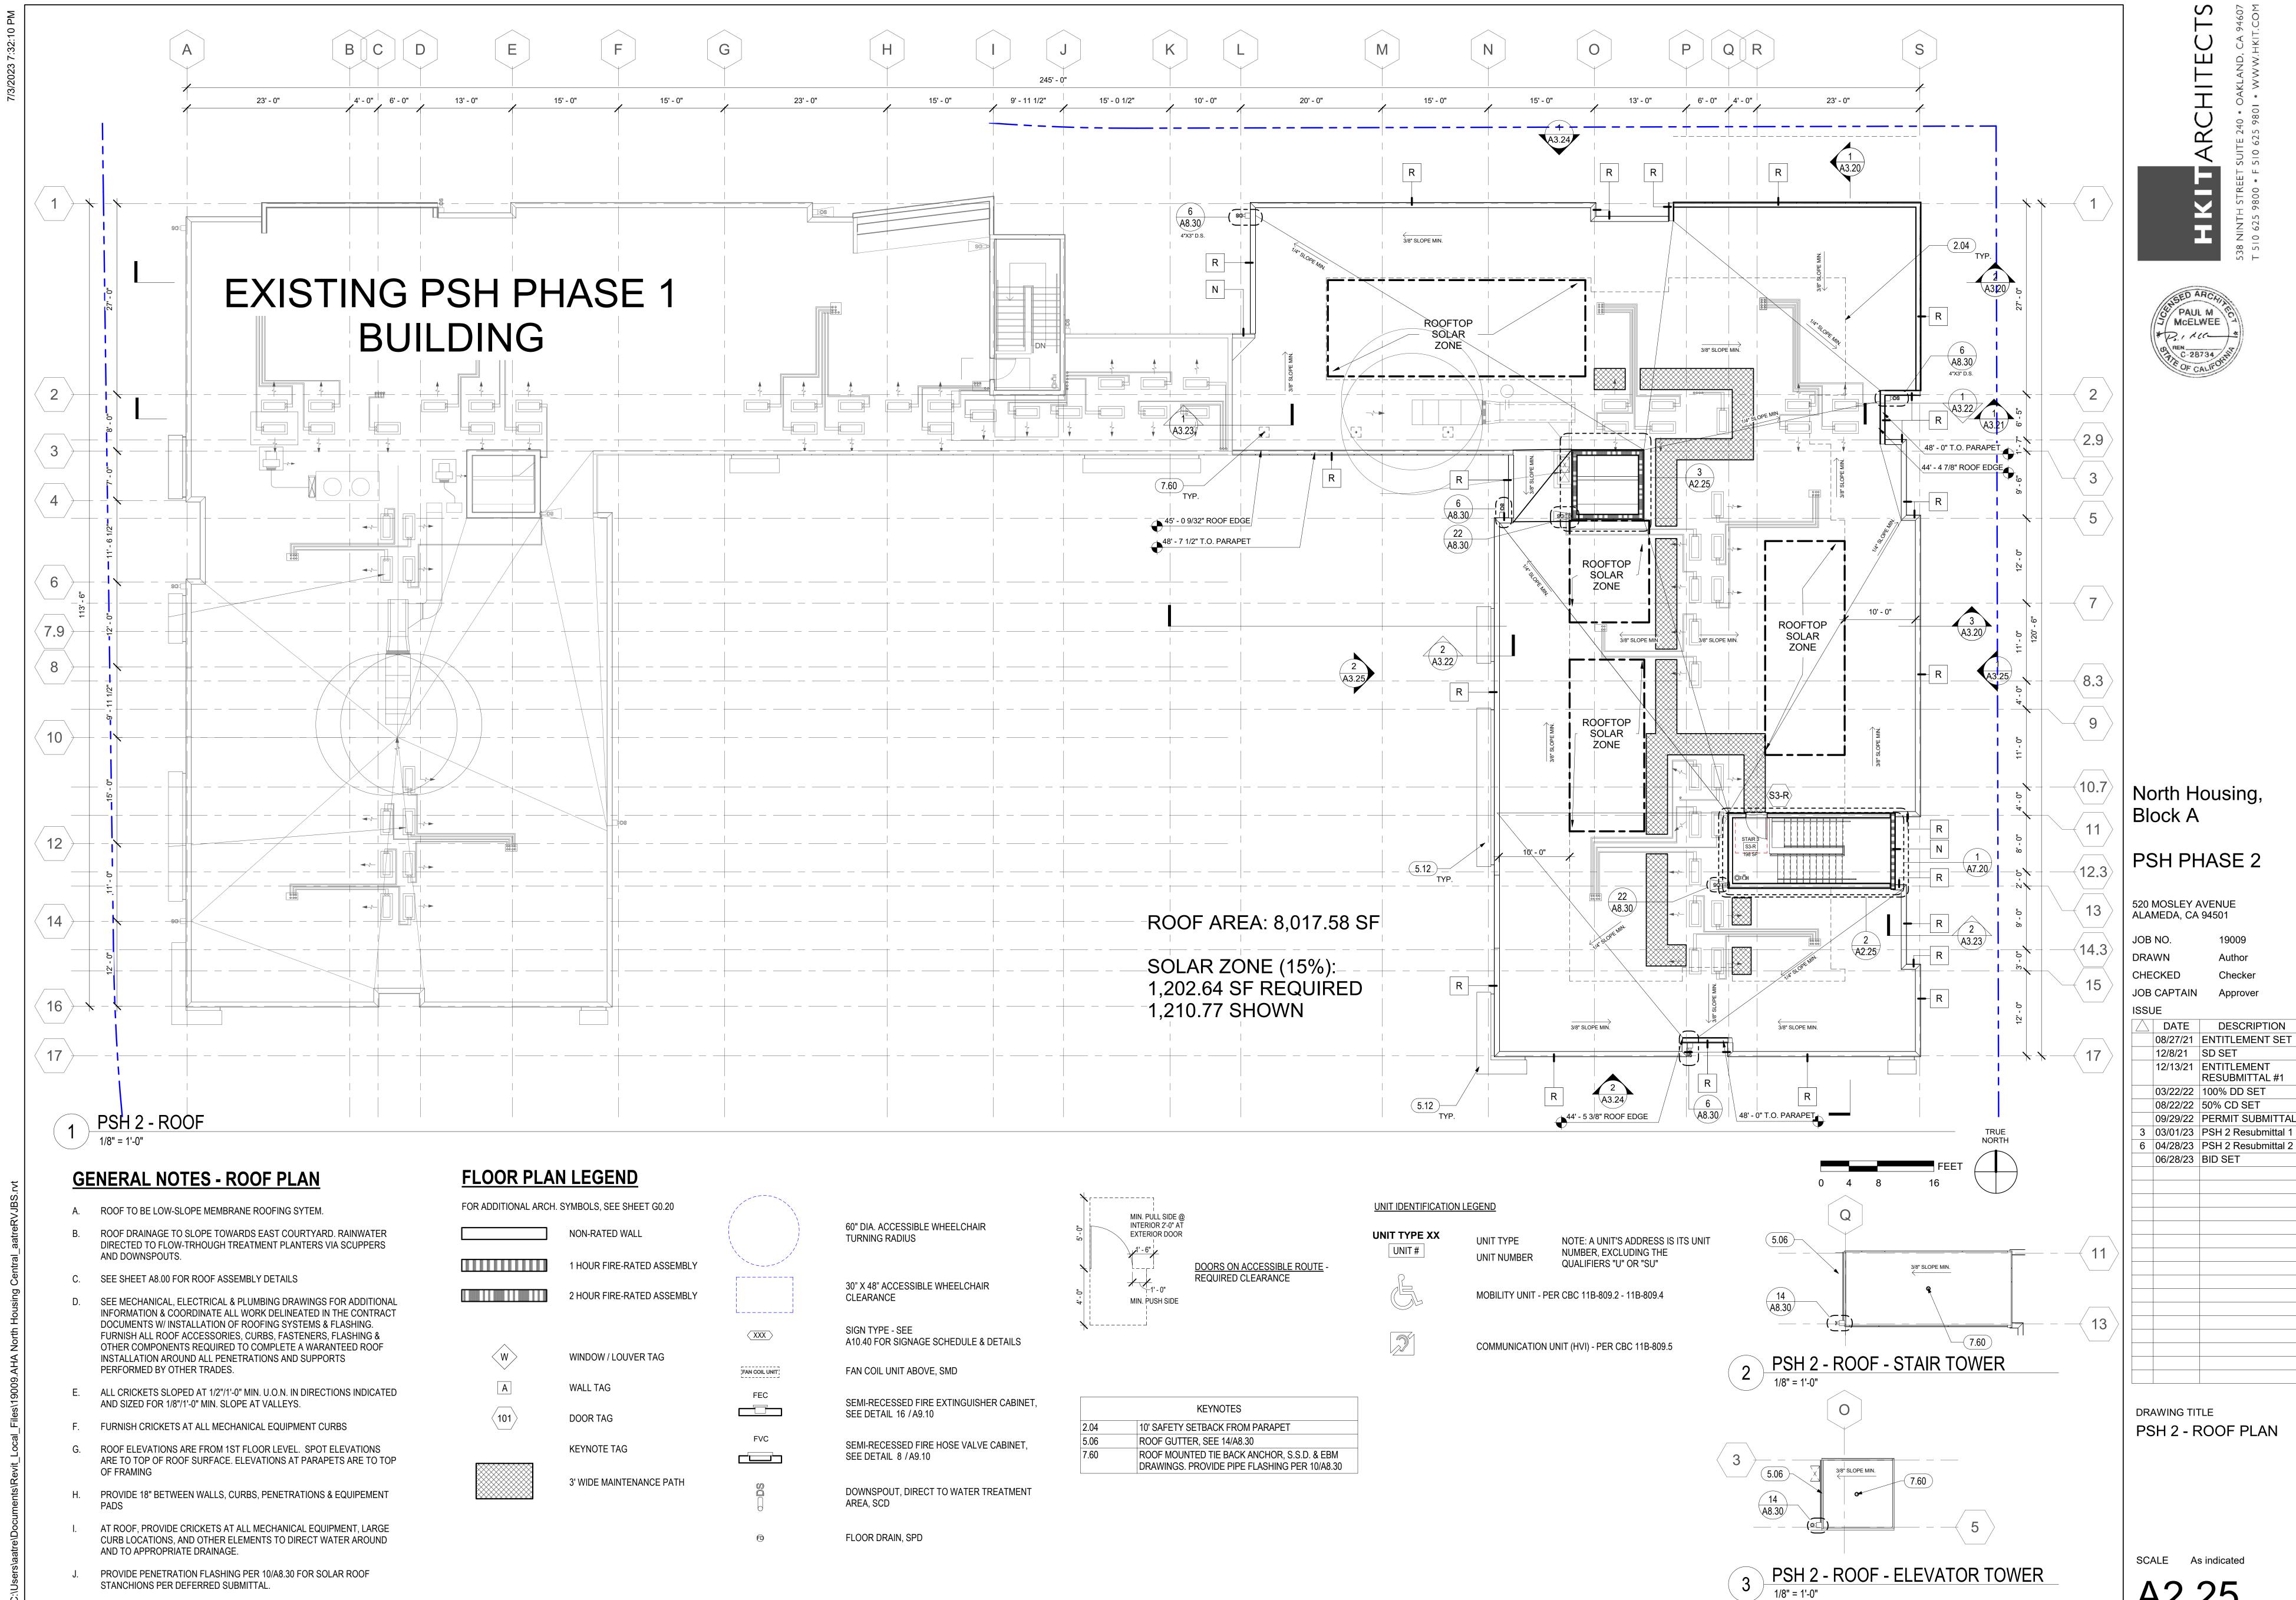

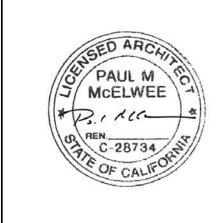

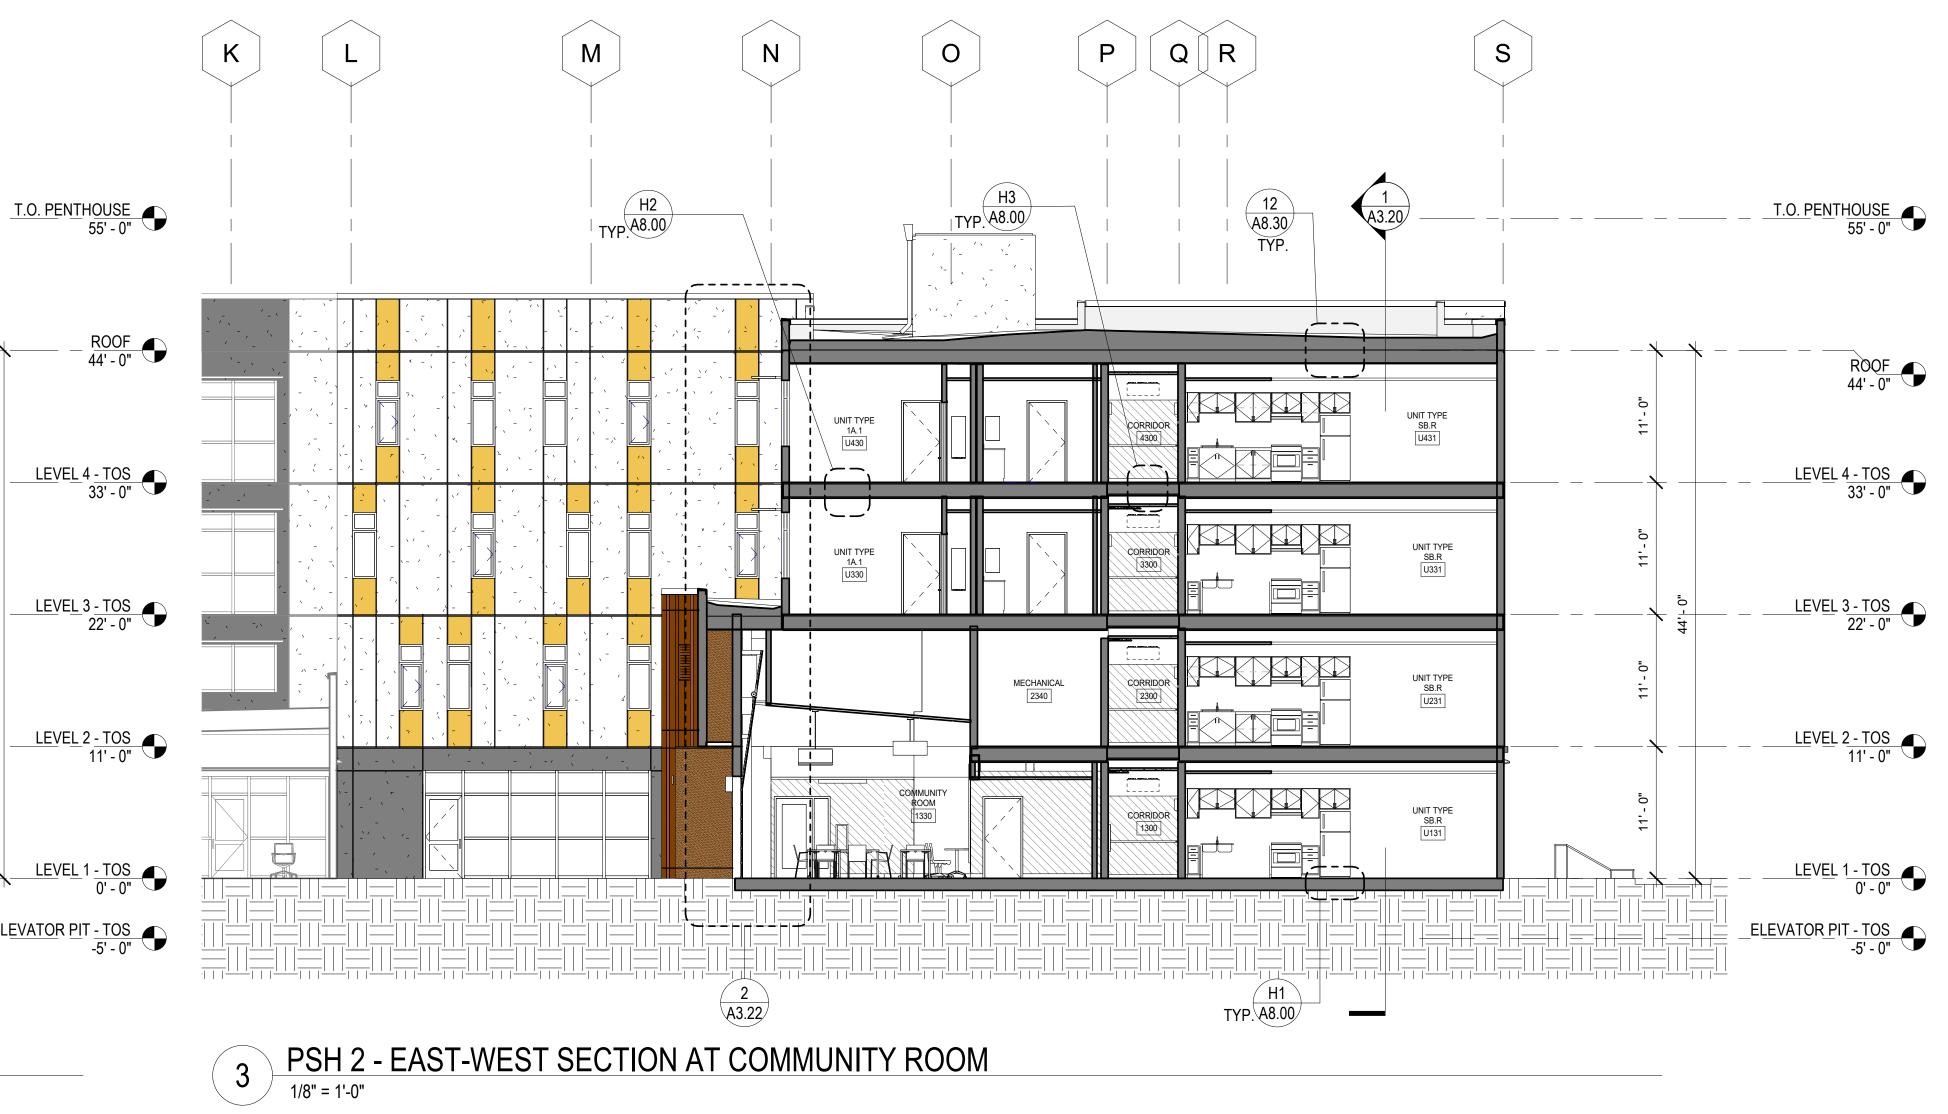

A8.00 TYP.

PSH 2 - NORTH-SOUTH SECTION

1/8" = 1'-0"

2 PSH 2 - EAST-WEST SECTION

1/8" = 1'-0"

North Housing, Block A

PSH PHASE 2

520 MOSLEY AVENUE ALAMEDA, CA 94501

> OB NO. 19009 ORAWN Author

CHECKED Checker

JOB CAPTAIN Approve

ISSUE

DATE DESCRIPTION

08/27/21 ENTITLEMENT SET

12/8/21 SD SET

12/13/21 ENTITLEMENT
RESUBMITTAL #1

03/22/22 100% DD SET 08/22/22 50% CD SET 09/29/22 PERMIT SUBMITTAL 3 03/01/23 PSH 2 Resubmittal 1 06/28/23 BID SET

DRAWING TITLE
PSH 2 - BUILDING
SECTIONS

| | SCALE 1/8" = 1'-

A3.20

HKIT ARCHITECTS

538 NINTH STREET SUITE 240 • OAKLAND, CA 94607



North Housing, Block A

PSH PHASE 2

520 MOSLEY AVENUE ALAMEDA, CA 94501

JOB CAPTAIN

JOB NO. 19009
DRAWN Author
CHECKED Checker

06/28/23 BID SET

Approver

DRAWING TITLE
PSH 2 - BUILDING
SECTIONS

SCALE 1/8" = 1'-0"

A3.21

520 MOSLEY AVENUE ALAMEDA, CA 94501

Author

Checker

Approver

ISSUE

3 03/01/23 PSH 2 Resubmittal 1 06/28/23 BID SET

FC-12 BRAND: TBD COLOR: KELLY MOORE "SWEET TEA" FIBER CEMENT PANEL (FC-14) FC-14 BRAND: TBD COLOR: COLOR: KELLY

FIBER CEMENT PANEL (FC-12)

CEMENT PLASTER (CP-11)
BRAND: TBD

CP-12) CEMENT PLASTER (CP-12): BRAND: TBD

COLOR: KELLY MOORE

"ROWDY ORANGE"

COLOR: KELLY MOORE

COLOR: KELLY MOORE

COLOR: KELLY MOORE

"PEBBLE BEACH"

CP-13) CEMENT PLASTER (CP-13): BRAND: TBD

"KETTLEMAN"

CP-14 CEMENT PLASTER (CP-14): BRAND: TBD

"ORCA WHITE"

FIBER CEMENT PANEL (FC-11)
BRAND: TBD
COLOR: KELLY MOORE
"ROWDY ORANGE"

**GENERAL NOTES - ENLARGED WALL** 

A. ONLY RELEVANT INFORMATION IS NOTED/KEYED ON ENLARGED WALL SECTIONS AND ELEVATIONS. SEE OVERALL ELEVATIONS, A2 SERIES FLOOR PLANS, AND A10 SERIES WINDOW/LOUVER/STOREFRONT

**SECTIONS & ELEVATIONS** 

SCHEDULES FOR BALANCE OF INFORMATION.


MOORE "KETTLEMAN" FIBER CEMENT PANEL (FC-15)
BRAND: TBD COLOR: KELLY MOORE "ORCA

FIBER CEMENT PANEL (FC-16)
BRAND: TBD
COLOR: KELLY MOORE "WALNUT GROVE"

FIBER CEMENT PANEL (FC-17)
BRAND: TBD COLOR: KELLY MOORE "ARMADILLO EGG"

FIBER CEMENT SIDING (FC-13) FCL-20 BRAND: TBD COLOR: KELLY MOORE "PEBBLE BEACH"

ALUMINUM PANEL ROOF 2" STANDING SEAM AT 16" O.C. AEP SPAN DESIGN SPAN METAL ROOFING COLOR: ZINC GRAY

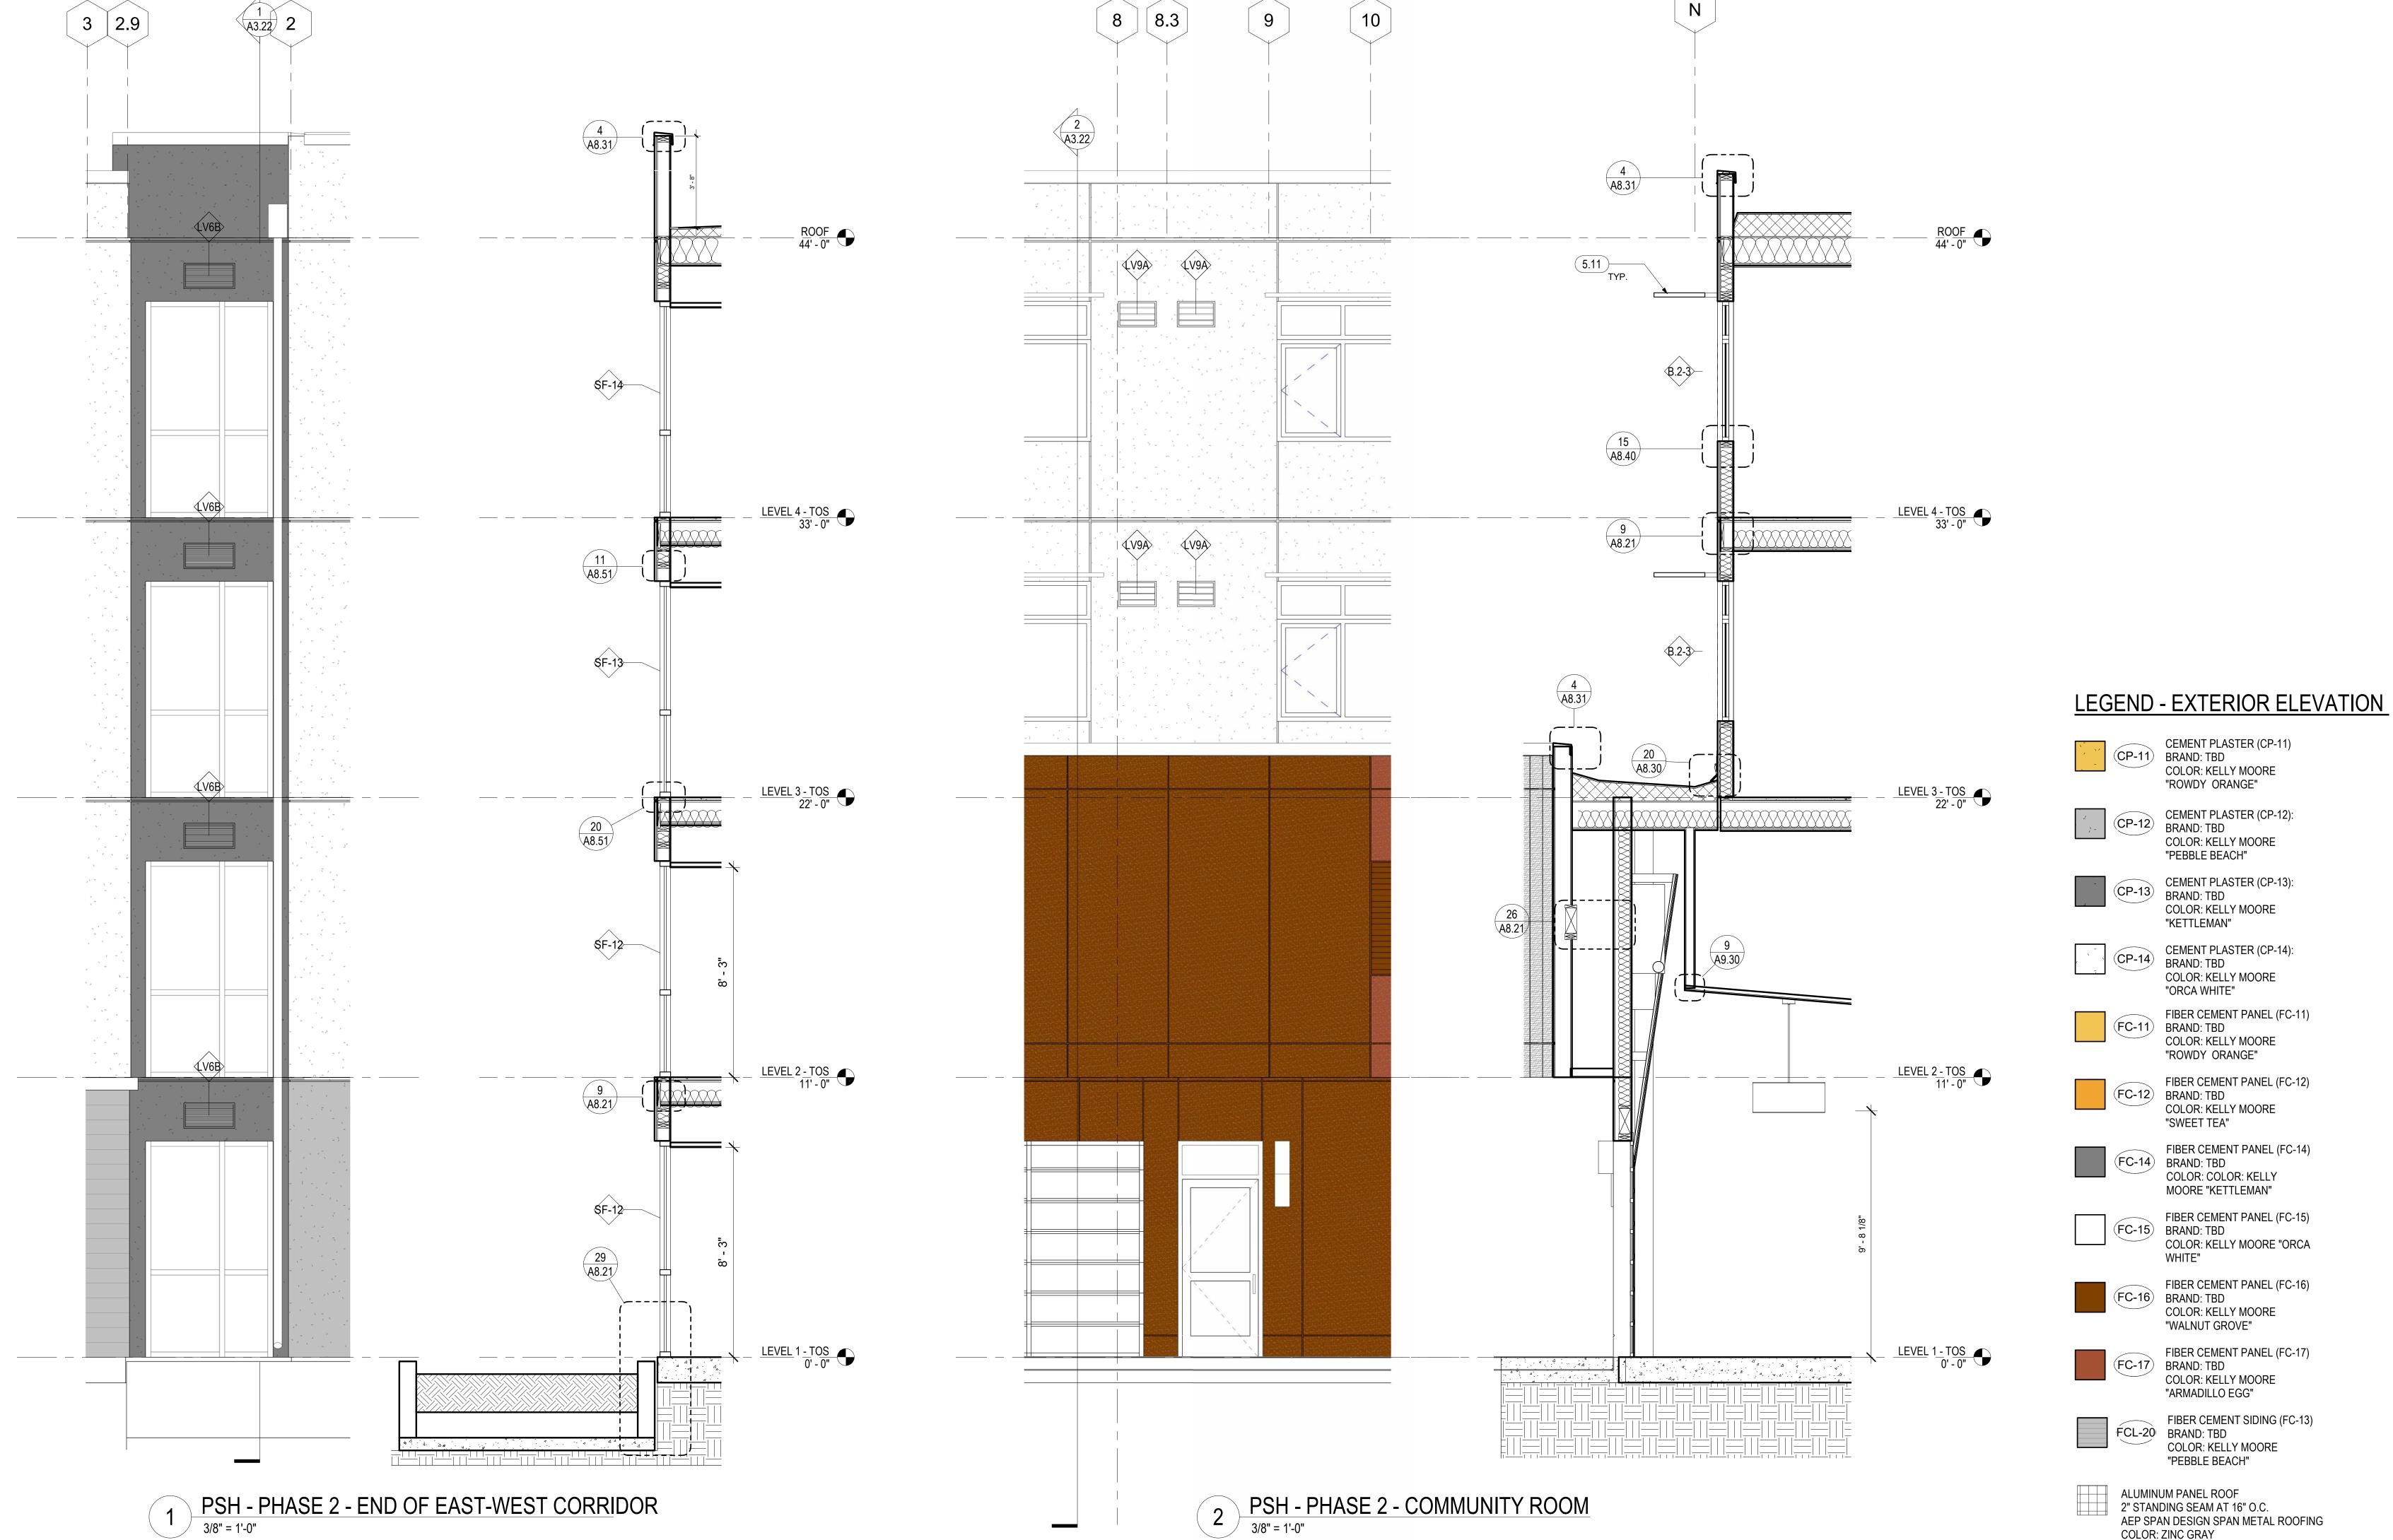

Block A

PSH PHASE 2

JOB NO. DRAWN

CHECKED JOB CAPTAIN

> DESCRIPTION 12/8/21 SD SET 03/22/22 100% DD SET 08/22/22 50% CD SET 09/29/22 PERMIT SUBMITTAL

DRAWING TITLE PSH 2 - WALL SECTIONS

North Housing, Block A

PSH PHASE 2

520 MOSLEY AVENUE ALAMEDA, CA 94501

JOB NO.

Author DRAWN

CHECKED Checker JOB CAPTAIN Approver

ISSUE

DESCRIPTION 03/22/22 100% DD SET 08/22/22 50% CD SET

09/29/22 PERMIT SUBMITTAL 3 03/01/23 PSH 2 Resubmittal 1 06/28/23 BID SET

"ROWDY ORANGE" FIBER CEMENT PANEL (FC-12) FC-12 BRAND: TBD COLOR: KELLY MOORE

FIBER CEMENT PANEL (FC-14) FC-14 BRAND: TBD COLOR: COLOR: KELLY MOORE "KETTLEMAN"

"SWEET TEA"

**LEGEND - EXTERIOR ELEVATION** 

CEMENT PLASTER (CP-11)

CEMENT PLASTER (CP-12):

COLOR: KELLY MOORE

COLOR: KELLY MOORE

COLOR: KELLY MOORE

CEMENT PLASTER (CP-14):

FIBER CEMENT PANEL (FC-11)

"PEBBLE BEACH"

CP-13) CEMENT PLASTER (CP-13): BRAND: TBD

"KETTLEMAN"

"ORCA WHITE"

FC-11 BRAND: TBD COLOR: KELLY MOORE

COLOR: KELLY MOORE

"ROWDY ORANGE"

(CP-11) BRAND: TBD

(CP-12) BRAND: TBD

(CP-14) BRAND: TBD

**GENERAL NOTES - ENLARGED WALL** 

A. ONLY RELEVANT INFORMATION IS NOTED/KEYED ON ENLARGED WALL SECTIONS AND ELEVATIONS. SEE OVERALL ELEVATIONS, A2 SERIES

FLOOR PLANS, AND A10 SERIES WINDOW/LOUVER/STOREFRONT SCHEDULES FOR BALANCE OF INFORMATION.

**SECTIONS & ELEVATIONS** 


FIBER CEMENT PANEL (FC-15)
BRAND: TBD COLOR: KELLY MOORE "ORCA

FIBER CEMENT PANEL (FC-16) (FC-16) BRAND: TBD COLOR: KELLY MOORE "WALNUT GROVE" FIBER CEMENT PANEL (FC-17)

(FC-17) BRAND: TBD COLOR: KELLY MOORE "ARMADILLO EGG"

FIBER CEMENT SIDING (FC-13) FCL-20 BRAND: TBD COLOR: KELLY MOORE "PEBBLE BEACH"

ALUMINUM PANEL ROOF 2" STANDING SEAM AT 16" O.C. AEP SPAN DESIGN SPAN METAL ROOFING COLOR: ZINC GRAY

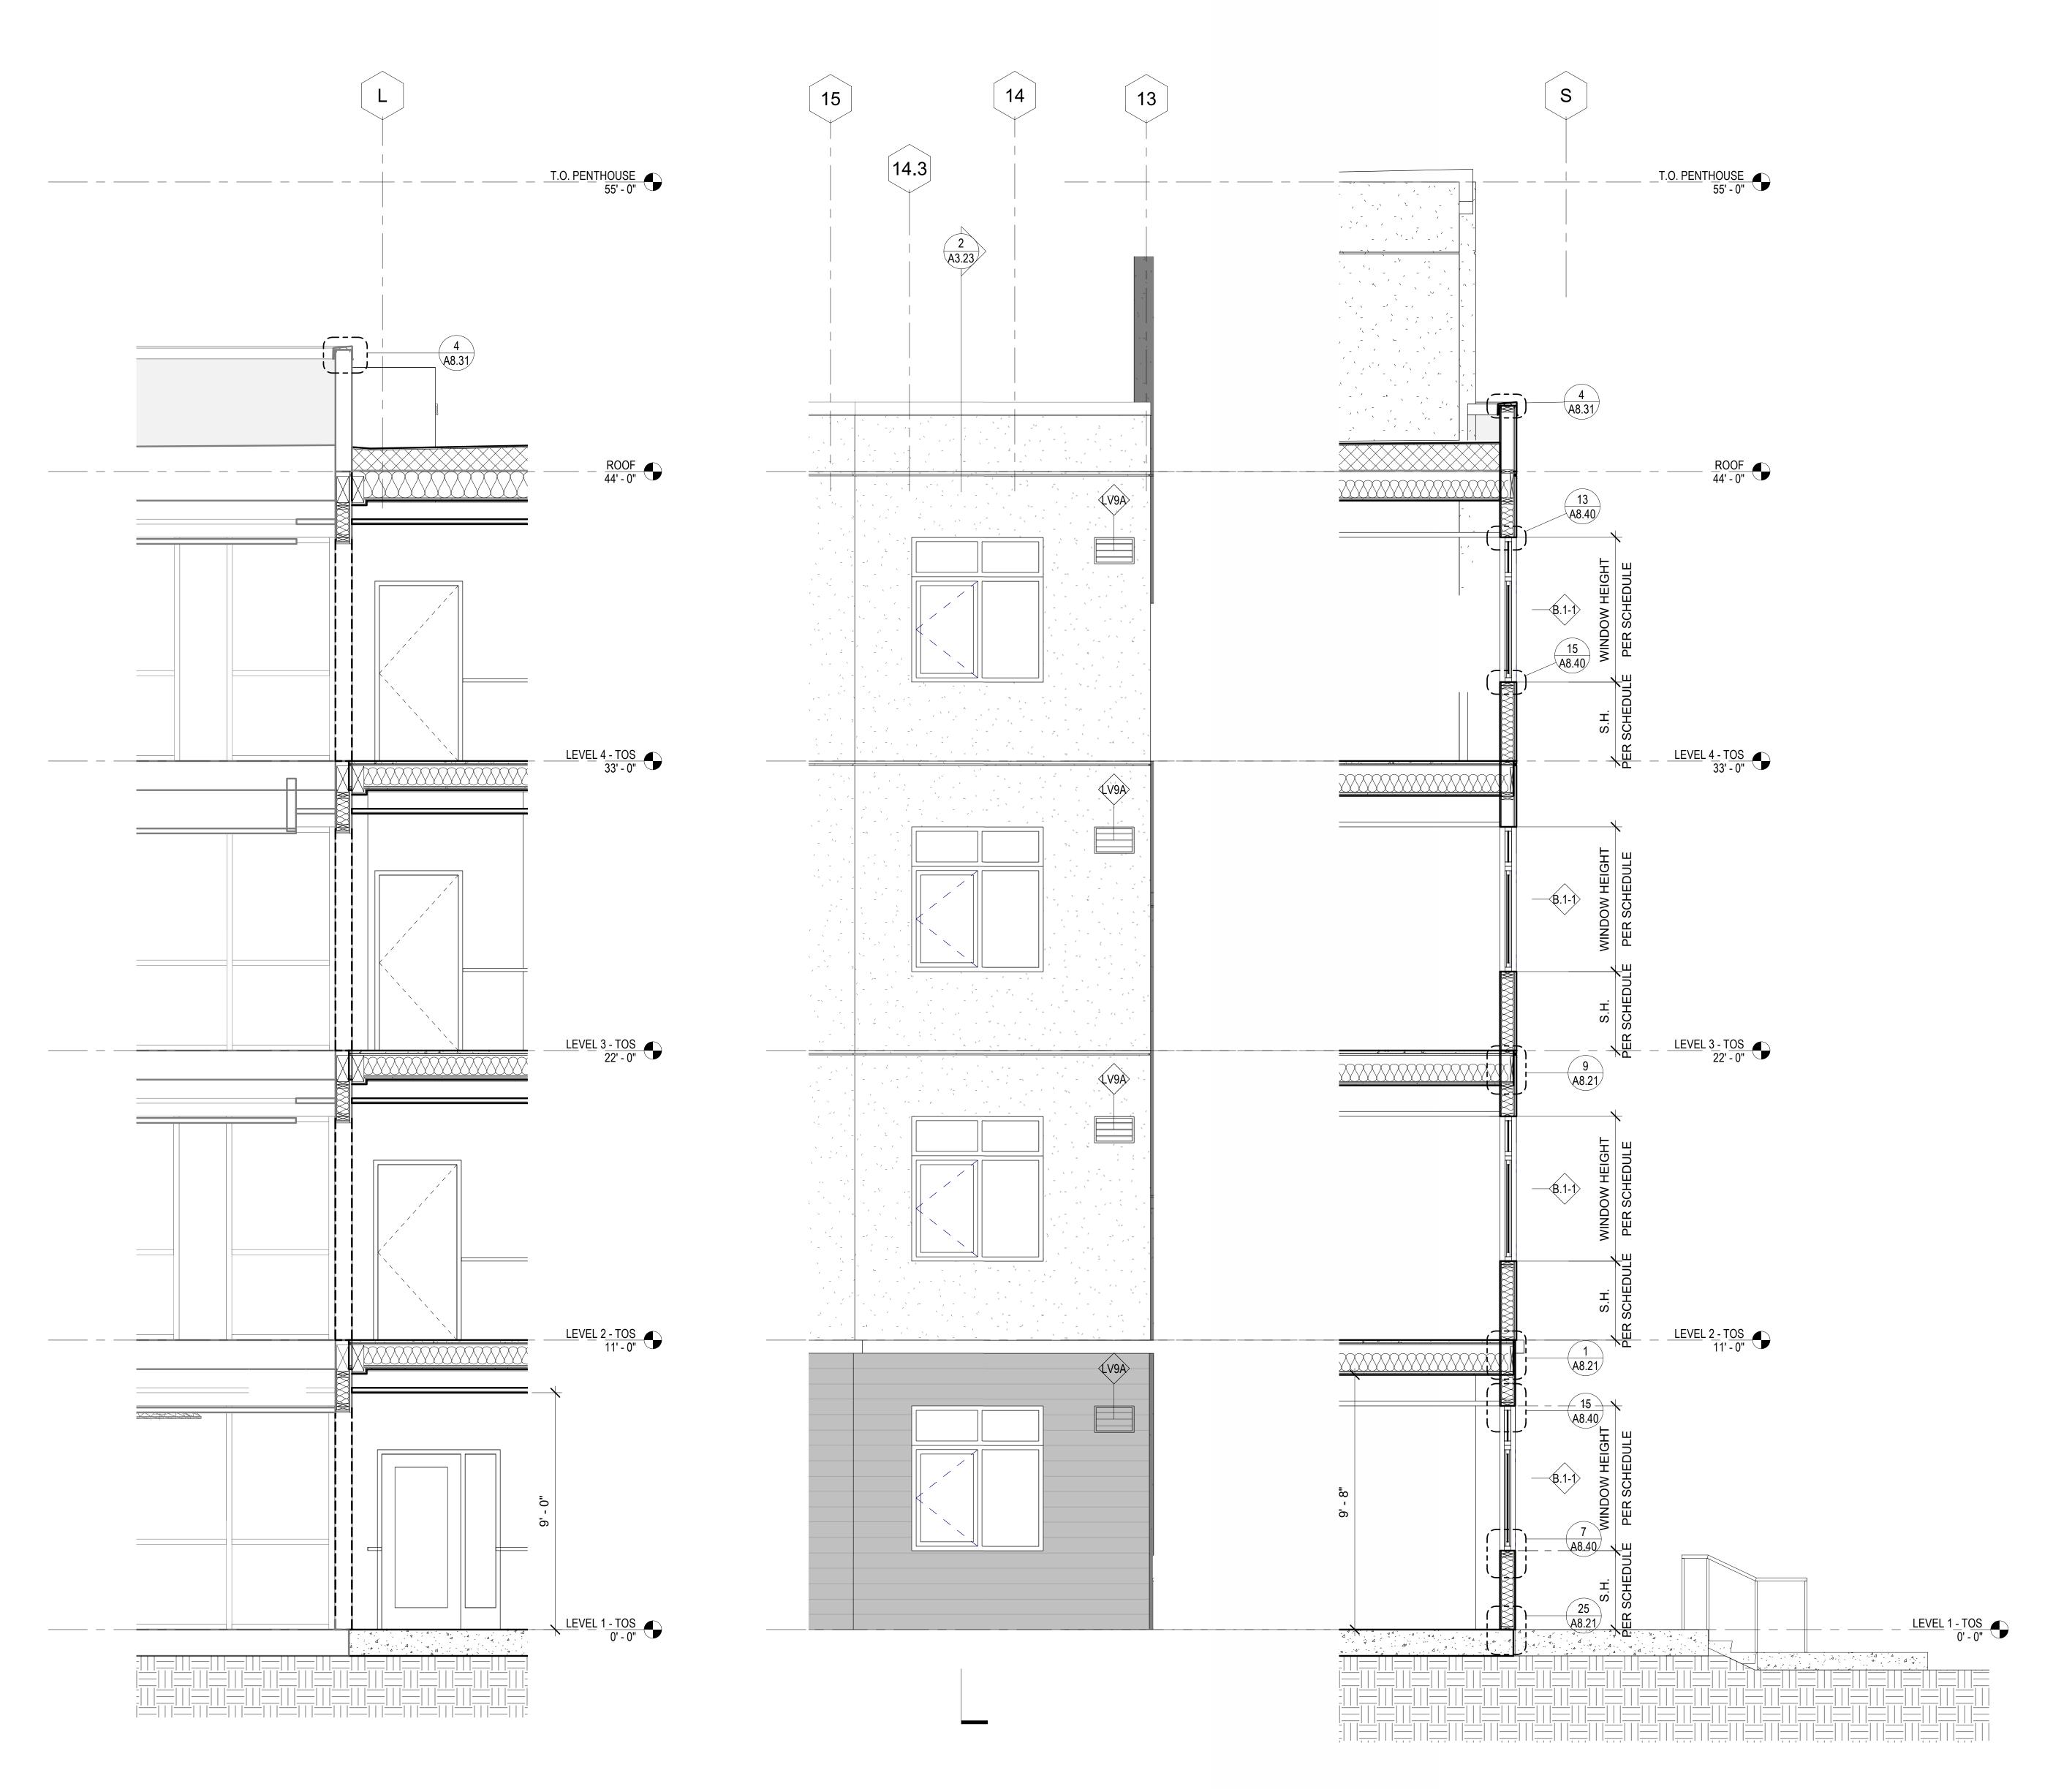

PSH 2 - EAST-WEST SECTION AT PHASE 1 CONNECTION
3/8" = 1'-0"

PSH 2 - EAST-WEST SECTION AT BLDG. EXTENSION

3/8" = 1'-0"

SCALE As indicated

DRAWING TITLE

SECTIONS

PSH 2 - WALL



538 NINTH STREET SUITE 240 · OAKLAND, CA 94607



North Housing, Block A

PSH PHASE 2

520 MOSLEY AVENUE ALAMEDA, CA 94501

JOB NO. 19009
DRAWN Author
CHECKED Checker

JOB CAPTAIN

DATE DESCRIPTION

12/8/21 SD SET

12/13/21 ENTITLEMENT RESUBMITTAL #1

03/22/22 100% DD SET

08/22/22 50% CD SET

09/29/22 PERMIT SUBMITTAL

09/29/22 PERMIT SUBMITTA
3 03/01/23 PSH 2 Resubmittal 1
06/28/23 BID SET

DRAWING TITLE

PSH 2 - EXTERIOR ELEVATIONS

SCALE As indicated

A3.24

PSH 2 - EAST ELEVATION


1/8" = 1'-0"



2 PSH 2 - WEST ELEVATION
1/8" = 1'-0"

- A. SEE A10 SERIES FOR WINDOW, LOUVER, VENT CAP & STOREFRONT SCHEDULE. SEE RCPS ON A6 SERIES FOR
- B. AT BUILDING INS/OUTS, FINISH MATERIAL TURNS CORNER AND TERMINATES AT INSIDE CORNER.
- C. FOR INSTANCES WHERE VENTS/WINDOWS/DOWNSPOUTS ARE LOCATED ON WALLS NOT VISIBLE ON EXTERIOR

KEYNOTES		
5.02	METAL GUARDRAIL, S.L.D.	
5.05	DOWNSPOUT, DIRECT TO WATER TREATMENT AREA, S.C.D., SEE 10/A8.30 FOR BRACKET DETAIL	
5.11	ALUMINUM SUNSHADE, SEE A8.23	
5.30	METAL PARAPET COPING, PAINT TO MATCH WALL, SEE 3/A8.30	
5.61	VERTICAL TRELLIS WITH LASER-CUT PATTERN, SEE XX/XX	
8.44	ALUMINUM STOREFRONT, SEE WINDOW & STOREFRONT SCHEDULE	
8.52	ROLL-UP GARAGE DOOR WITH GLASS PANELS, SEE DOOR SCHEDULE	
9.30	BELLY BAND, SEE 1/A8.21	
23.08	MECHANICAL LOUVER, S.M.D., PAINT TO MATCH ADJACENT WALL	
26.72	EXTERIOR BUILDING LIGHT, S.E.D., SEE OVERALL AND BUILDING ELEVATIONS FOR MOUNTING HEIGHT	

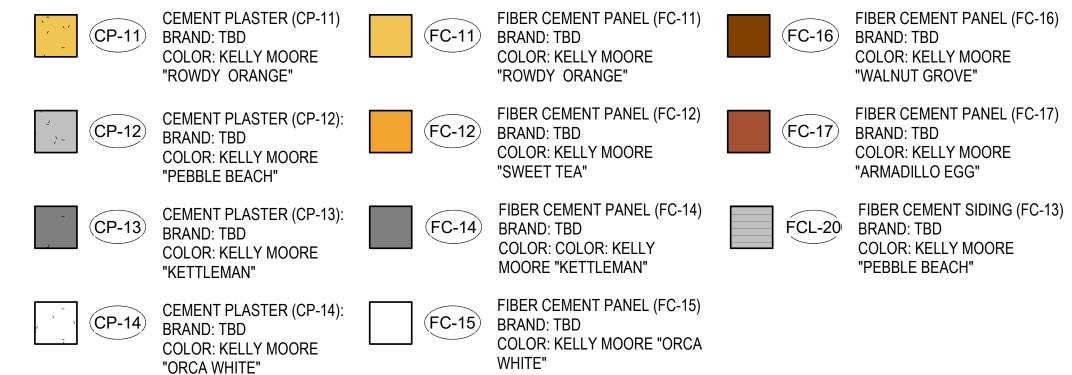

#### **ELEVATION LEGEND**

EXHAUST 3' RADIUS CLEARANCE

WINDOW / LOUVER / VENT CAP / STOREFRONT TAG, SEE SCHEDULE

CONTROL/MOVEMENT/REVEAL JOINT, SEE A8.22

EXTERIOR LIGHT FIXTURE, SED

## 520 MOSLEY AVENUE ALAMEDA, CA 94501

Block A

JOB NO. Author DRAWN Checker CHECKED

North Housing,

PSH PHASE 2

PAUL M MCELWEE


JOB CAPTAIN ISSUE

5552			
	DATE	DESCRIPTION	
	12/8/21	SD SET	
	12/13/21	ENTITLEMENT RESUBMITTAL #1	
	03/22/22	100% DD SET	
	08/22/22	50% CD SET	
	09/29/22	PERMIT SUBMITTAL	
3	03/01/23	PSH 2 Resubmittal 1	
	06/28/23	BID SET	


Approver

DRAWING TITLE PSH 2 - EXTERIOR **ELEVATIONS** 




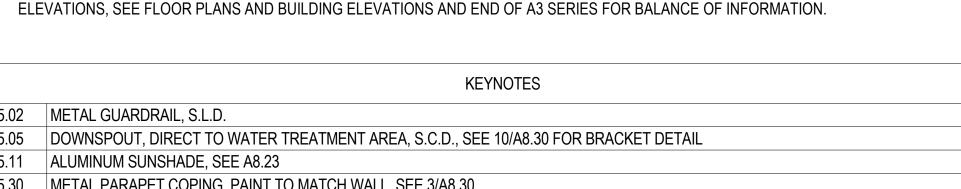

#### **ELEVATION MATERIAL LEGEND**

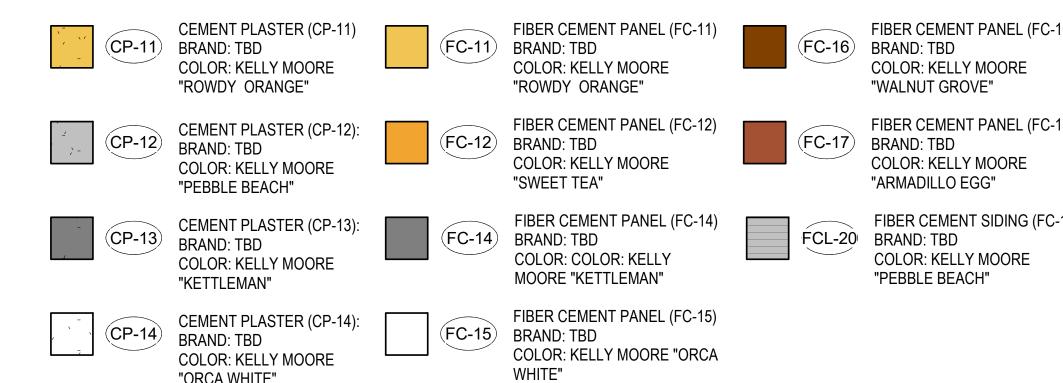

OUTSIDE AIR INTAKE 10' RADIUS CLEARANCE

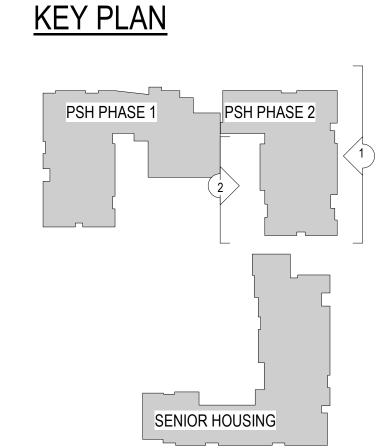

PSH 2 - COMMUNITY ROOM

SOUTH WALL AT GL 5

1/8" = 1'-0"

5.05

1/8" = 1'-0"

PSH 2 COMMUNITY ROOM


SOUTH WALL AT - GL 10.9


LEVEL 1 - TOS 0' - 0"

6 PSH 2 - COMMUNITY ROOM ANGLED WALL

1/8" = 1'-0"

5 PSH 2 - GL 5/N
1/8" = 1'-0"

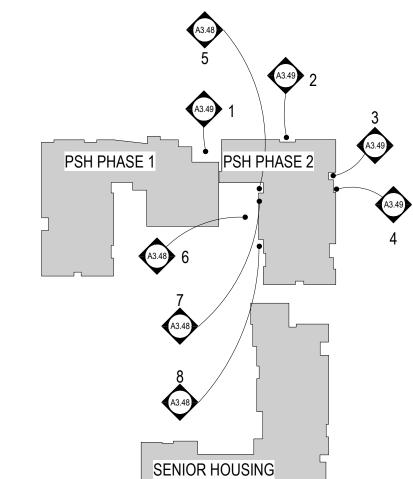

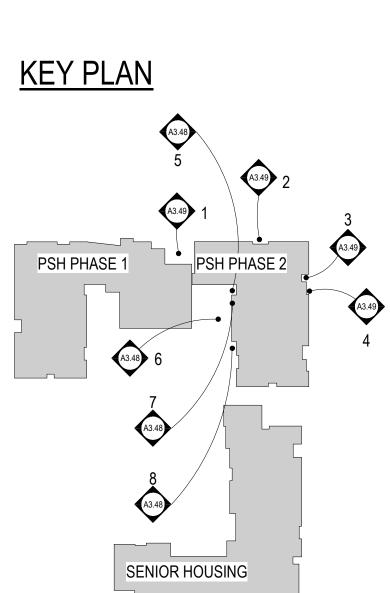

DRAWING TITLE

**ELEVATIONS** 

PSH 2 - BUILDING

PAUL M MCELWEE

C-28734 C-28734 C-CALIFOR

Author

Checker


08/22/22 50% CD SET

06/28/23 BID SET

3 03/01/23 PSH 2 Resubmittal 1

09/29/22 PERMIT SUBMITTAL

DESCRIPTION

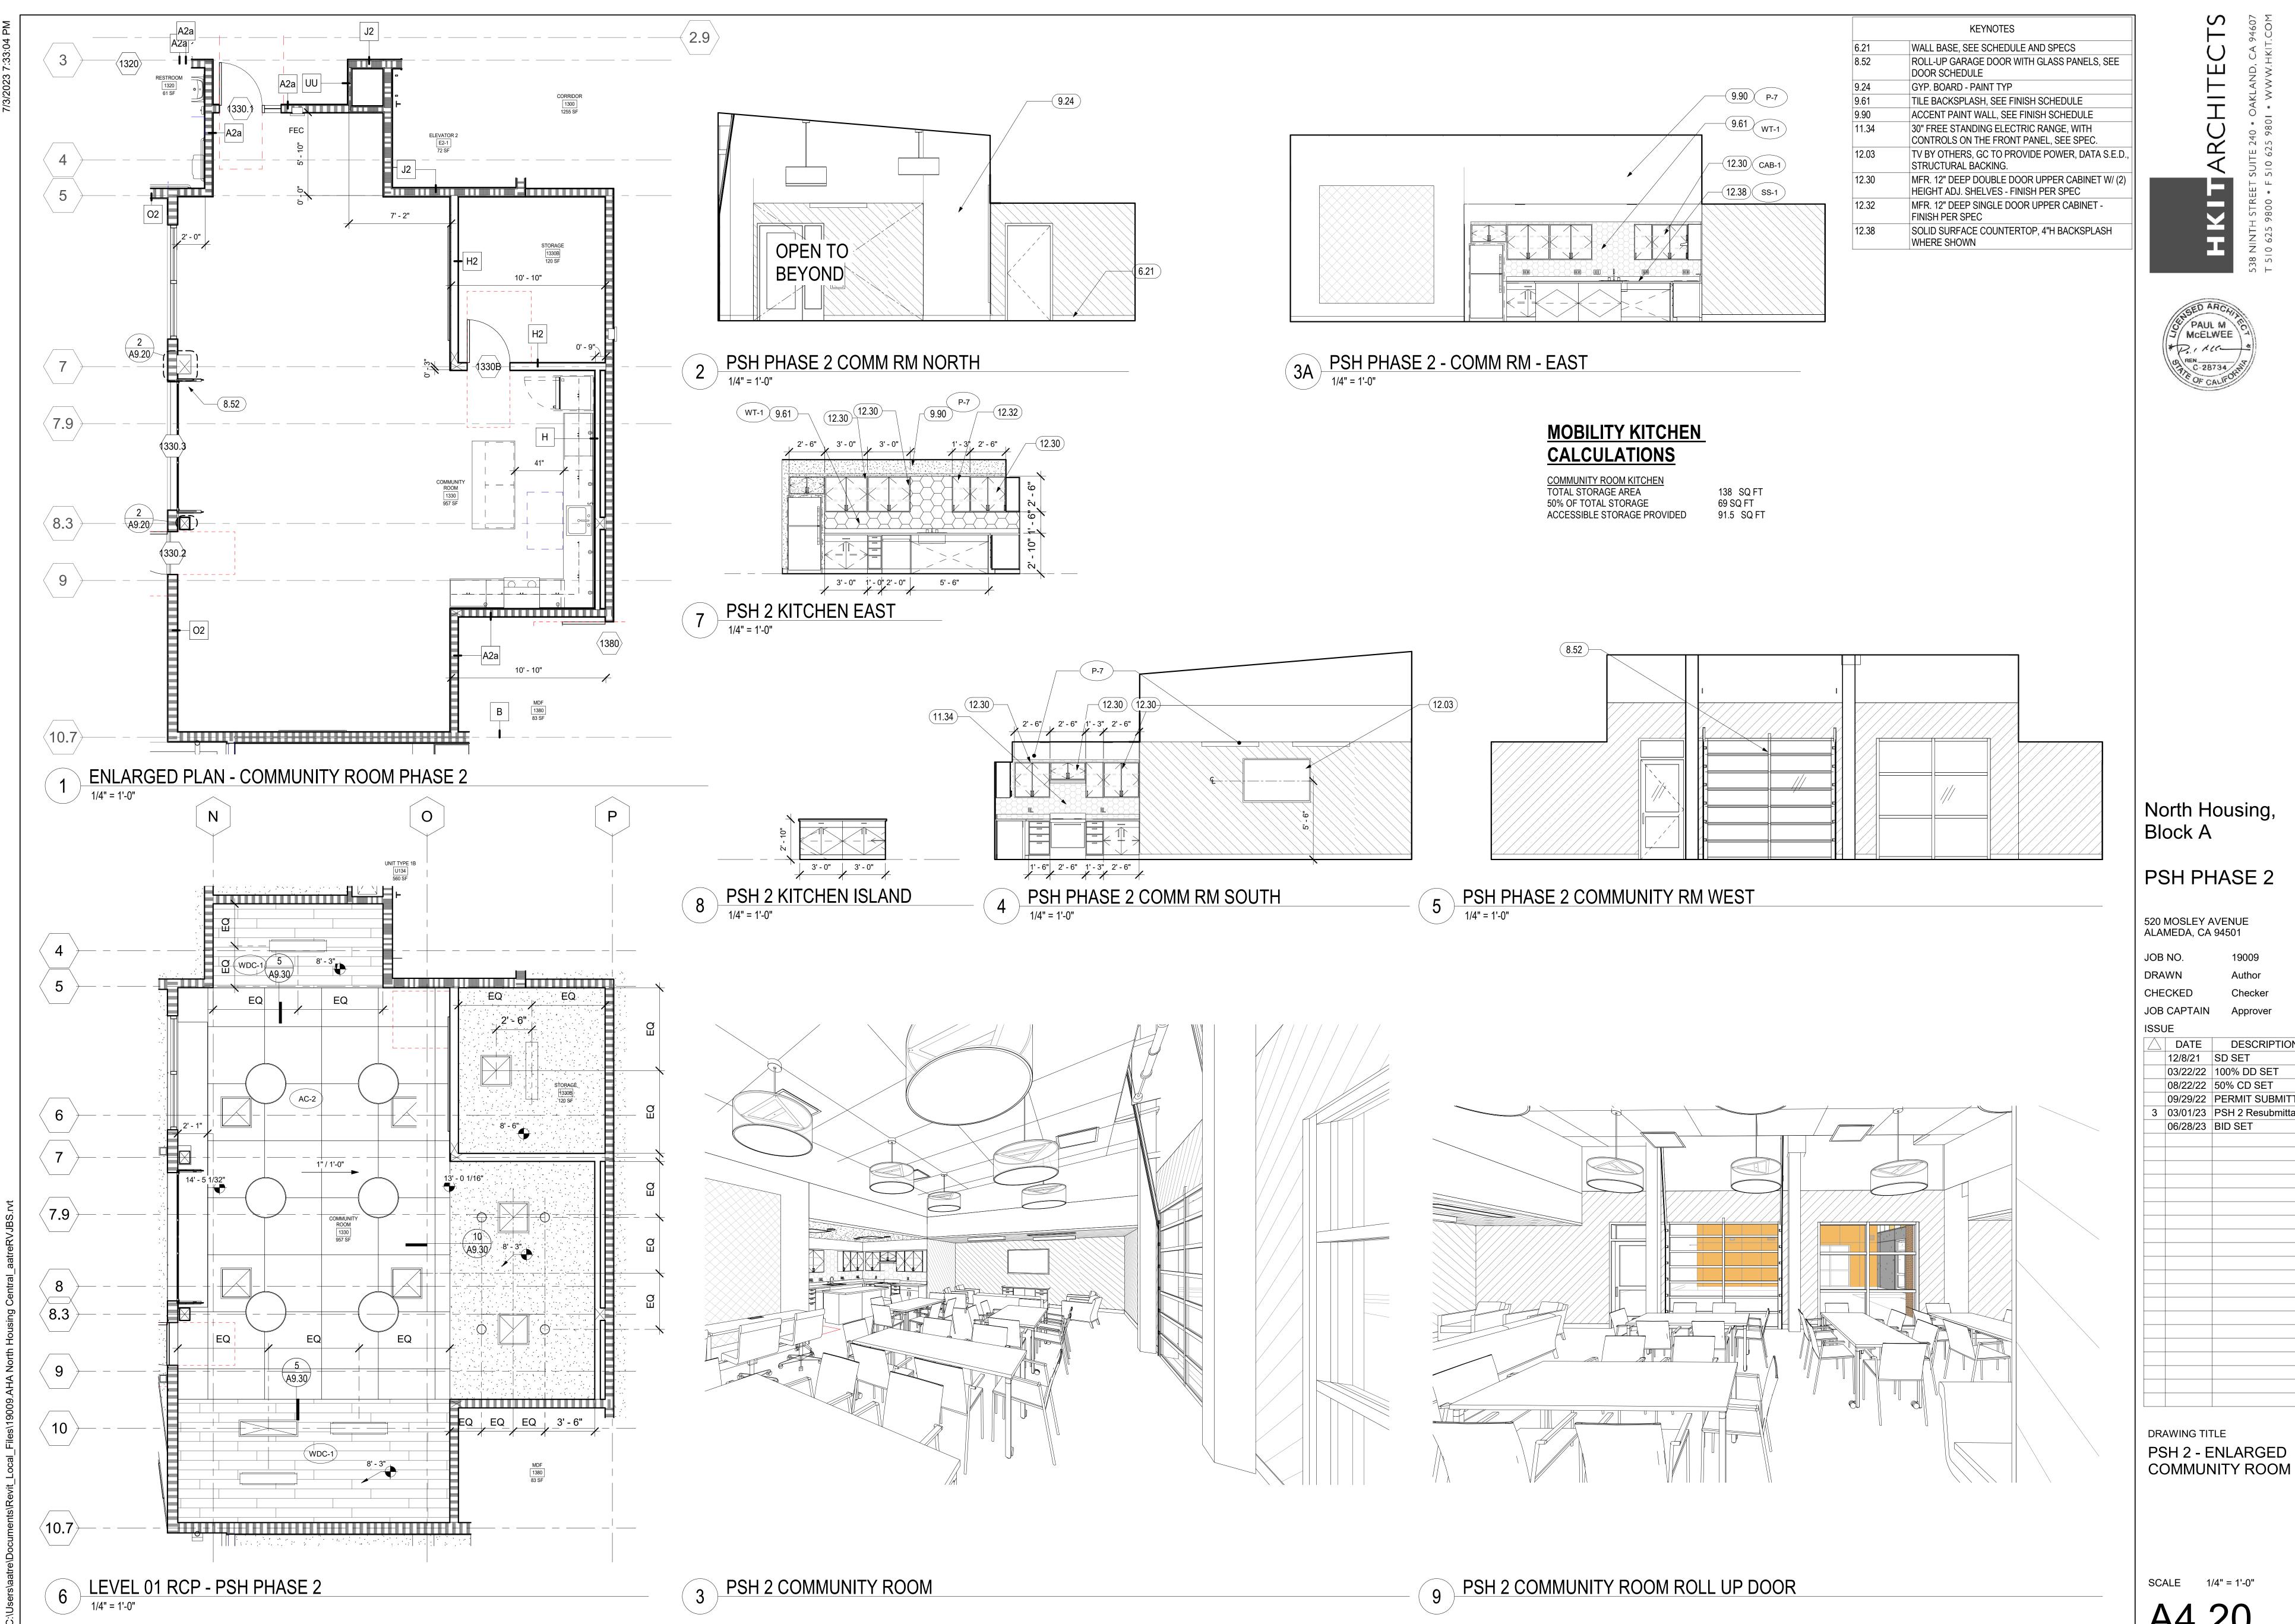



North Housing, Block A

PSH PHASE 2

520 MOSLEY AVENUE ALAMEDA, CA 94501

JOB NO. DRAWN

CHECKED JOB CAPTAIN


ISSUE DESCRIPTION

12/8/21 SD SET 03/22/22 100% DD SET 08/22/22 50% CD SET 09/29/22 PERMIT SUBMITTAL

3 03/01/23 PSH 2 Resubmittal 2 06/28/23 BID SET

DRAWING TITLE PSH 2 - ENLARGED

SCALE 1/4" = 1'-0"

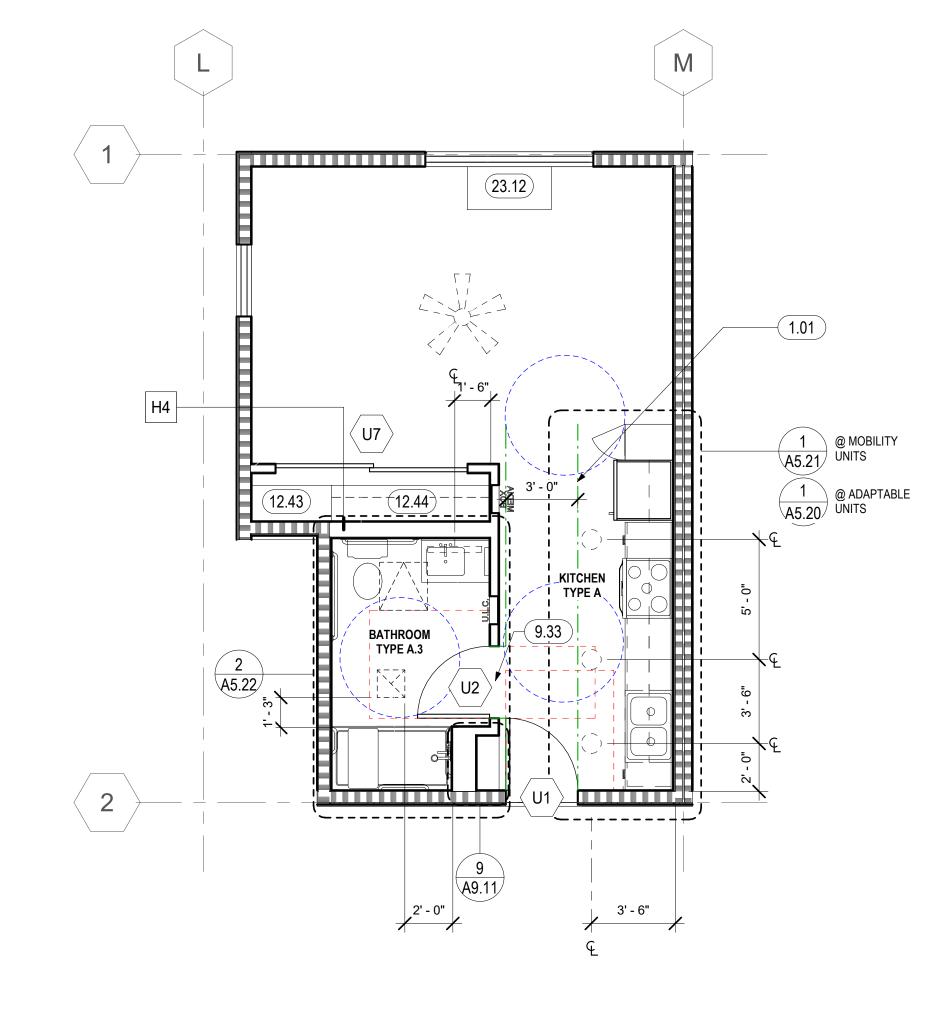


2 UNIT TYPE SB - MOBILITY, ADAPTABLE, & HVI


@ LEVELS 2-5


3 UNIT TYPE SC - MOBILITY & ADAPTABLE

# UNIT TYPE 1A - AT LEVEL 1

1 UNIT TYPE SA - MOBILITY, ADAPTABLE, & HVI

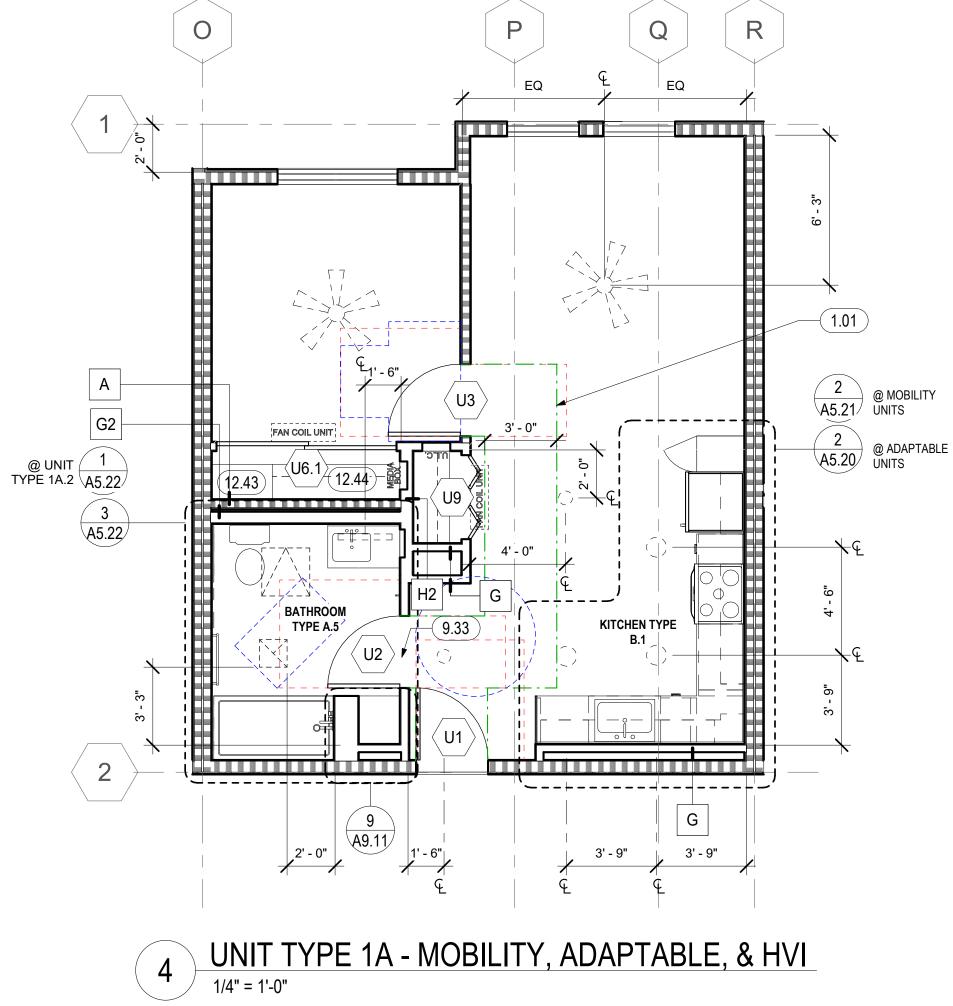

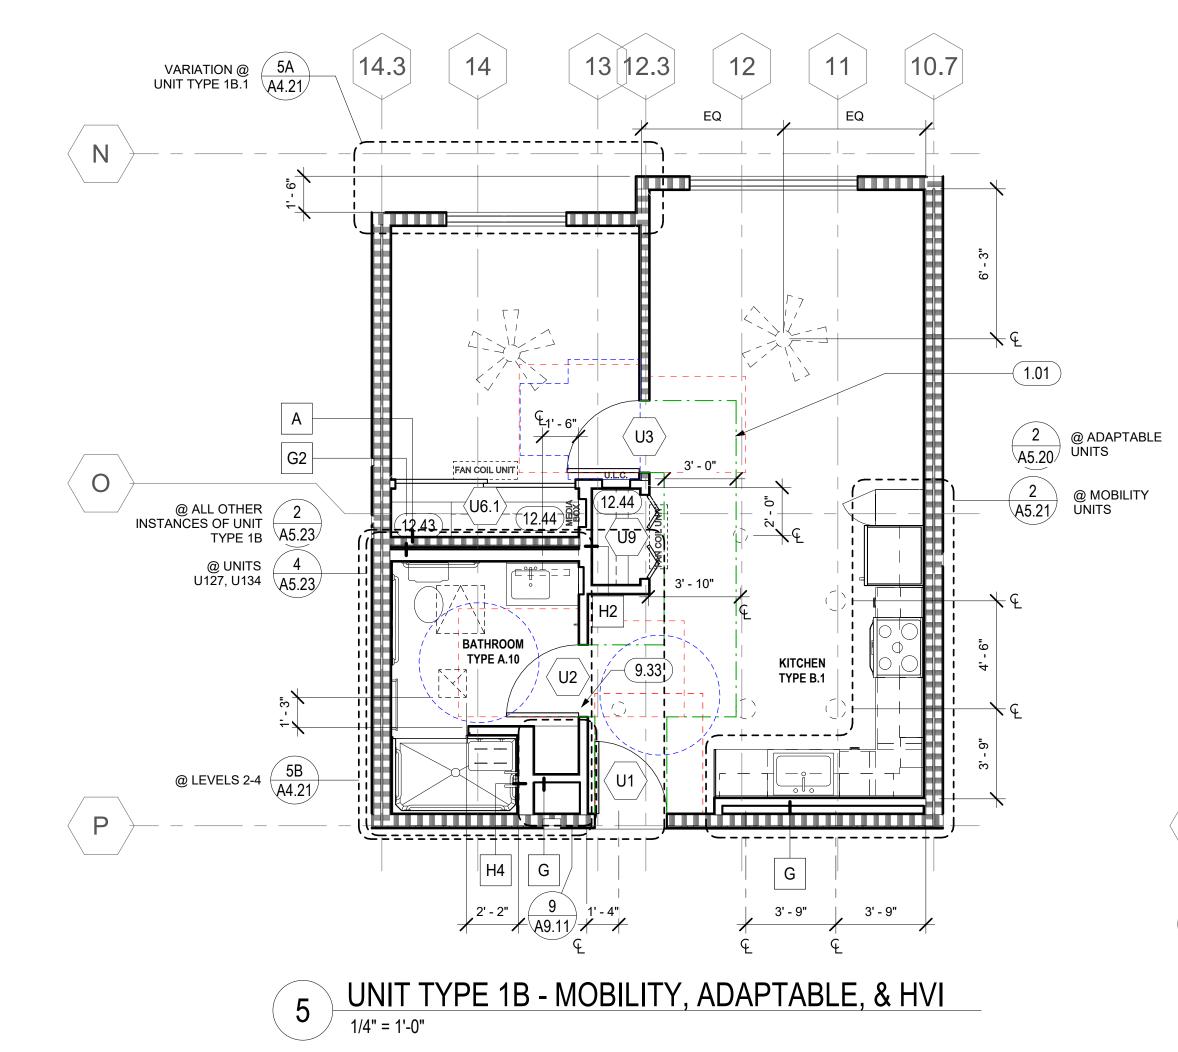

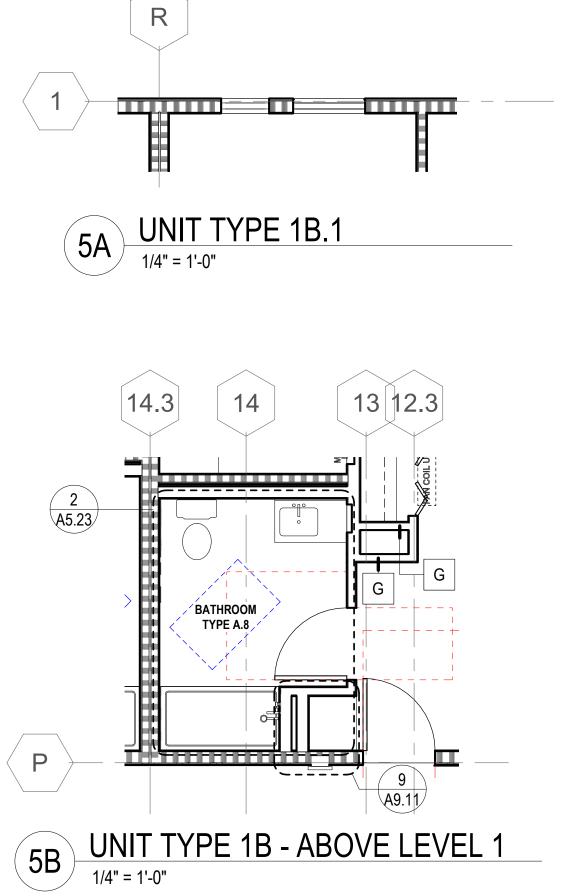

MIN. PULL F

**MOBILITY** DOOR CLEARANCE

T SHAPED **TURNING** SPACE

MOBILITY DOOR WITH CLOSER AND LATCH CLEARANCE

#### GENERAL NOTES - UNIT PLANS

- MULTIPLE VARIATIONS OF UNIT TYPES OCCUR. REFER TO 1/8" PLANS FOR EXACT CONFIGURATIONS AND DIMENSIONS.
- B. ALL WALLS TO BE TYPE "H" ON FLOORS 1-4 U.O.N. FOR ALL EXTERIOR, CORRDIOR, AND PARTY WALL INFORMATION, SEE OVERALL FLOOR PLANS.
- C. FOR INTERIOR FINISHES, SEE FINISH SCHEDULE.
- PROVIDE WINDOW BLINDS AND SCREENS AT ALL UNIT WINDOWS.
- FOR WINDOW TYPES, SEE 1/8" PLANS
- FOR HVAC, SEE MECHANICAL DRAWINGS
- G. FOR LOCATIONS OF MOBILITY & COMMUNICATION (HVI) UNITS SEE OVERALL PLANS AND UNIT SCHEDULE ON GENERAL SHEETS
- GENERAL CONTRACTOR SHALL CREATE AN ILLUSTRATIVE STEP BY STEP INSTRUCTION GUIDE FOR ADAPTING THE KITCHEN CABINETRY FOR WHEELCHAIR USERS. MOCK UP INSPECTION IS REQUIRED FOR REMOVABLE BASE CABINETS BEFORE INSTALLATION.
- CLEAR DIMENSIONS WITHIN UNIT ARE TO FINISH FACE OF WALL. DIMENSION AT DOOR JAMB 4" TYPICALLY & MINIMALLY.
- ALL CONTROLS/ SWITCHES SHALL BE LOCATED BETWEEN 15" & 48" ABOVE FINISH FLOOR PER CBC 1136A.2, SEE ELECTRICAL DRAWINGS.
- K. FOR DOOR CLEARANCES, SEE A9.90.
- FOR LIGHT FIXTURE INFORMATION SEE ELECTRICAL DRAWINGS. LIGHTING FIXTURES ARE TO BE CENTERED IN THE ROOM, U.O.N.
- PROVIDE A MEANS FOR VISUALLY IDENTIFYING A VISITOR WITHOUT OPENING THE UNIT ENTRY DOOR. PROVIDED SHALL ALLOW FOR A MINIMUM 180 DEGREE RANGE OF VIEW PER CBC 11B-809.5.5.2. AT LEASE ONE MEANS OF IDENTIFYING TO BE PROVIDED AT EACH UNIT.
- N. FOR UNIT KITCHEN P& BATHROOM PLANS SEE A5 SERIES SHEETS
- O. FAN COIL UNITS SHALL BE CENTERED ABOVE CLOSET DOORS U.O.N.

	KEYNOTES
1.01	ACCESSIBLE ROUTE THROUGH UNIT PER CBC 11B-809.2.1, APPLICABLE AT MOBILITY UNITS
9.33	FLOORING TRANSITION, SEE FINISH SCHEDULE
12.43	LINEN CLOSET, SEE 2/A9.61
12.44	CLOSET WITH WIRE SHELVING AND HANGER ROD, SEE 1/A9.61
23.12	WINDOW FRAME-INTEGRATED PTAC UNIT, SEE 4/8.40, S.M.D.

#### **ENLARGED UNIT PLAN LEGEND**

FOR ADDITIONAL ARCH. SYMBOLS, SEE SHEET G0.2

NON-RATED WALL 1 HOUR FIRE-RATED ASSEMBLY 2 HOUR FIRE-RATED ASSEMBLY

> WINDOW / LOUVER TAG WALL TAG

DOOR TAG


MEDIA BOX, SED UNIT LOAD CENTER, SED

FAN COIL UNIT, SMD FAN/LIGHT COMBO, SED

UNIT LIGHT FIXTURES, SED

VANITY LIGHT, SED EXHAUST FAN W/ LIGHT, SED, SMD

FAN, S.M.D., VERIFY LOCATION IN FIELD 60" DIA. ACCESSIBLE

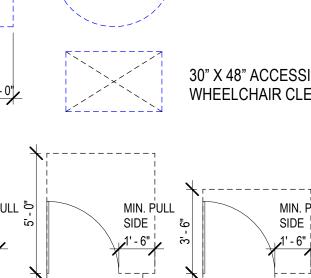

ADAPTABLE UNIT DOOR CLEARANCE

CEILING ACCESS PANEL, LOCATE BELOW CEILING SUPPLY

WHEELCHAIR TURNING RADIUS

DRAWING TITLE

**UNIT PLANS** 

PSH 2 - ENLARGED

PAUL M MCELWEE

North Housing,

PSH PHASE 2

12/8/21 SD SET

06/28/23 BID SET

03/22/22 100% DD SET

08/22/22 | 50% CD SET

3 | 03/01/23 | PSH 2 Resubmittal 1

09/29/22 PERMIT SUBMITTAL

**Author** 

Checker

Approver

DESCRIPTION

520 MOSLEY AVENUE ALAMEDA, CA 94501

JOB NO.

DRAWN


**ISSUE** 

CHECKED


JOB CAPTAIN


Block A


SCALE 1/4" = 1'-0"

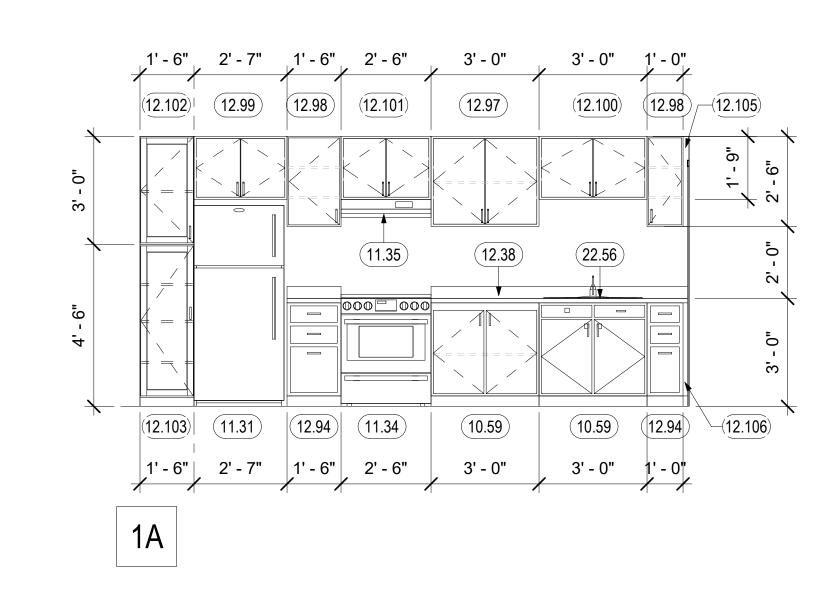

# 1 KITCHEN TYPE A 3/8" = 1'-0"

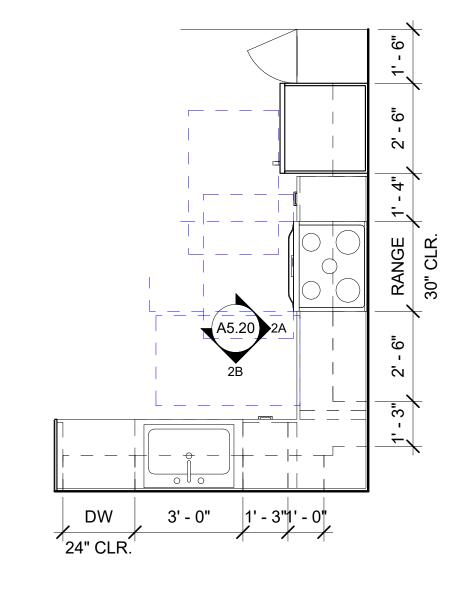

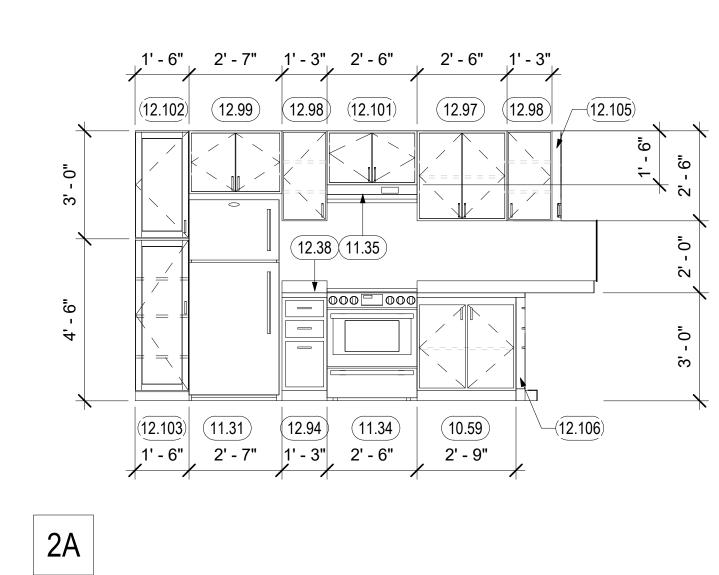

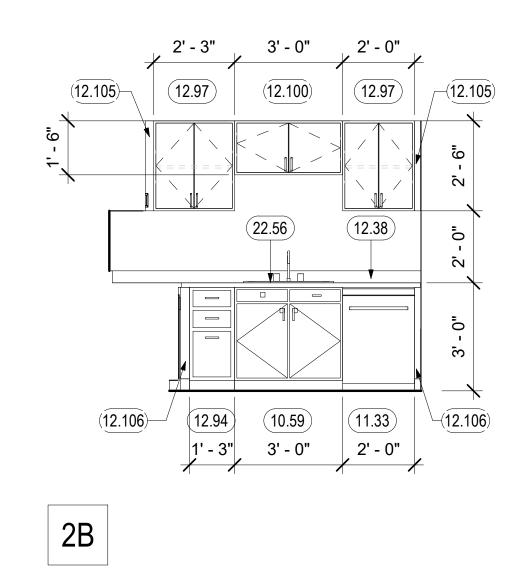

2 KITCHEN TYPE B.1
3/8" = 1'-0"

#### **GENERAL NOTES - ENLARGED KITCHEN PLANS & INTERIOR ELEVATIONS**

A. PROVIDE MOLD-RESISTANT GYP BOARD WHERE SHADED. EXTEND TO CABINET SIDE OF ADJACENT KITCHEN WING-WALLS NOT DEPICTED HERE.

B. KITCHEN BASE CABINETS TO BE 23" DEEP TYPICAL. DISTANCE COUNTERTOP BULL NOSE TO WALL 24" MAX.

C. AT MOBILITY UNITS OUTLETS AND SWITCHES IN EACH KITCHEN COUNTER OR LAVATORY AREA WILL BE REACHABLE AT FORWARD OR PARALLEL APPROACH. ALL OUTLETS LOCATED IN COUNTERTOPS WILL BE PLACED SO THAT A REACH OF 24" MAXIMUM IS PROVIDED, MEASURED FROM THE FACE OF THE COUNTERTOP OR FACE OF APPLIANCE TO FACE OF THE OUTLET. PROVIDE DUPLICATE OUTLETS WITHIN REACH (SUCH AS ON THE CASEWORK ON THE CABINET BELOW) IF NEW OUTLET PLACEMENT REQUIRED BY NEC IS INACCESSIBLE. ÉLECTRICAL CONTRACTOR TO COORDINATE WITH AGENCY HAVING JURISDICTION.

D. PROVIDE SOLID WOOD PANEL FINISHED TO MATCH CABINETS FACING ANY APPLIANCE. SEE ELEVATIONS FOR APPLIANCE LOCATIONS.

E. AT WALL MOUNTED ITEMS, PROVIDE WALL BLOCKING PER

F. RUBBER BASE (B-1) OCCURS UNDER BASE CABINETS IN TOE KICK AND AT ANY WALLS IN ANY ACCESSIBLE OR OPEN AREAS IN KITCHEN.

G. LOCATE ELECTRICAL OUTLETS AT CORNERS IN L-SHAPED KITCHENS REQUIRED DISTANCE FROM CORNER. SEE

59	REMOVABLE BASE CABINET TO ALLOW 30" WIDE CLEAR FORWARD APPROACH, CABINET TO BE REMOVABLE WITHOUT SPECIAL TOOLS OR KNOWLEDGE. CONTINUE FLOORING, BASE, AND WALL FINISHES BELOW
31	REFRIGERATOR, SEE SPEC. CONTINUE FLOORING AND WALL BASE INTO APPLIANCE SPACE.
33	24" DISHWASHER, SEE SPEC
34	30" FREE STANDING ELECTRIC RANGE, WITH CONTROLS ON THE FRONT PANEL, SEE SPEC.
35	RANGE EXHAUST HOOD. PROVIDE WALL SWITCH FOR FAN AND LIGHT AT DISABLED ACCESSIBLE HEIGHT AT MOBILITY UNITS. CONTROLS ON FRONT PANEL.
38	SOLID SURFACE COUNTERTOP, 4"H BACKSPLASH WHERE SHOWN
94	WOOD BASE CABINET WITH 3 DRAWERS
97	UPPER CABINET WITH (1) ADJUSTABLE SHELVES
98	UPPER CABINET WITH (2) ADJUSTABLE SHELVES


KEYNOTES

#### 12.98 UPPER CABINET WITH (2) ADJUSTABLE SHELVES 12.99 UPPER CABINET OVER REFRIGERATOR 12.100 UPPER CABINET OVER SINK 12.101 UPPER CABINET OVER HOOD 12.102 LOCKING PANTRY CABINET 12.103 PANTRY CABINET WITH 3 SHELVES 12.105 UPPER FILL PANEL 12.106 LOWER FILL PANEL 22.56 KITCHEN SINK, S.P.D

#### **ENLARGED KITCHEN PLAN LEGEND**

FOR ADDITIONAL ARCH. SYMBOLS, SEE G0.01

60" TURNING CIRCLE

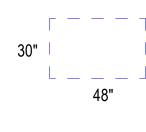

30" X 48" ACCESSIBLE WHEELCHAIR CLEARANCE

\_\_\_30"\_\_ WS

30" WORK SURFACE NON - ACCESSIBLE STORAGE

ACCESSIBLE STORAGE

North Housing, Block A

PAUL M MCELWEE

PSH PHASE 2


520 MOSLEY AVENUE ALAMEDA, CA 94501

JOB NO. Author DRAWN CHECKED Checker JOB CAPTAIN Approver


ISSUE DATE


DESCRIPTION 12/8/21 SD SET 03/22/22 100% DD SET 08/22/22 | 50% CD SET 09/29/22 PERMIT SUBMITTAL 3 03/01/23 PSH 2 Resubmittal 1 06/28/23 BID SET


DRAWING TITLE PSH 2 - ENLARGED KITCHEN PLANS & **ELEVATIONS** 

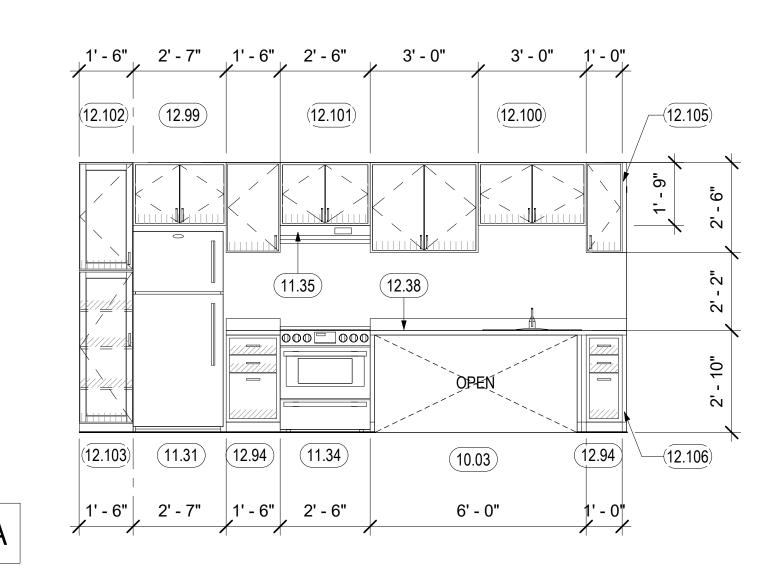

1 KITCHEN TYPE A - MOBILITY **3/8" = 1'-0"** 

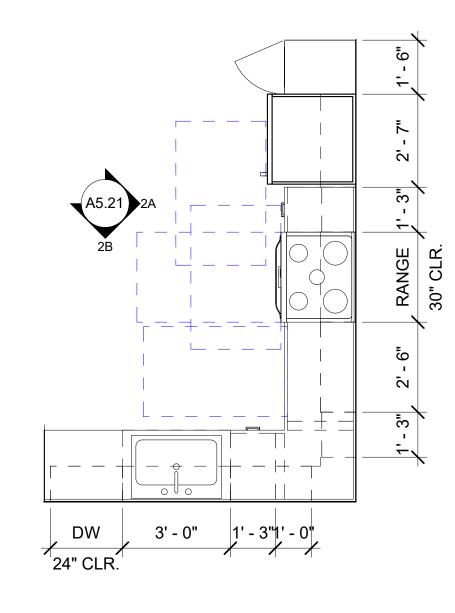

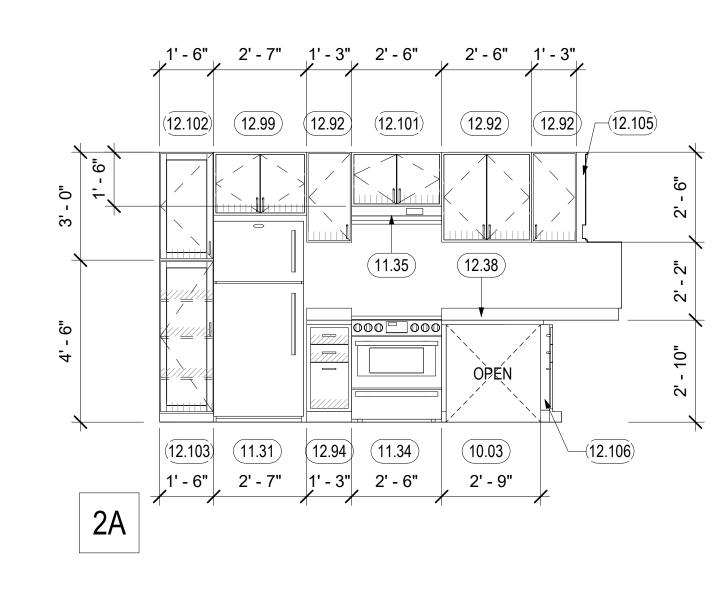

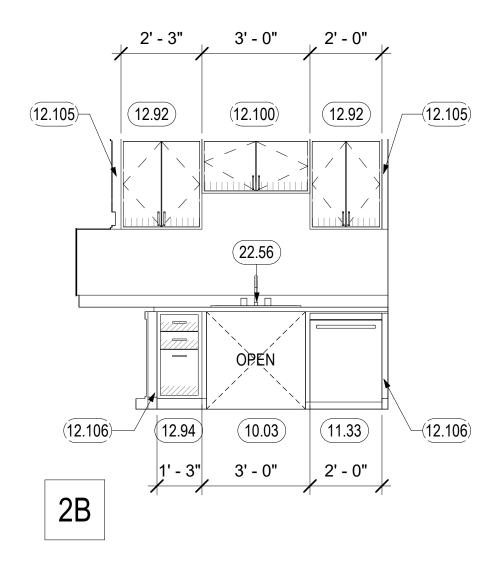

KITCHEN TYPE B.1 - MOBILITY **3/8" = 1'-0"** 

**GENERAL NOTES - ENLARGED KITCHEN PLANS & INTERIOR ELEVATIONS** 

A. PROVIDE MOLD-RESISTANT GYP BOARD WHERE SHADED. EXTEND TO CABINET SIDE OF ADJACENT KITCHEN WING-WALLS NOT DEPICTED HERE.

B. KITCHEN BASE CABINETS TO BE 23" DEEP TYPICAL. DISTANCE COUNTERTOP BULL NOSE TO WALL 24" MAX.

C. AT MOBILITY UNITS OUTLETS AND SWITCHES IN EACH KITCHEN COUNTER OR LAVATORY AREA WILL BE REACHABLE AT FORWARD OR PARALLEL APPROACH. ALL OUTLETS LOCATED IN COUNTERTOPS WILL BE PLACED SO THAT A REACH OF 24" MAXIMUM IS PROVIDED, MEASURED FROM THE FACE OF THE COUNTERTOP OR FACE OF APPLIANCE TO FACE OF THE OUTLET. PROVIDE DUPLICATE OUTLETS WITHIN REACH (SUCH AS ON THE CASEWORK ON THE CABINET BELOW) IF NEW OUTLET PLACEMENT REQUIRED BY NEC IS INACCESSIBLE. ELECTRICAL CONTRACTOR TO COORDINATE WITH AGENCY HAVING JURISDICTION.

D. PROVIDE SOLID WOOD PANEL FINISHED TO MATCH CABINETS FACING ANY APPLIANCE. SEE ELEVATIONS FOR APPLIANCE LOCATIONS.

E. AT WALL MOUNTED ITEMS, PROVIDE WALL BLOCKING PER

F. RUBBER BASE (B-1) OCCURS UNDER BASE CABINETS IN TOE KICK AND AT ANY WALLS IN ANY ACCESSIBLE OR OPEN AREAS IN KITCHEN.

G. LOCATE ELECTRICAL OUTLETS AT CORNERS IN L-SHAPED KITCHENS REQUIRED DISTANCE FROM CORNER. SEE

KEYNOTES 10.03 CLEAR KNEE SPACE INSIDE (SINK BOX) CABINET, PROVIDE PLYWOOD APRON/PIPE INSULATION. FACES TO BE SOLID WOOD PANEL FINISH TO MATCH CABINETS, SEE DETAIL 26/A9.60 11.31 REFRIGERATOR, SEE SPEC. CONTINUE FLOORING AND WALL BASE INTO APPLIANCE SPACE. 11.33 24" DISHWASHER, SEE SPEC 11.34 30" FREE STANDING ELECTRIC RANGE, WITH CONTROLS ON THE FRONT PANEL, SEE SPEC. 11.35 RANGE EXHAUST HOOD. PROVIDE WALL SWITCH FOR FAN AND LIGHT AT DISABLED ACCESSIBLE HEIGHT AT MOBILITY UNITS. CONTROLS ON FRONT 12.38 | SOLID SURFACE COUNTERTOP, 4"H BACKSPLASH WHERE SHOWN 12.92 UPPER CABINET WITH (0) ADJUSTABLE SHELVES 12.94 WOOD BASE CABINET WITH 3 DRAWERS 12.99 UPPER CABINET OVER REFRIGERATOR 12.100 UPPER CABINET OVER SINK 12.101 UPPER CABINET OVER HOOD 12.102 LOCKING PANTRY CABINET 12.103 PANTRY CABINET WITH 3 SHELVES 12.105 UPPER FILL PANEL 12.106 LOWER FILL PANEL

#### **MOBILITY KITCHEN CALCULATIONS**

KITCHEN TYPE A, 11B MOBILITY TOTAL STORAGE AREA 46.08 SQ FT 23.04 SQ FT 50% OF TOTAL STORAGE ACCESSIBLE STORAGE PROVIDED 24 SQ FT KITCHEN TYPE B.1, 11B MOBILITY TOTAL STORAGE AREA 47.33 SQ FT

#### **ENLARGED KITCHEN PLAN LEGEND**

23.67 SQ FT 24 SQ FT


50% OF TOTAL STORAGE

ACCESSIBLE STORAGE PROVIDED

FOR ADDITIONAL ARCH. SYMBOLS, SEE G0.01

22.56 KITCHEN SINK, S.P.D

60" TURNING CIRCLE

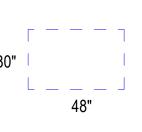

30" X 48" ACCESSIBLE WHEELCHAIR CLEARANCE



30" WORK SURFACE

ACCESSIBLE STORAGE



NON - ACCESSIBLE STORAGE

North Housing,

PAUL M MCELWEE

PSH PHASE 2

Block A


520 MOSLEY AVENUE ALAMEDA, CA 94501

19009 JOB NO. Author DRAWN Checker CHECKED

JOB CAPTAIN

Approver ISSUE DESCRIPTION DATE 08/22/22 50% CD SET 09/29/22 PERMIT SUBMITTAL 3 03/01/23 PSH 2 Resubmittal 1 06/28/23 BID SET

DRAWING TITLE PSH 2 - ENLARGED MOBILITY KITCHEN PLANS & ELEVATIONS

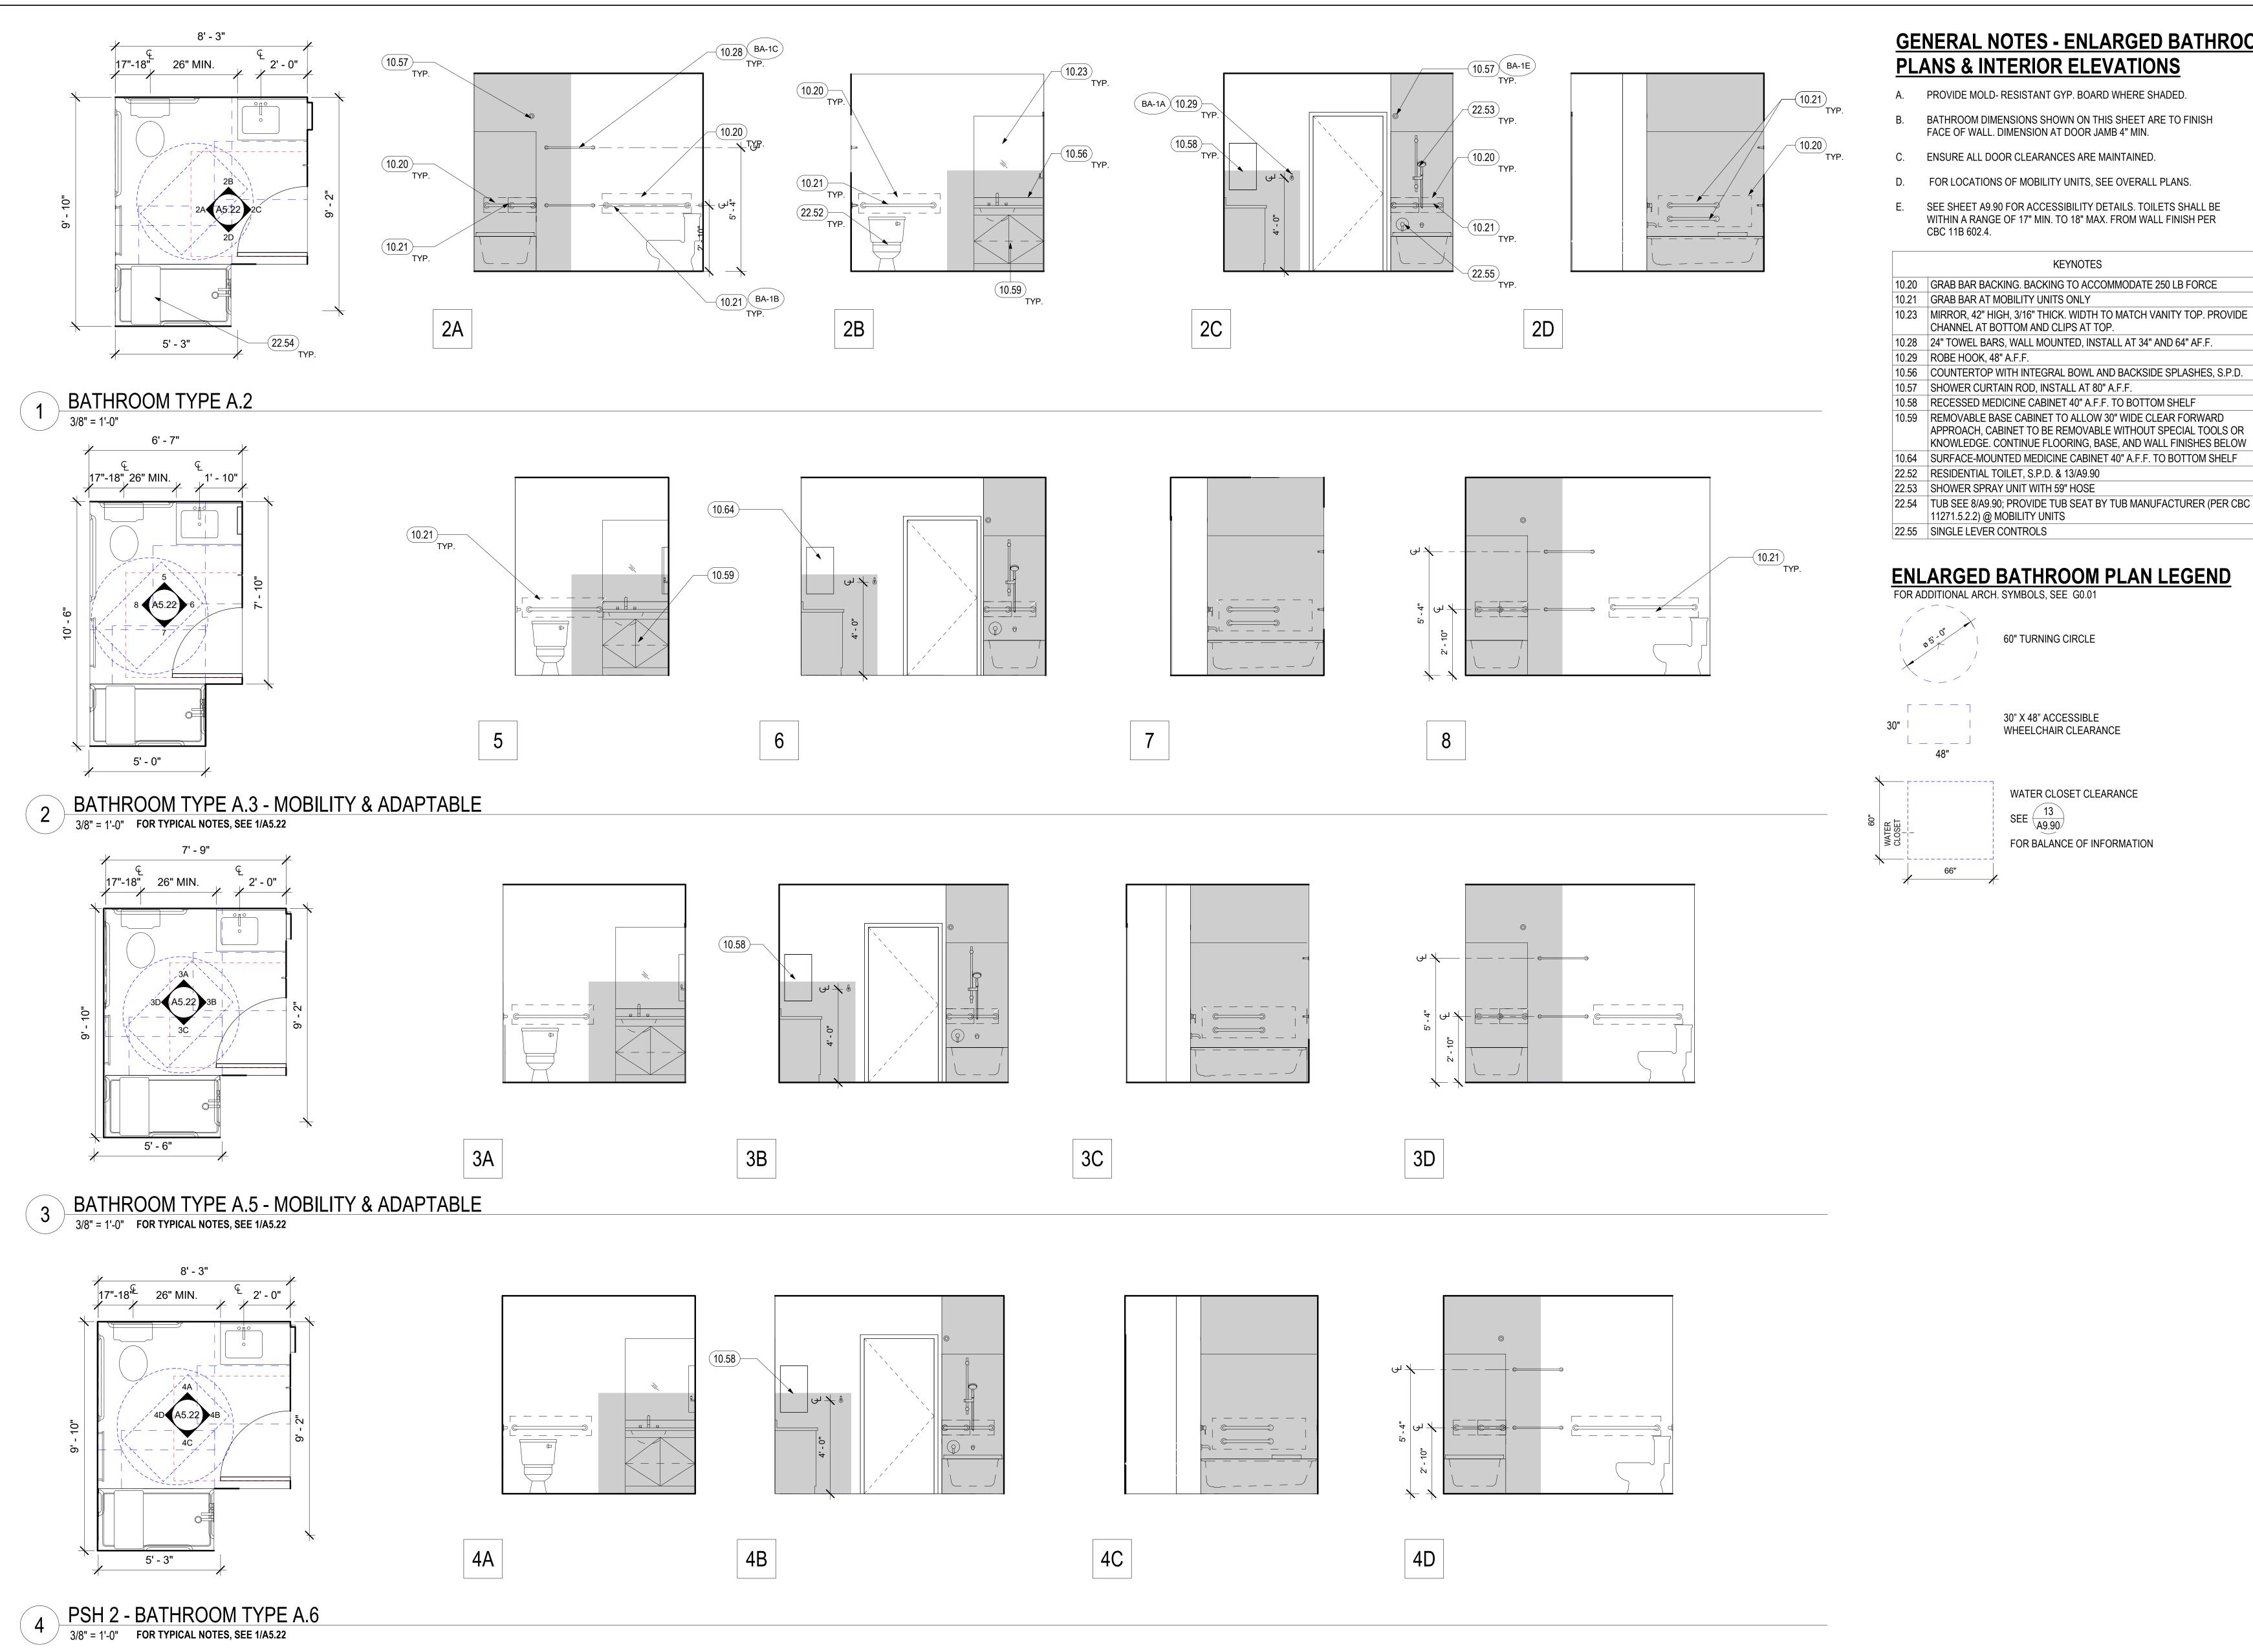

#### **GENERAL NOTES - ENLARGED BATHROOM PLANS & INTERIOR ELEVATIONS**


- PROVIDE MOLD- RESISTANT GYP. BOARD WHERE SHADED.
- BATHROOM DIMENSIONS SHOWN ON THIS SHEET ARE TO FINISH FACE OF WALL. DIMENSION AT DOOR JAMB 4" MIN.
- ENSURE ALL DOOR CLEARANCES ARE MAINTAINED.
- FOR LOCATIONS OF MOBILITY UNITS, SEE OVERALL PLANS.
- SEE SHEET A9.90 FOR ACCESSIBILITY DETAILS. TOILETS SHALL BE WITHIN A RANGE OF 17" MIN. TO 18" MAX. FROM WALL FINISH PER

KEYNOTES

#### 10.20 GRAB BAR BACKING. BACKING TO ACCOMMODATE 250 LB FORCE 10.23 MIRROR, 42" HIGH, 3/16" THICK. WIDTH TO MATCH VANITY TOP. PROVIDE PAUL M MCELWEE 10.28 24" TOWEL BARS, WALL MOUNTED, INSTALL AT 34" AND 64" AF.F. 10.56 COUNTERTOP WITH INTEGRAL BOWL AND BACKSIDE SPLASHES, S.P.D.

#### **ENLARGED BATHROOM PLAN LEGEND**

FOR ADDITIONAL ARCH. SYMBOLS, SEE G0.01

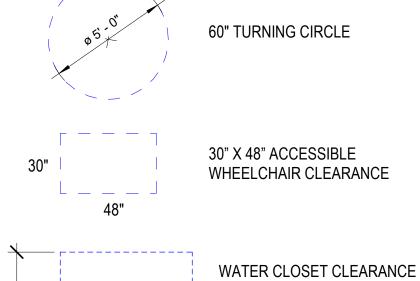

FOR BALANCE OF INFORMATION

North Housing, Block A

PSH PHASE 2

520 MOSLEY AVENUE ALAMEDA, CA 94501

JOB NO. DRAWN CHECKED JOB CAPTAIN

ISSUE

-	0002			
$\triangle$	DATE	DESCRIPTION		
	12/8/21	SD SET		
	03/22/22	100% DD SET		
	08/22/22	50% CD SET		
	09/29/22	PERMIT SUBMITTAL		
3	03/01/23	PSH 2 Resubmittal 1		
	06/28/23	BID SET		

DRAWING TITLE PSH 2 - ENLARGED BATHROOM PLANS & **ELEVATIONS** 


(22.55)

BATHROOM TYPE A.7 - MOBILITY & ADAPTABLE
3/8" = 1'-0"


10.59


17"-18" 26" MIN. 5' - 0"

5' - 0"

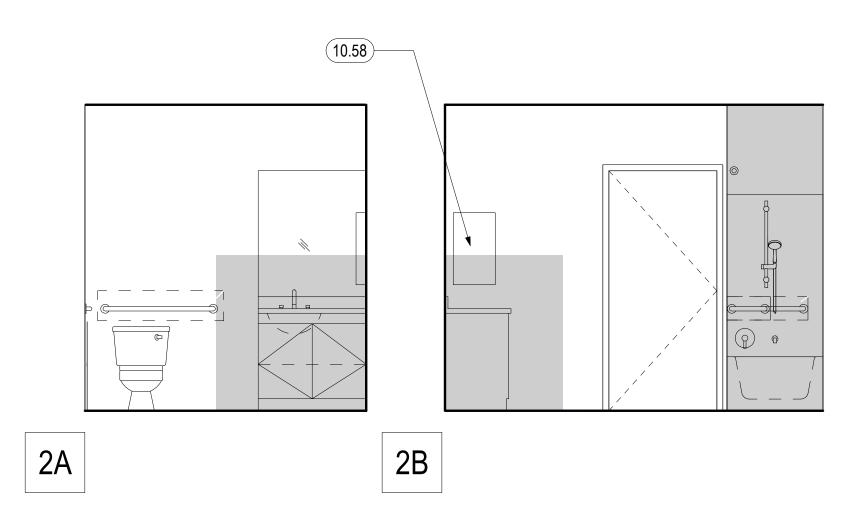

22.52

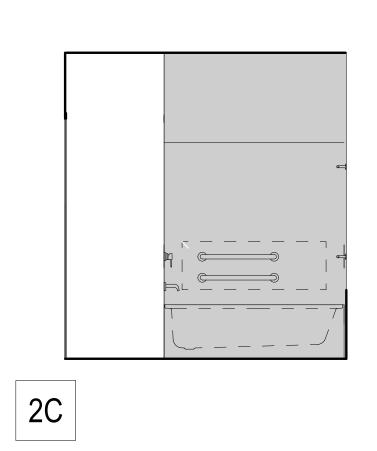


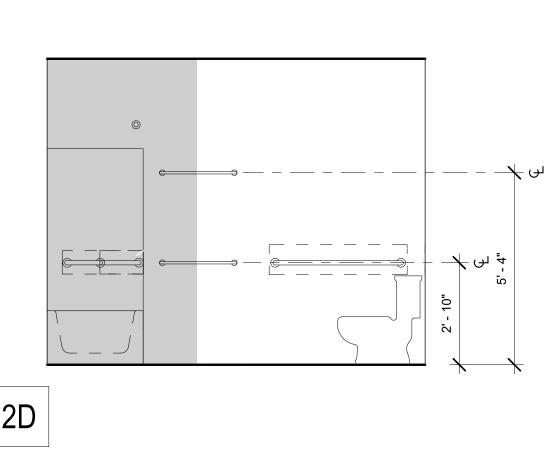


BATHROOM TYPE A.8 - MOBILITY & ADAPTABLE


3/8" = 1'-0" **FOR TYPICAL NOTES, SEE 1/A5.23** 

6' - 7"

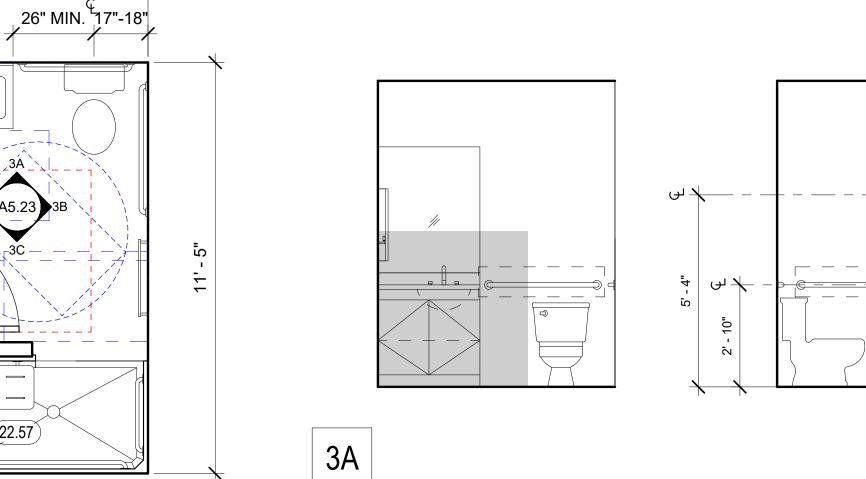

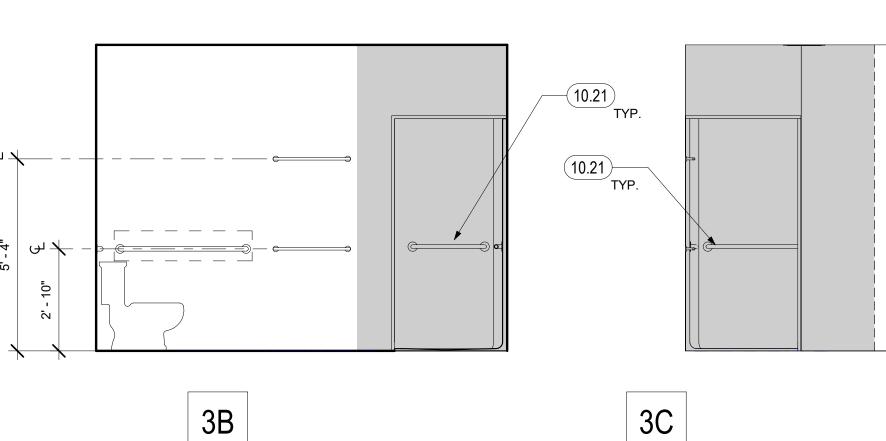


-(10.28) TYP.

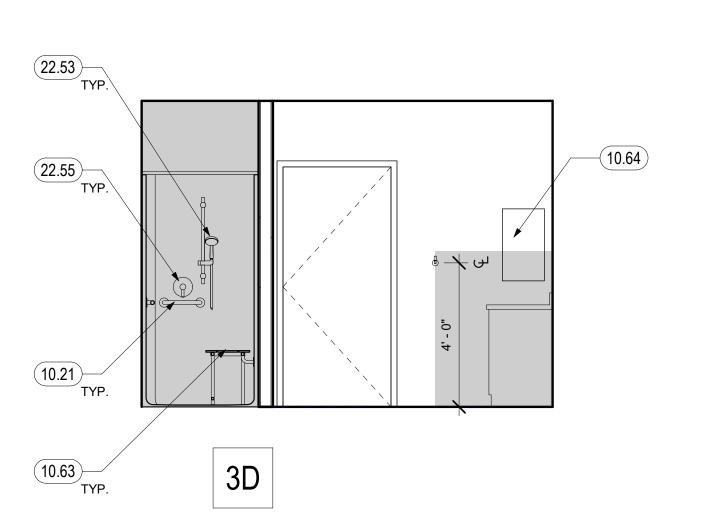

BATHROOM TYPE A.9 - MOBILITY 3/8" = 1'-0" FOR TYPICAL NOTES, SEE 1/A5.23

(22.57)

5' - 3"

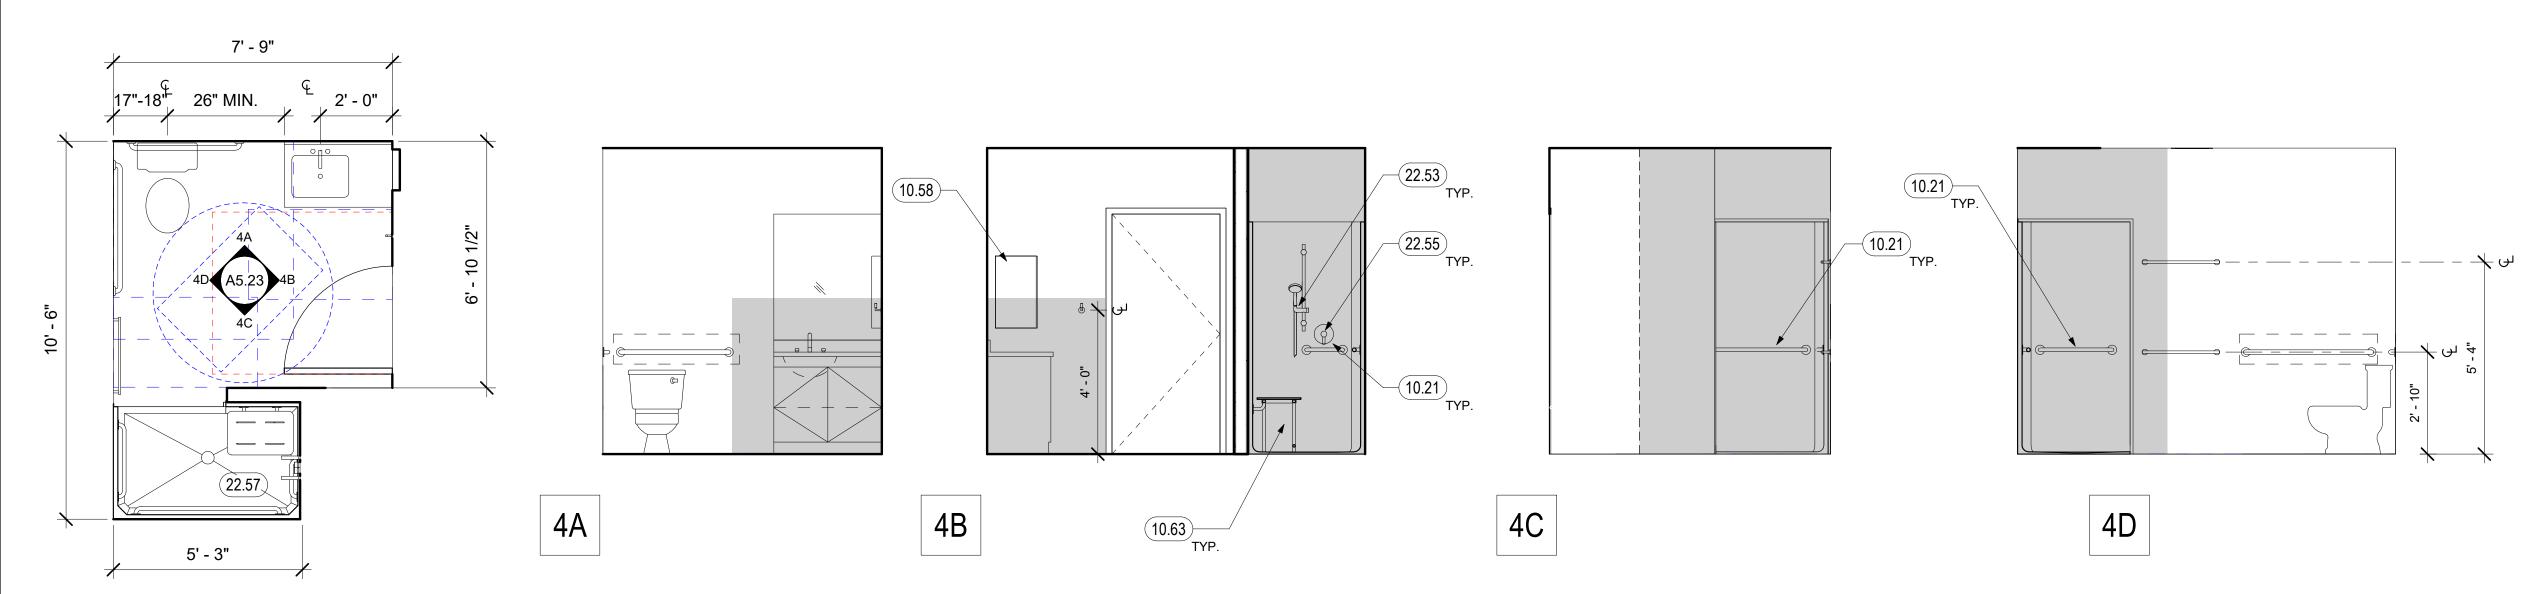

BATHROOM TYPE A.10 - MOBILITY

**GENERAL NOTES - ENLARGED BATHROOM PLANS & INTERIOR ELEVATIONS** 

- PROVIDE MOLD- RESISTANT GYP. BOARD WHERE SHADED.
- BATHROOM DIMENSIONS SHOWN ON THIS SHEET ARE TO FINISH FACE OF WALL. DIMENSION AT DOOR JAMB 4" MIN.
- ENSURE ALL DOOR CLEARANCES ARE MAINTAINED.

- FOR LOCATIONS OF MOBILITY UNITS, SEE OVERALL PLANS.
- SEE SHEET A9.90 FOR ACCESSIBILITY DETAILS. TOILETS SHALL BE WITHIN A RANGE OF 17" MIN. TO 18" MAX. FROM WALL FINISH PER CBC 11B 602.4.

	KEYNOTES	
10.20	GRAB BAR BACKING. BACKING TO ACCOMMODATE 250 LB FORCE	
10.21	GRAB BAR AT MOBILITY UNITS ONLY	GED ARCA
10.23	MIRROR, 42" HIGH, 3/16" THICK. WIDTH TO MATCH VANITY TOP. PROVIDE CHANNEL AT BOTTOM AND CLIPS AT TOP.	PAUL M MCELWEE
10.28	24" TOWEL BARS, WALL MOUNTED, INSTALL AT 34" AND 64" AF.F.	* D. 16
10.29	ROBE HOOK, 48" A.F.F.	No REN
10.56	COUNTERTOP WITH INTEGRAL BOWL AND BACKSIDE SPLASHES, S.P.D.	G-28734

REMOVABLE BASE CABINET TO ALLOW 30" WIDE CLEAR FORWARD APPROACH, CABINET TO BE REMOVABLE WITHOUT SPECIAL TOOLS OR KNOWLEDGE. CONTINUE FLOORING, BASE, AND WALL FINISHES BELOW 10.63 22" X 16" FOLD DOWN SEAT WITH SWING DOWN LEGS SURFACE-MOUNTED MEDICINE CABINET 40" A.F.F. TO BOTTOM SHELF 22.52 RESIDENTIAL TOILET, S.P.D. & 13/A9.90

RECESSED MEDICINE CABINET 40" A.F.F. TO BOTTOM SHELF

SHOWER CURTAIN ROD, INSTALL AT 80" A.F.F.

22.53 SHOWER SPRAY UNIT WITH 59" HOSE 22.54 TUB SEE 8/A9.90; PROVIDE TUB SEAT BY TUB MANUFACTURER (PER CBC 11271.5.2.2) @ MOBILITY UNITS

22.55 SINGLE LEVER CONTROLS 22.57 ROLL IN SHOWER, 7/A9.90, S.P.D.

#### **ENLARGED BATHROOM PLAN LEGEND** FOR ADDITIONAL ARCH. SYMBOLS, SEE G0.01

60" TURNING CIRCLE

30" X 48" ACCESSIBLE WHEELCHAIR CLEARANCE

WATER CLOSET CLEARANCE

North Housing, Block A FOR BALANCE OF INFORMATION

PSH PHASE 2

520 MOSLEY AVENUE ALAMEDA, CA 94501

JOB NO. DRAWN Author CHECKED Checker JOB CAPTAIN

ISSUE

DESCRIPTION 08/22/22 50% CD SET 09/29/22 PERMIT SUBMITTAL 3 03/01/23 PSH 2 Resubmittal 1 06/28/23 BID SET

DRAWING TITLE PSH 2 - ENLARGED BATHROOM PLANS & **ELEVATIONS** 


PSH 2 - RESTROOM COMMUNITY ROOM


#### **GENERAL NOTES - ENLARGED BATHROOM PLANS & INTERIOR ELEVATIONS**

- A. PROVIDE MOLD- RESISTANT GYP. BOARD WHERE SHADED.
- BATHROOM DIMENSIONS SHOWN ON THIS SHEET ARE TO FINISH FACE OF WALL. DIMENSION AT DOOR JAMB 4" MIN.
- C. ENSURE ALL DOOR CLEARANCES ARE MAINTAINED.
- FOR LOCATIONS OF MOBILITY UNITS, SEE OVERALL PLANS.
- SEE SHEET A9.90 FOR ACCESSIBILITY DETAILS. TOILETS SHALL BE WITHIN A RANGE OF 17" MIN. TO 18" MAX. FROM WALL FINISH PER CBC 11B 602.4.

KEYNOTES 10.20 GRAB BAR BACKING. BACKING TO ACCOMMODATE 250 LB FORCE 22.04 WALL-HUNG SINK AND FAUCET, ACCESSIBLE, S.P.D. SEE 17/A9.90 22.06 TOILET; S.P.D. & 12/A9.90 & 14/A9.90

#### **ENLARGED BATHROOM PLAN LEGEND** FOR ADDITIONAL ARCH. SYMBOLS, SEE G0.01

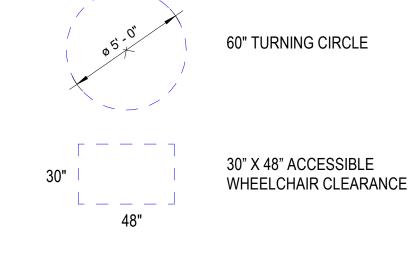

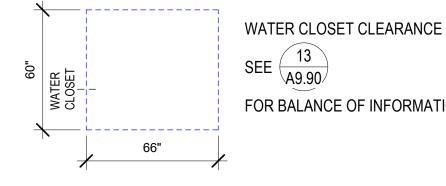

FOR BALANCE OF INFORMATION



#### North Housing, Block A

#### PSH PHASE 2

520 MOSLEY AVENUE ALAMEDA, CA 94501

ISSUE

JOB NO. DRAWN Author CHECKED Checker JOB CAPTAIN Approver

06/28/23 BID SET

DATE DESCRIPTION 03/22/22 100% DD SET 08/22/22 50% CD SET 09/29/22 PERMIT SUBMITTAL 3 03/01/23 PSH 2 Resubmittal 1 6 04/28/23 PSH 2 Resubmittal 2

DRAWING TITLE PSH 2 - ENLARGED BATHROOM PLANS & ELEVATIONS

#### **GENERAL NOTES - INTERIOR ELEVATIONS**

A. ONLY RELEVANT INFORMATION IS NOTED/KEYED ON INTERIOR ELEVATIONS. SEE OVERALL ELEVATIONS, A2 SERIES FLOOR PLANS, AND A10 SERIES WINDOW/LOUVER/STOREFRONT SCHEDULES FOR BALANCE OF INFORMATION.

# KEYNOTES 6.05 WOOD HANDRAIL, SEE 17/A9.40, SEE CORRIDOR ELEVATIONS IN A5 SERIES WHERE APPLICABLE 6.21 WALL BASE, SEE SCHEDULE AND SPECS 9.24 GYP. BOARD - PAINT TYP 9.90 ACCENT PAINT WALL, SEE FINISH SCHEDULE

26.71 LIGHT FIXTURE, S.E.D., SEE LEGEND WHERE APPLICABLE





#### North Housing, Block A

#### PSH PHASE 2

520 MOSLEY AVENUE ALAMEDA, CA 94501

JOB NO. 19009
DRAWN Author
CHECKED Checker
JOB CAPTAIN Approver

 DATE
 DESCRIPTION

 08/22/22
 50% CD SET

 09/29/22
 PERMIT SUBMITTAL

 3
 03/01/23
 PSH 2 Resubmittal 1

 06/28/23
 BID SET

DRAWING TITLE
PSH 2 - CORRIDOR
UNITS ELEVATIONS

SCALE 1/4" = 1'-0

A5.25

4 A9.51

PSH 2 LEVELS 2-4 - EAST CORRIDOR UNITS 2 TYPICAL

1/4" = 1'-0"

**GENERAL NOTES - INTERIOR ELEVATIONS** 

A. ONLY RELEVANT INFORMATION IS NOTED/KEYED ON INTERIOR ELEVATIONS.
SEE OVERALL ELEVATIONS, A2 SERIES FLOOR PLANS, AND A10 SERIES
WINDOW/LOUVER/STOREFRONT SCHEDULES FOR BALANCE OF INFORMATION.

KEYNOTES

6.05 WOOD HANDRAIL, SEE 17/A9.40, SEE CORRIDOR ELEVATIONS IN A5 SERIES WHERE APPLICABLE

6.21 WALL BASE, SEE SCHEDULE AND SPECS

9.24 GYP. BOARD - PAINT TYP

9.24

6.05

9.90 ACCENT PAINT WALL, SEE FINISH SCHEDULE26.71 LIGHT FIXTURE, S.E.D., SEE LEGEND WHERE APPLICABLE

PAUL M
PAUL M
MCELWEE

A
C-28734

PAUL M
C-28734

CAREN
C-28734

#### North Housing, Block A

# PSH PHASE 2

520 MOSLEY AVENUE ALAMEDA, CA 94501

JOB NO. 19009
DRAWN Author
CHECKED Checker

JOB CAPTAIN Approver ISSUE

DATE DESCRIPTION

08/22/22 50% CD SET

09/29/22 PERMIT SUBMITTAL

3 03/01/23 PSH 2 Resubmittal 1

06/28/23 BID SET

DRAWING TITLE
PSH 2 - CORRIDOR
UNITS ELEVATIONS

SCALE 1/4" = 1'-0"

A5.26
COPYRIGHT © 2020 HKIT ARCHITECTS

**GENERAL NOTES - INTERIOR ELEVATIONS** 

A. ONLY RELEVANT INFORMATION IS NOTED/KEYED ON INTERIOR ELEVATIONS. SEE OVERALL ELEVATIONS, A2 SERIES FLOOR PLANS, AND A10 SERIES WINDOW/LOUVER/STOREFRONT SCHEDULES FOR BALANCE OF INFORMATION.

KEYNOTES

6.21 WALL BASE, SEE SCHEDULE AND SPECS

8.51 EXTERIOR WINDOW - SEE WINDOW SCHEDULE

12.91 LONG-TERM BIKE STORAGE RACK, DERO DECKER

8.01 DOOR, SEE DOOR SCHEDULE

12.108 DERO FIXIT STATION

### North Housing, Block A

#### PSH PHASE 2

#### 520 MOSLEY AVENUE ALAMEDA, CA 94501


JOB NO. DRAWN Author CHECKED Checker JOB CAPTAIN Approver


ISSUE DATE DESCRIPTION 08/22/22 50% CD SET 09/29/22 PERMIT SUBMITTAL


3 03/01/23 PSH 2 Resubmittal 1 06/28/23 BID SET

DRAWING TITLE PSH 2 - BIKE PARKING **ELEVATIONS** 

SCALE 1/4" = 1'-0"

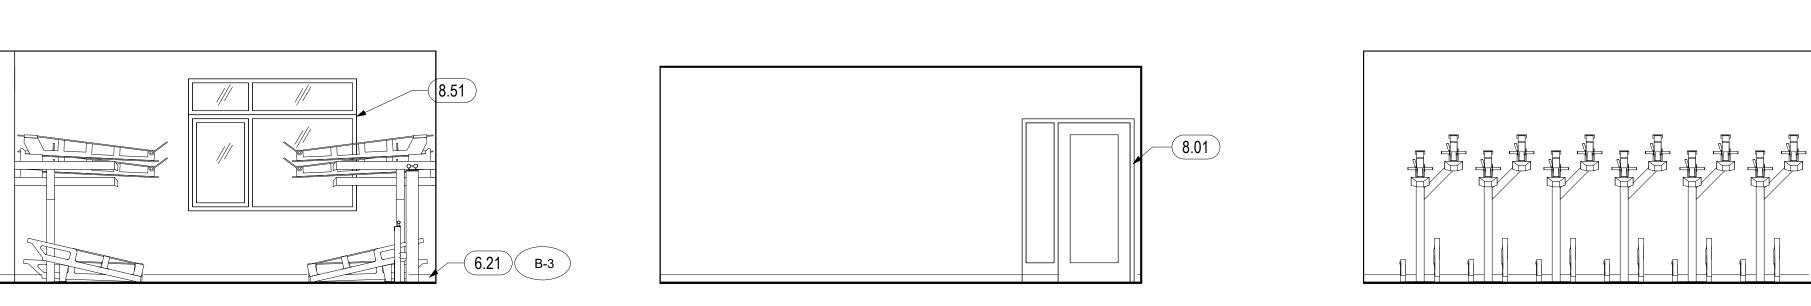


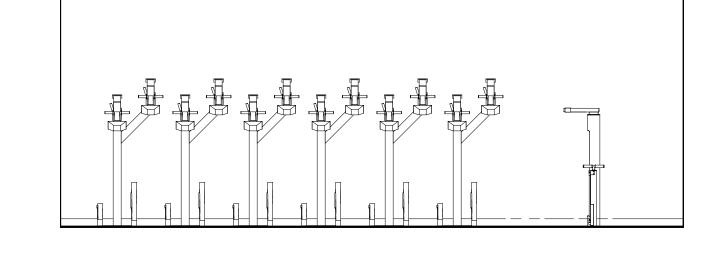

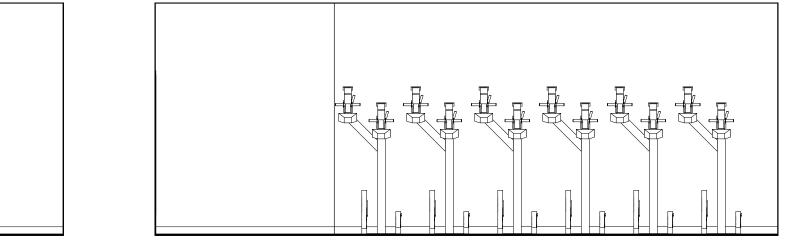

PSH 2 LEVEL 1 - BIKE PARKING WEST ELEV.

1/4" = 1'-0"

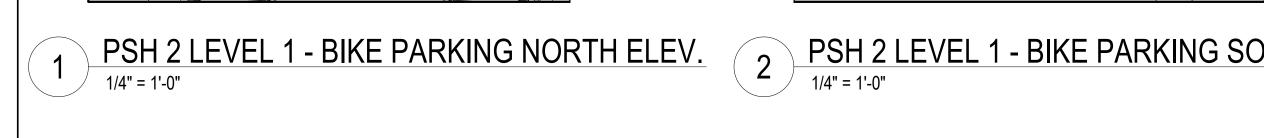



(12.108)


5 PSH 2 - BIKE ROOM
1/4" = 1'-0"


PSH 2 LEVEL 1 - BIKE PARKING SOUTH ELEV.

1/4" = 1'-0"

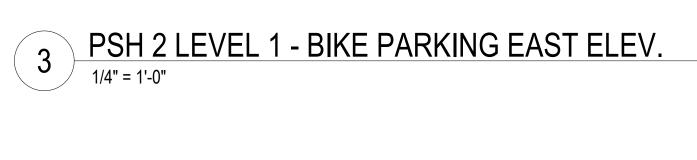

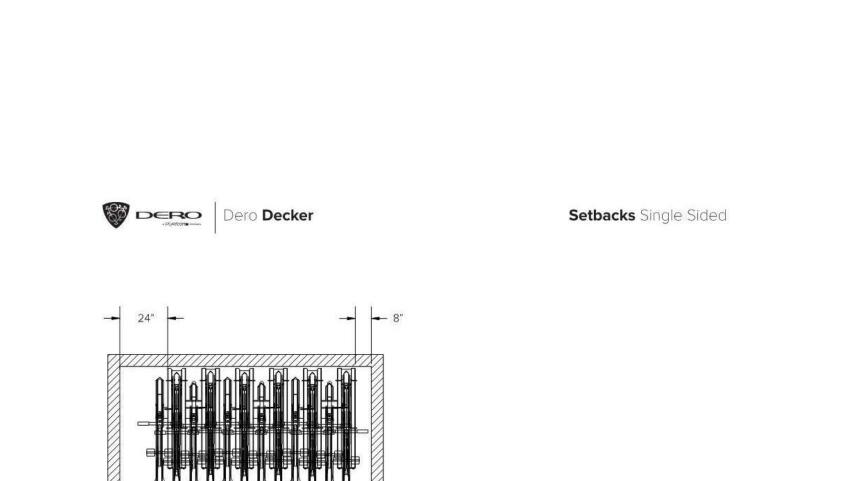

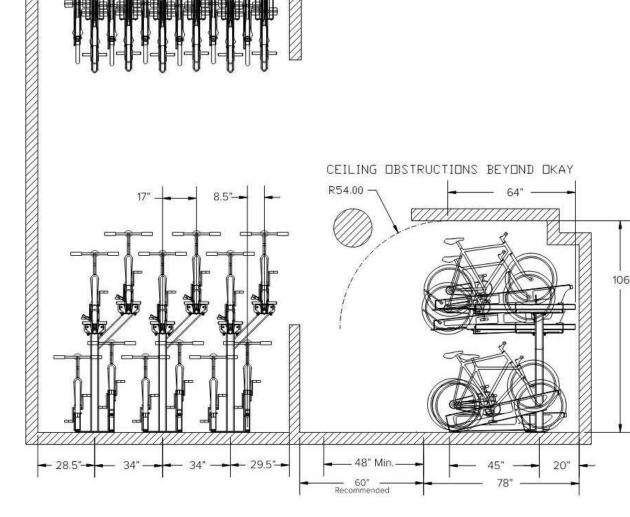

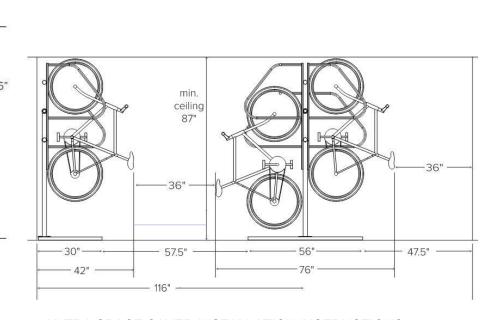

ULTRA SPACE SAVER INSTALLATION INSTRUCTIONS



DERO DECKER INSTALLATION INSTRUCTIONS




PSH PHASE 2

DESCRIPTION 12/8/21 SD SET 03/22/22 | 100% DD SET 08/22/22 | 50% CD SET 09/29/22 PERMIT SUBMITTAL

3 | 03/01/23 | PSH 2 Resubmittal 1 06/28/23 BID SET

PSH 2 - 1ST FLOOR

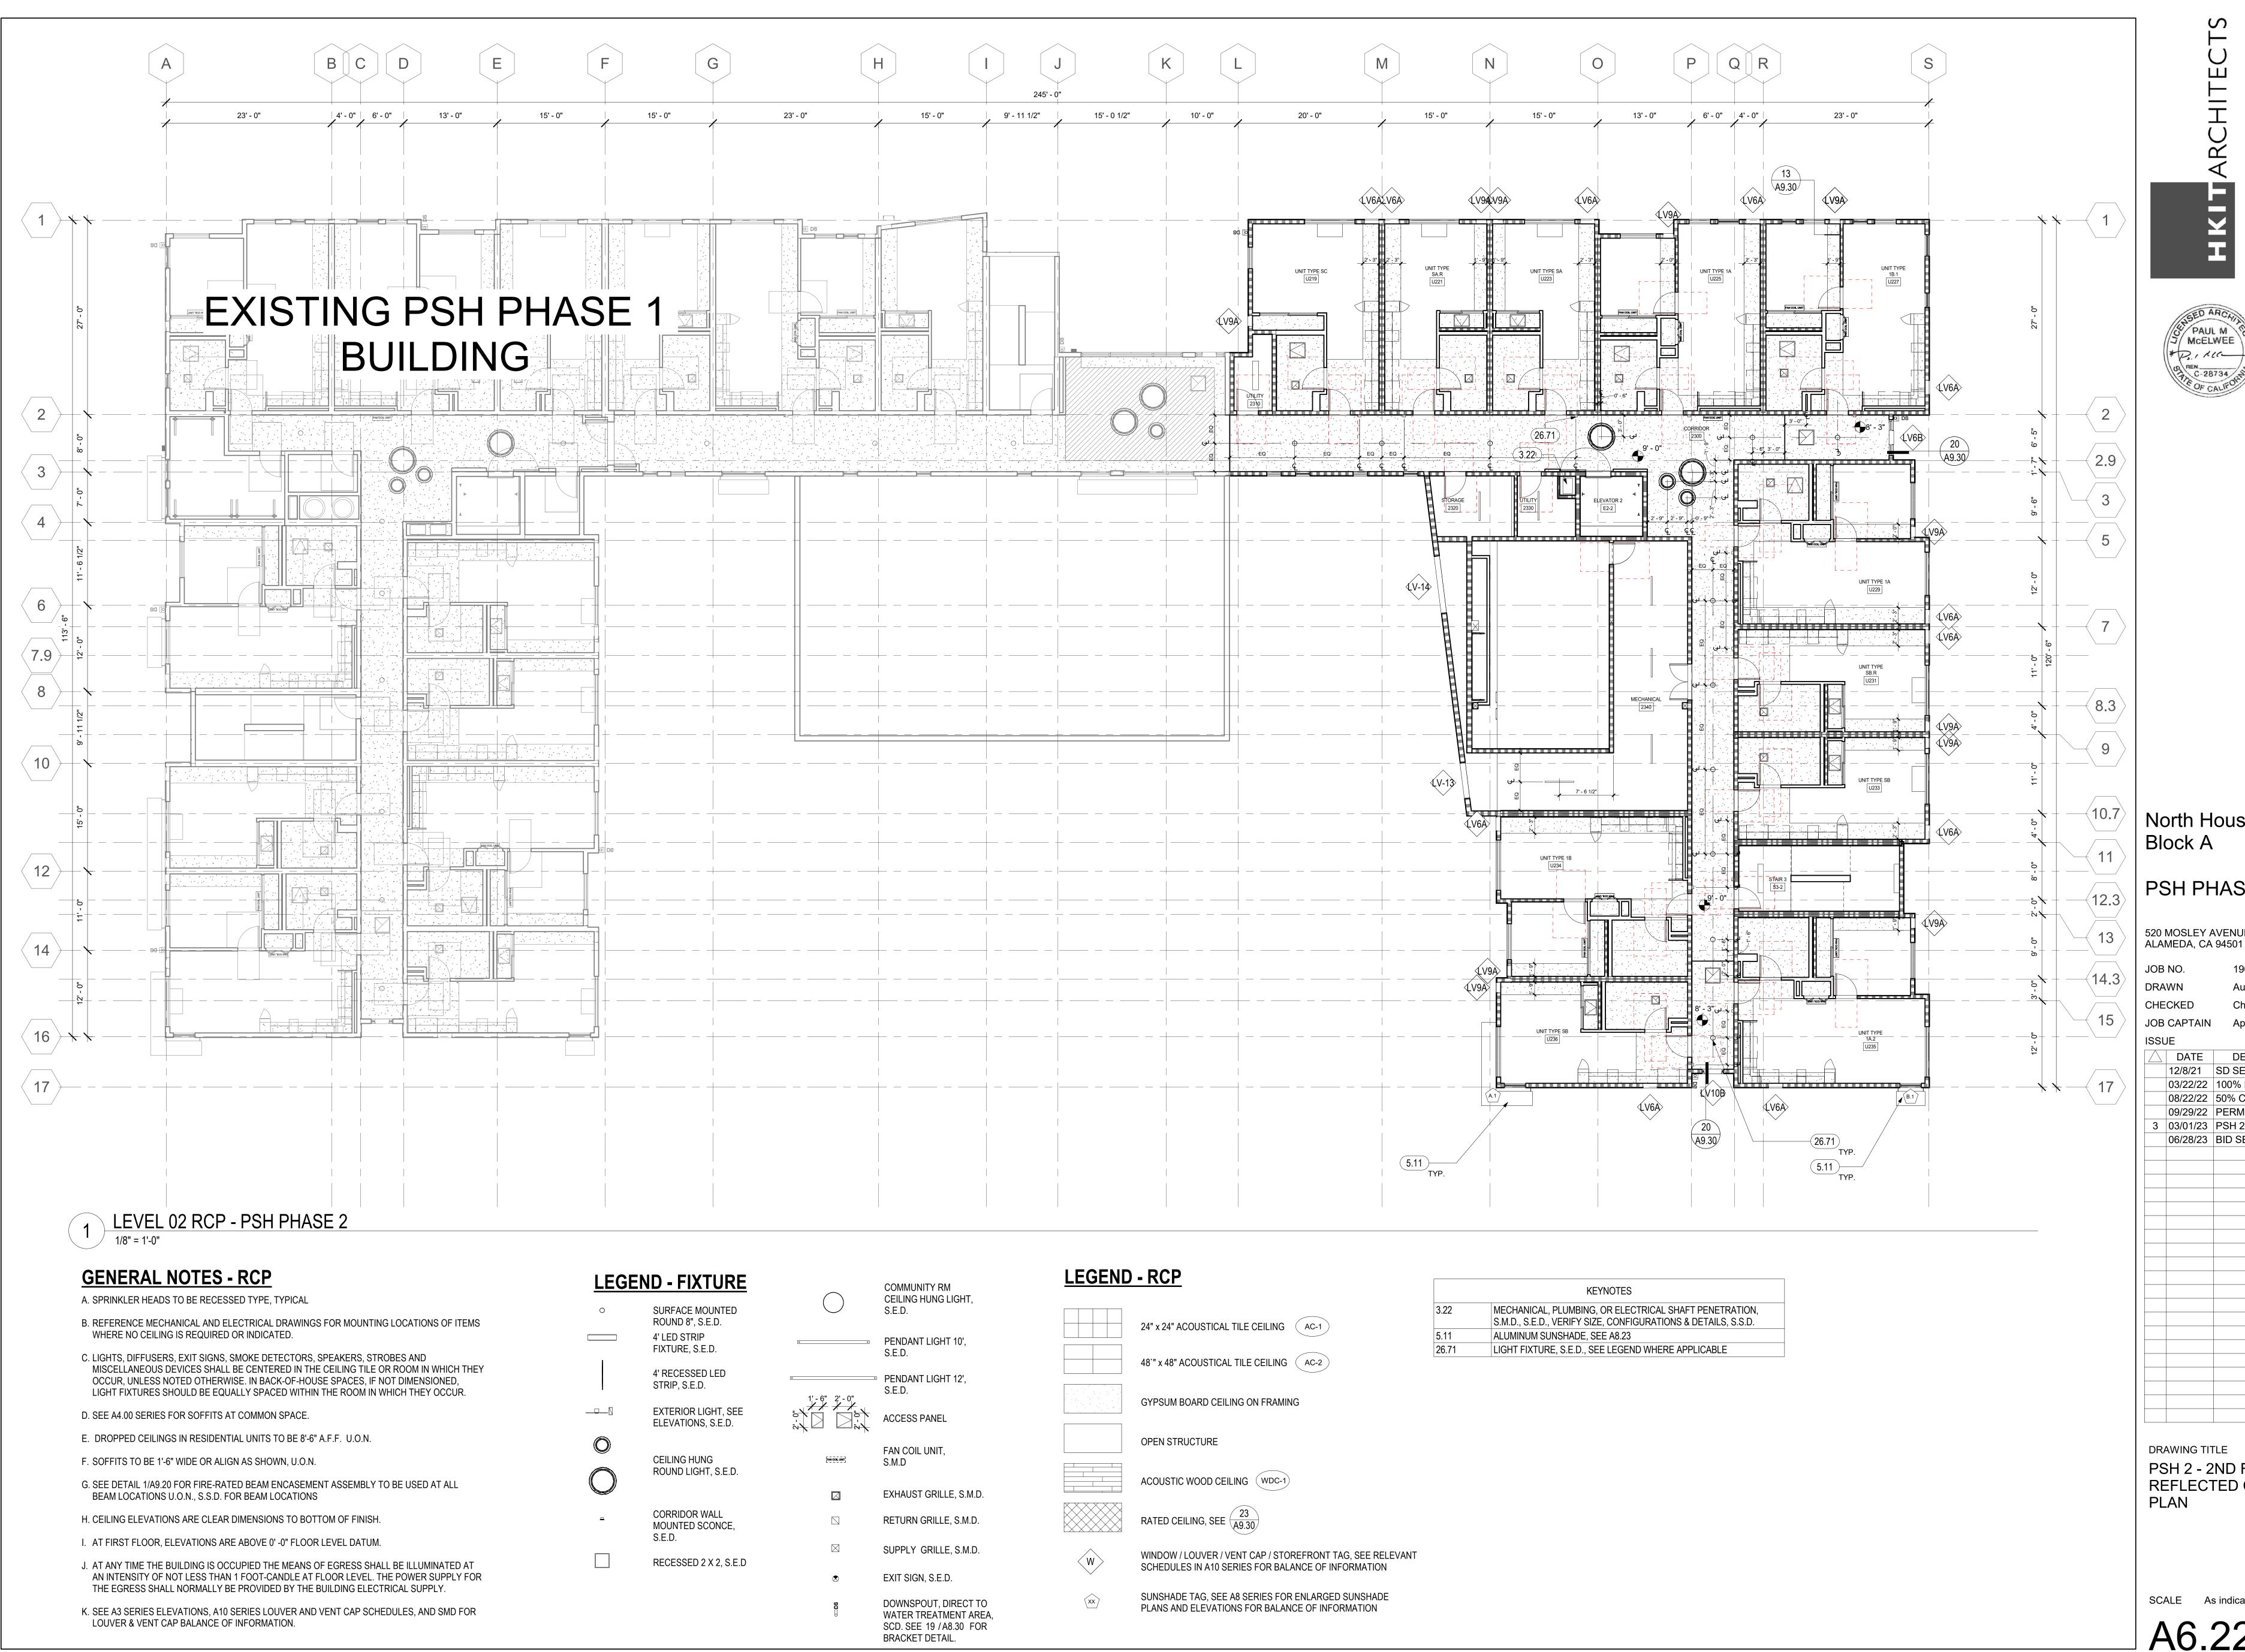



PSH PHASE 2

520 MOSLEY AVENUE

Checker

DESCRIPTION 12/8/21 SD SET 03/22/22 100% DD SET 08/22/22 | 50% CD SET

09/29/22 PERMIT SUBMITTAL

3 | 03/01/23 | PSH 2 Resubmittal 1 06/28/23 BID SET

DRAWING TITLE PSH 2 - 2ND FLOOR REFLECTED CEILING



PSH PHASE 2


520 MOSLEY AVENUE

ALAMEDA, CA 94501

DESCRIPTION 12/8/21 SD SET 03/22/22 | 100% DD SET 08/22/22 50% CD SET

09/29/22 PERMIT SUBMITTAL 3 | 03/01/23 | PSH 2 Resubmittal 1 06/28/23 BID SET

PSH 2 - 3RD FLOOR REFLECTED CEILING

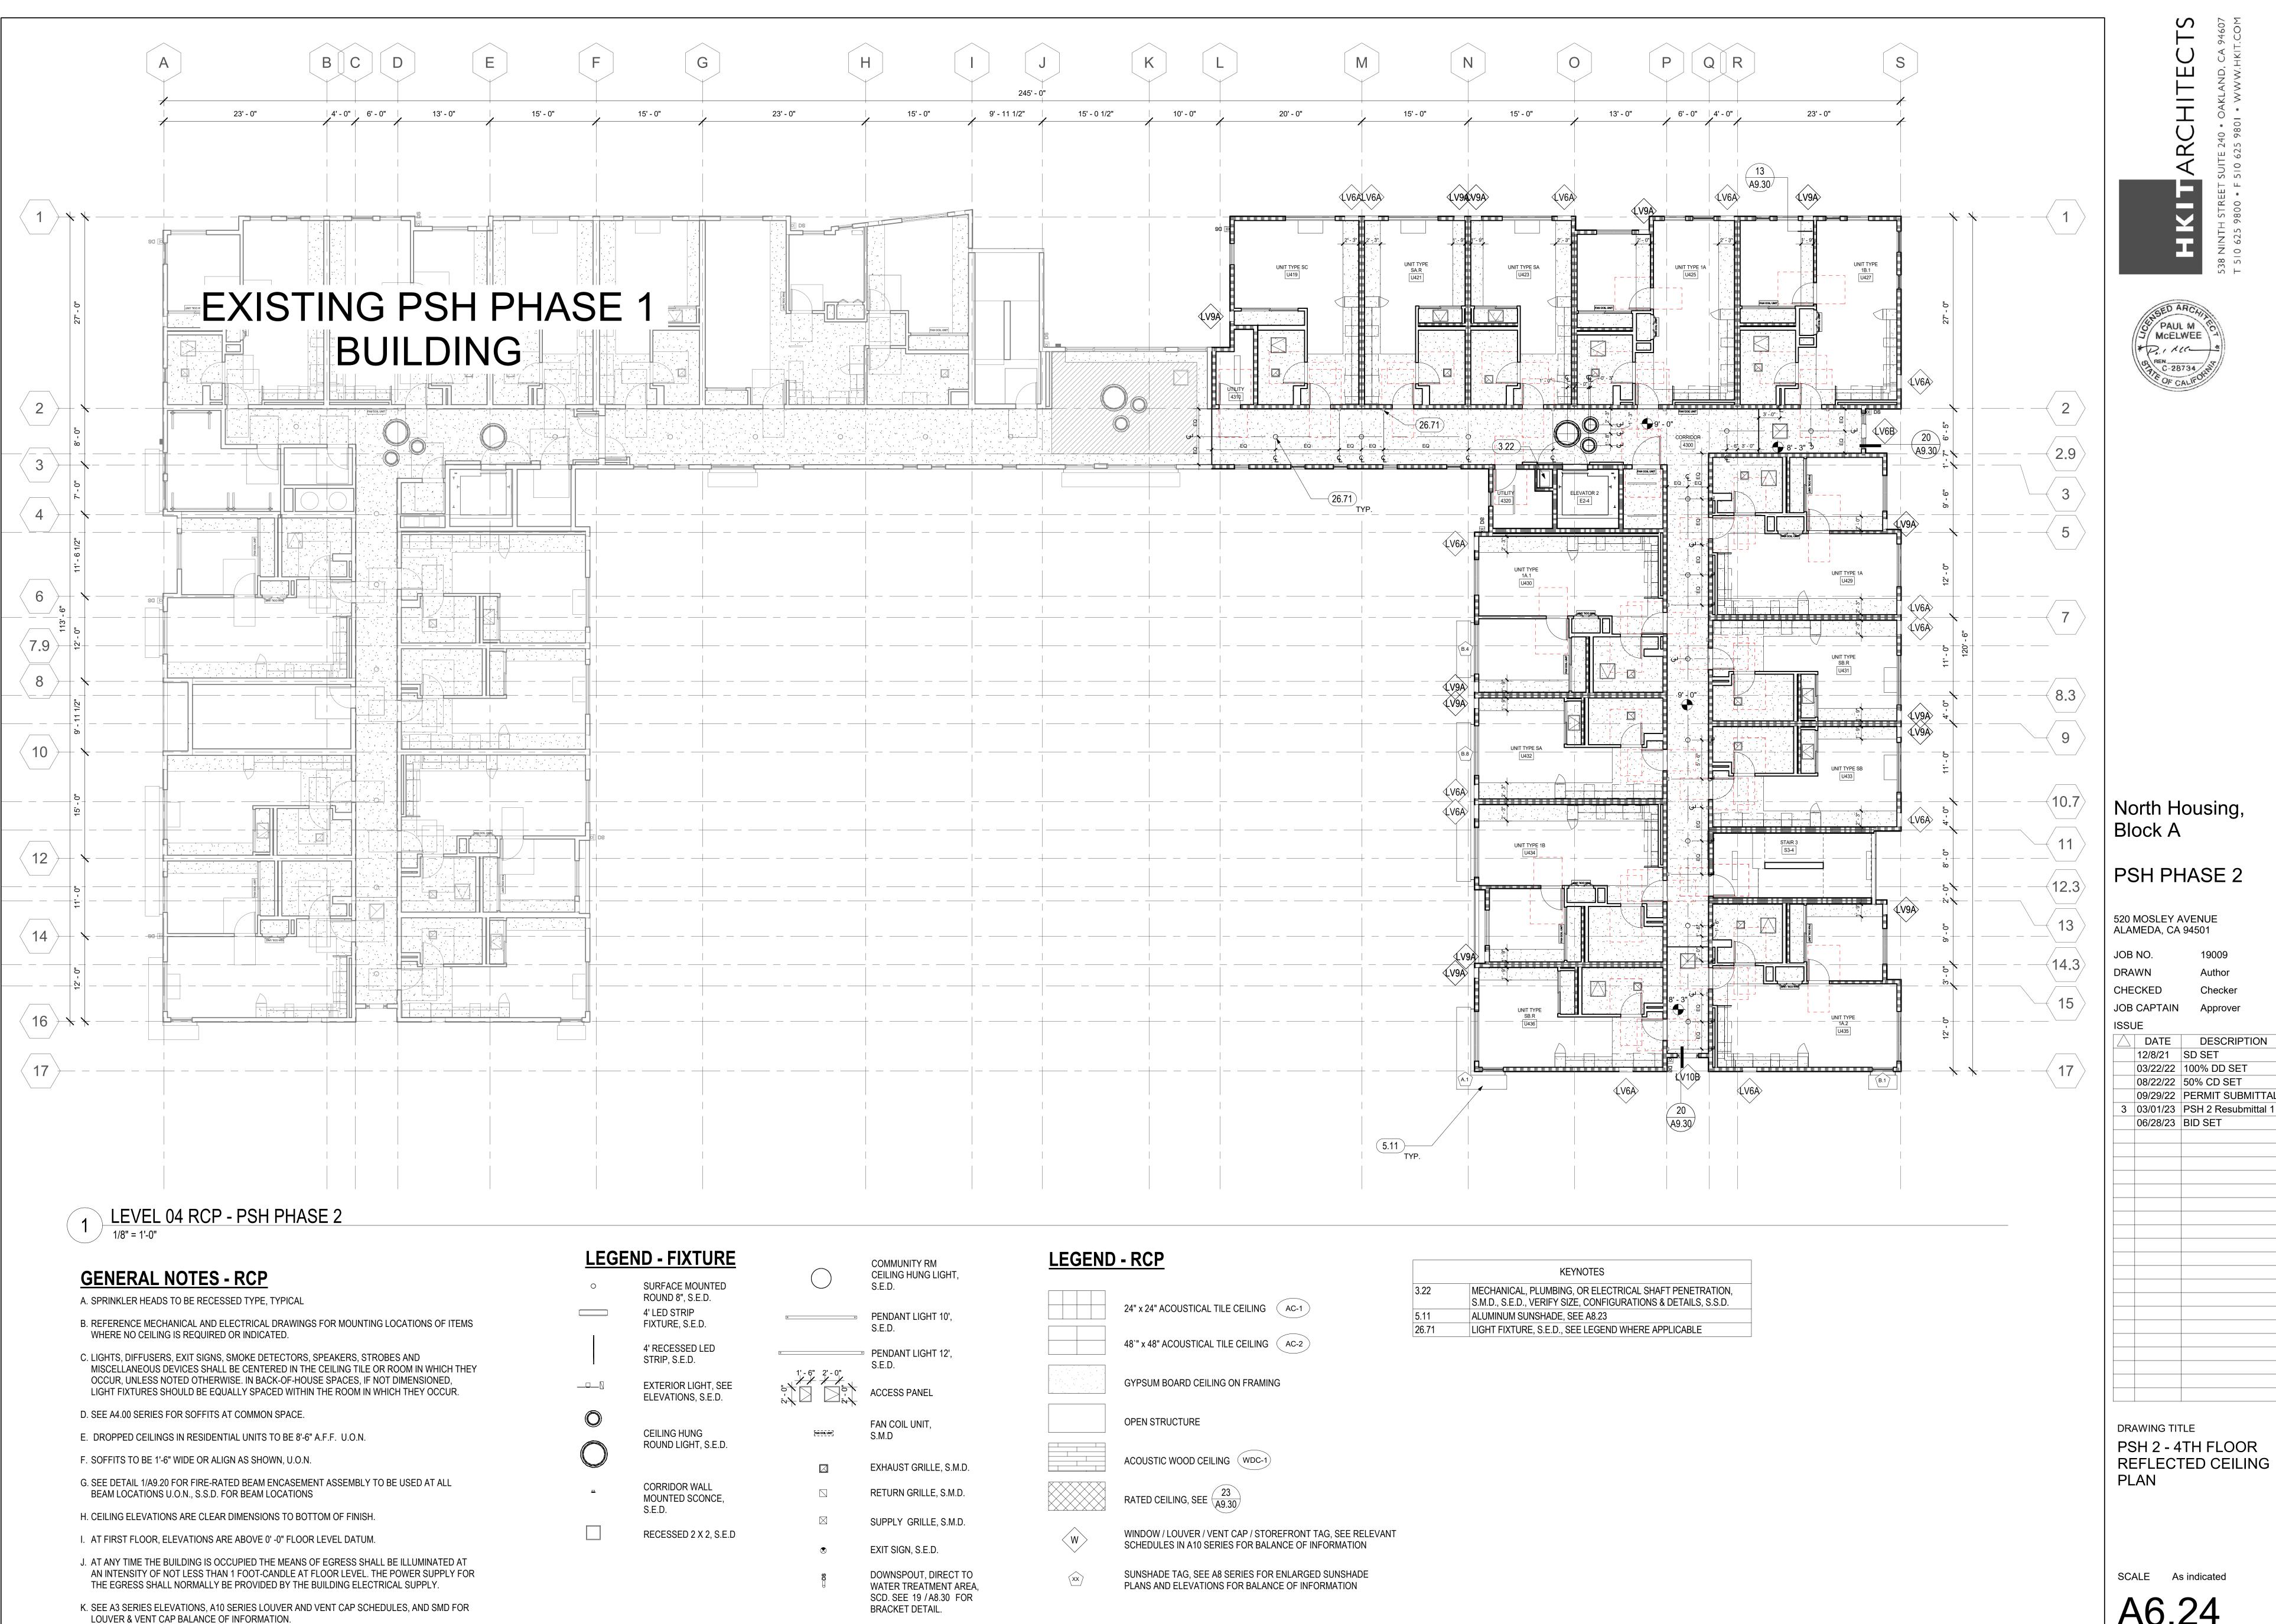



PSH PHASE 2

520 MOSLEY AVENUE ALAMEDA, CA 94501

DESCRIPTION 12/8/21 SD SET 03/22/22 | 100% DD SET 08/22/22 | 50% CD SET 09/29/22 PERMIT SUBMITTAL

3 | 03/01/23 | PSH 2 Resubmittal 1

06/28/23 BID SET

DRAWING TITLE PSH 2 - 4TH FLOOR



5.06 ROOF GUTTER, SEE 14/A8.30 6.05 WOOD HANDRAIL, SEE 17/A9.40, SEE CORRIDOR ELEVATIONS IN A5 SERIES WHERE APPLICABLE 6.06 HANDRAIL EXTENSION, SEE 19/A9.40 & 20/A9.40 6.10 42" HIGH WALL W/ PAINTED WOOD CAP, SEE 6/A9.10 6.51 WOOD FRAMED STAIR, S.S.D. 21.03 STANDPIPE, EXACT LAYOUT TO BE COORDINATED. S.FP.D.

KEYNOTES

**GENERAL NOTES - VERTICAL CIRCULATION** 

A. SEE SHEETS A7.33 & A7.34 FOR ELEVATOR CONTROL ROOM LAYOUT, DETAILED HOISTWAY PLAN AND SECTION, AND BALANCE OF INFO.

B. FOR WALL TYPES, SEE SHEET A9.00

HORIZONTAL POSITION, CBC 3002.4

PSH 2 - STAIR 3 - E-W FACING SOUTH

1/4" = 1'-0"

C.FOR FLOOR ASSEMBLIES, SEE SHEET A8.10

D. TYPICAL TREAD DEPTH TO BE 11" MINIMUM. TYPICAL RISER HEIGHT TO BE 7" MAXIMUM.

E. FOR SIGNAGE AND SIGNAGE PLANS, SEE


F. SEE INTERIOR FINISH SCHEDULE FOR STAIR FLOOR FINISH.

G. PROVIDE CONTRASTING STRIPE AT TOP AND BOTTOM TREAD OF EACH FLIGHT. INSTALL CONTRASTING CARPET STRIPE AT CARPET TREAD OR PAINTED STRIPE AT CONCRETE TREAD.

H. SEE STRUCTURAL DRAWINGS FOR STAIR STRINGERS, SUPPORTS, BRACING AND RELATED STAIR STRUCTURAL DETAILS.

I. THE MEDICAL EMERGENCY SERVICE ELEVATOR SHALL ACCOMMODATE THE LOADING AND TRANSPORT OF AN AMBULANCE GURNEY OR STRETCHER [MAXIMUM SIZE 24 INCHES BY 84 INCHES WITH NOT LESS THAN 5-INCH RADIUS CORNERS IN THE



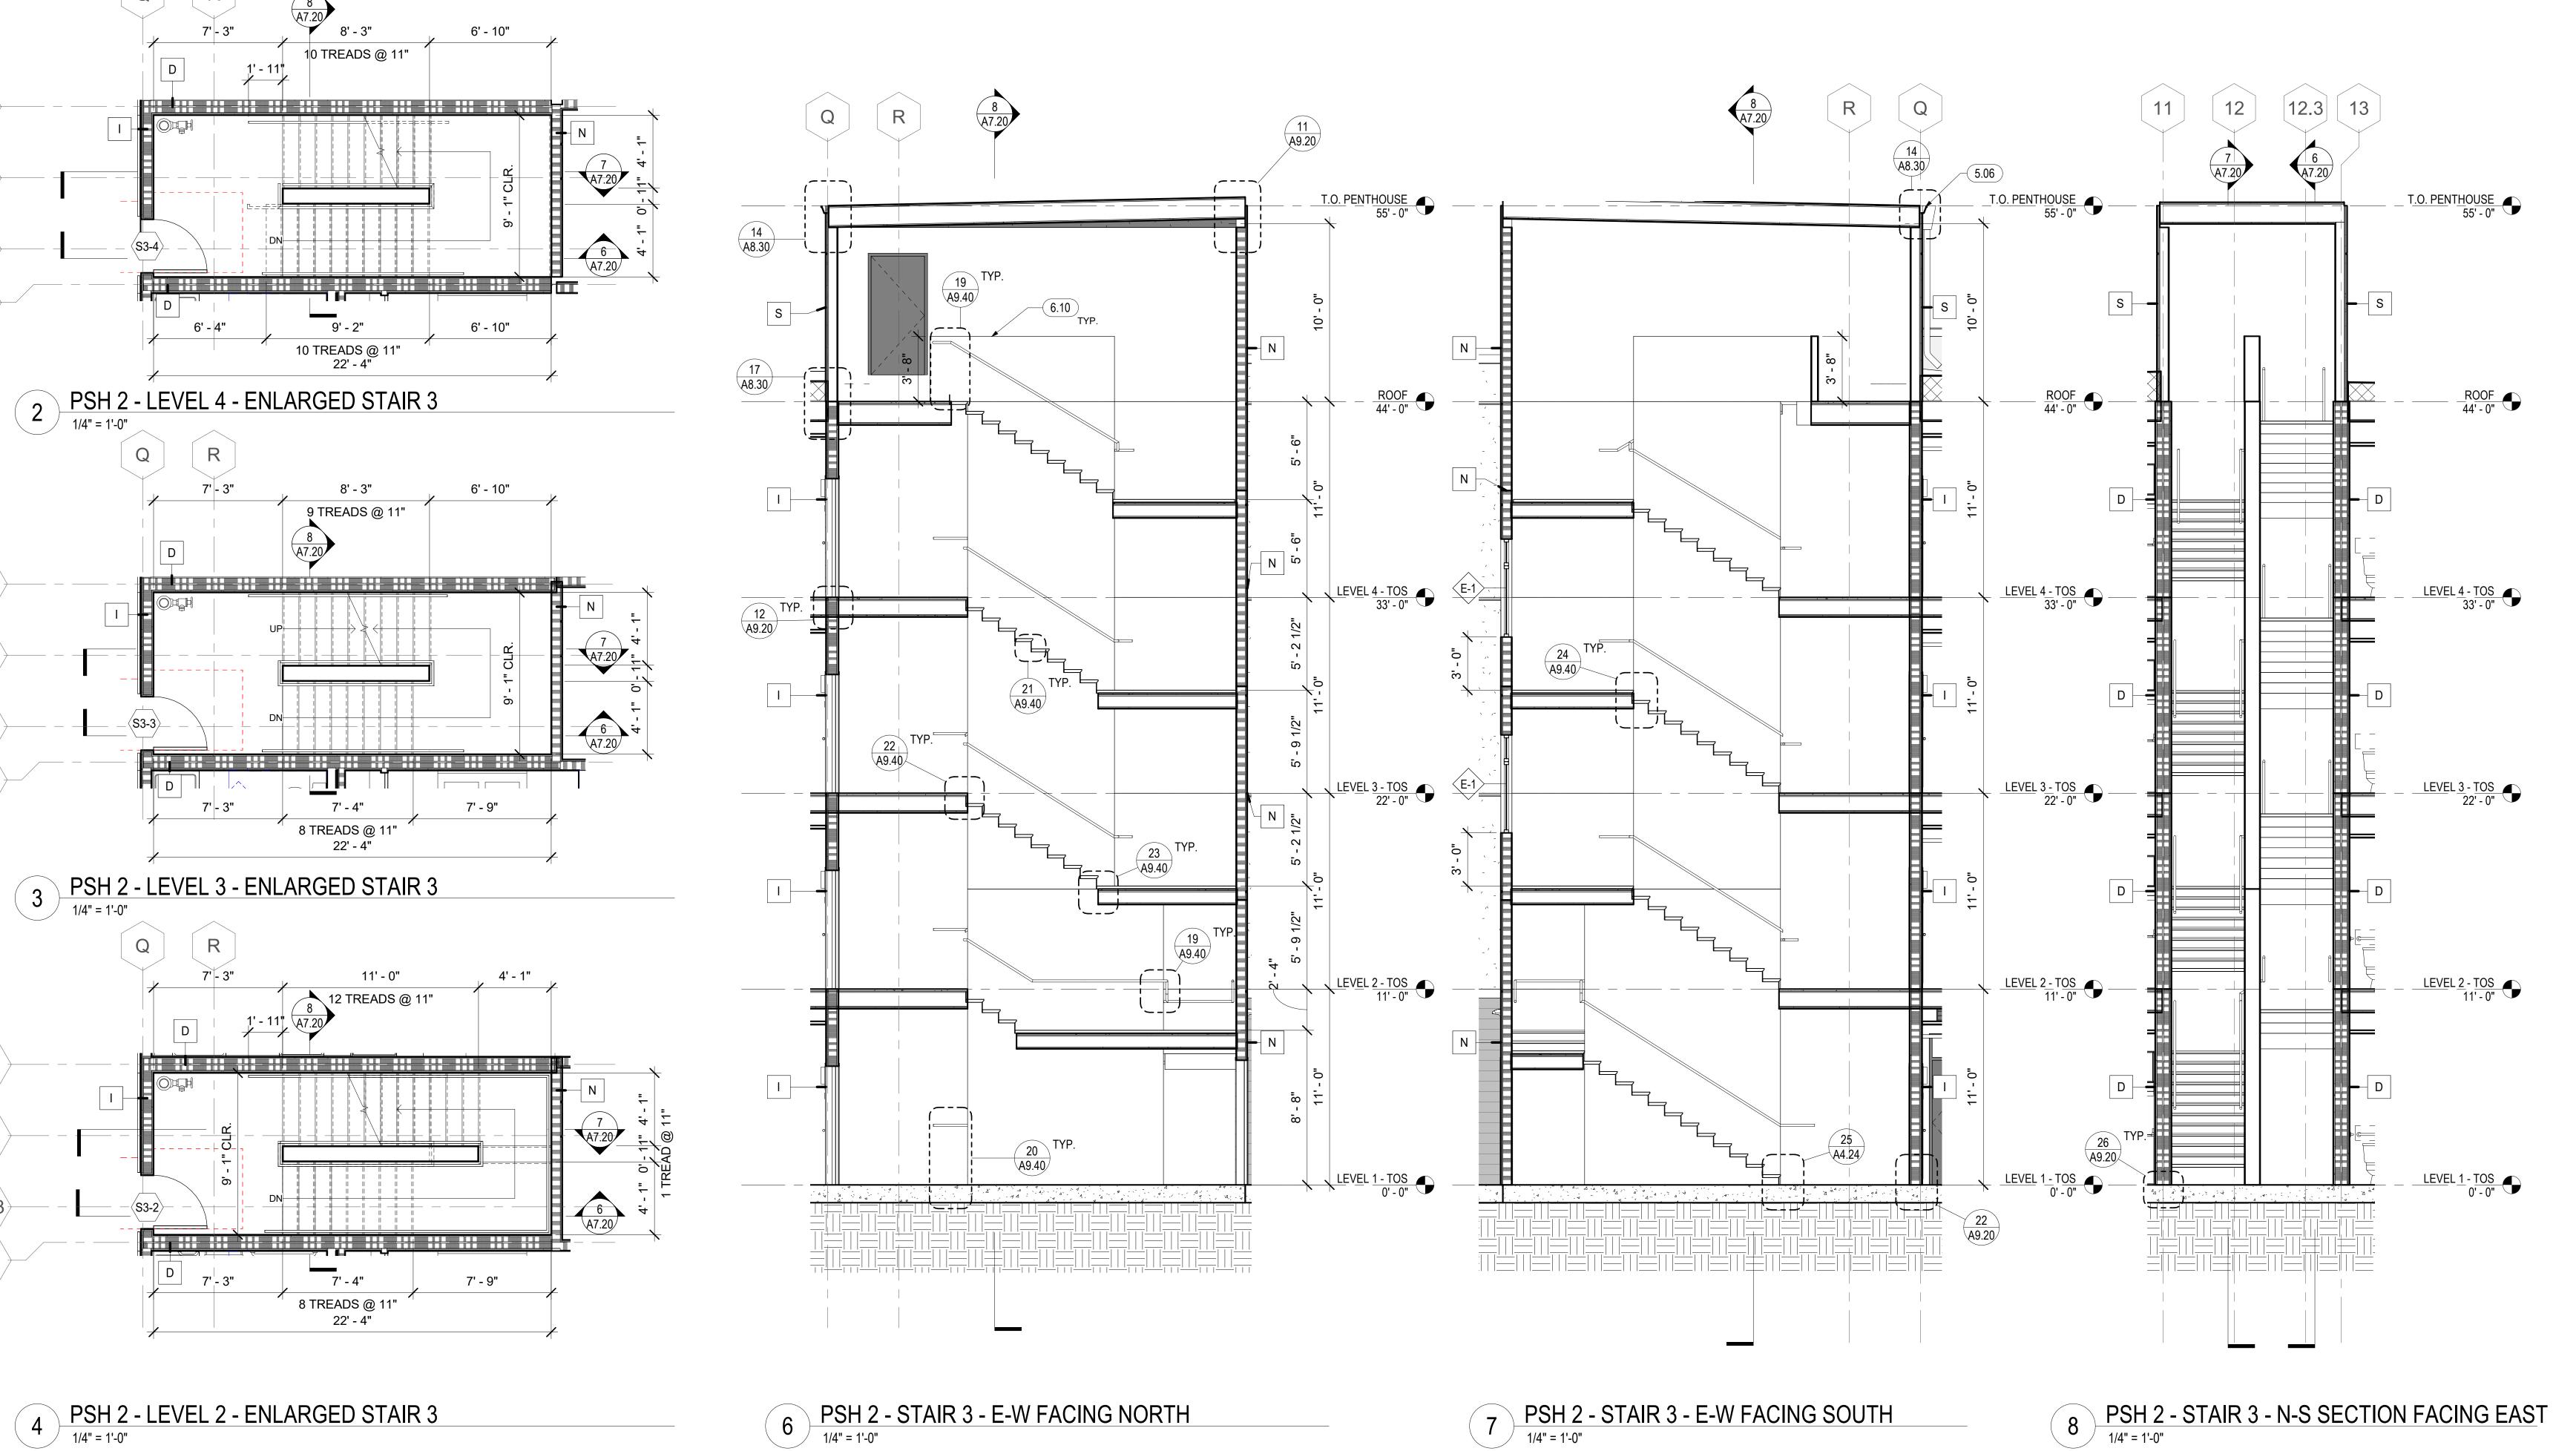

/1' - 8 1/2" 8' - 3"

6' - 4" S

PSH 2 - ROOF - ENLARGED STAIR 3

 $\langle 12.3 \rangle$ 

(12.3)

13

12

9 TREADS @ 11"

10 TREADS @ 11"

22' - 3"

6' - 9"

<del>---/--</del> 6' - 9"

(6.06)

7' - 3"

3 TREADS @ 11"

5 PSH 2 - LEVEL 1 - ENLARGED STAIR 3

6 PSH 2 - STAIR 3 - E-W FACING NORTH

1/4" = 1'-0"

〈 12 *〉* 

**12.3** 

13

North Housing, Block A

PSH PHASE 2

520 MOSLEY AVENUE ALAMEDA, CA 94501

CHECKED

JOB CAPTAIN

03/22/22 100% DD SET

08/22/22 50% CD SET

3 03/01/23 PSH 2 Resubmittal 06/28/23 BID SET

DRAWING TITLE PSH 2 - STAIR PLANS AND SECTIONS

SCALE

8 PSH 2 - STAIR 3 - N-S SECTION FACING EAST

KEYNOTES

3.31 SEE LANDSCAPE DRAWINGS FOR STAIR CONSTRUCTION, TYPICAL ALL BUILDINGS
 5.59 SEE LANDSCAPE DRAWINGS FOR RAILING, TYPICAL ALL BUILDINGS

HKIT ARCHITECT

538 NINTH STREET SUITE 240 • OAKLAND, CA 946



North Housing, Block A

PSH PHASE 2

520 MOSLEY AVENUE ALAMEDA, CA 94501

JOB NO. 19009
DRAWN Author
CHECKED Checker

JOB CAPTAIN ISSUE

DATE DESCRIPTION

03/22/22 100% DD SET

08/22/22 50% CD SET

09/29/22 PERMIT SUBMITTAL


03/01/23 PSH 2 Resubmittal 1


09/29/22 PERMIT SUBMITTAL
3 03/01/23 PSH 2 Resubmittal 1
06/28/23 BID SET

DRAWING TITLE
PSH 2 - ENLARGED
EXTERIOR STAIRS

SCALE 1/4" = 1'-0"



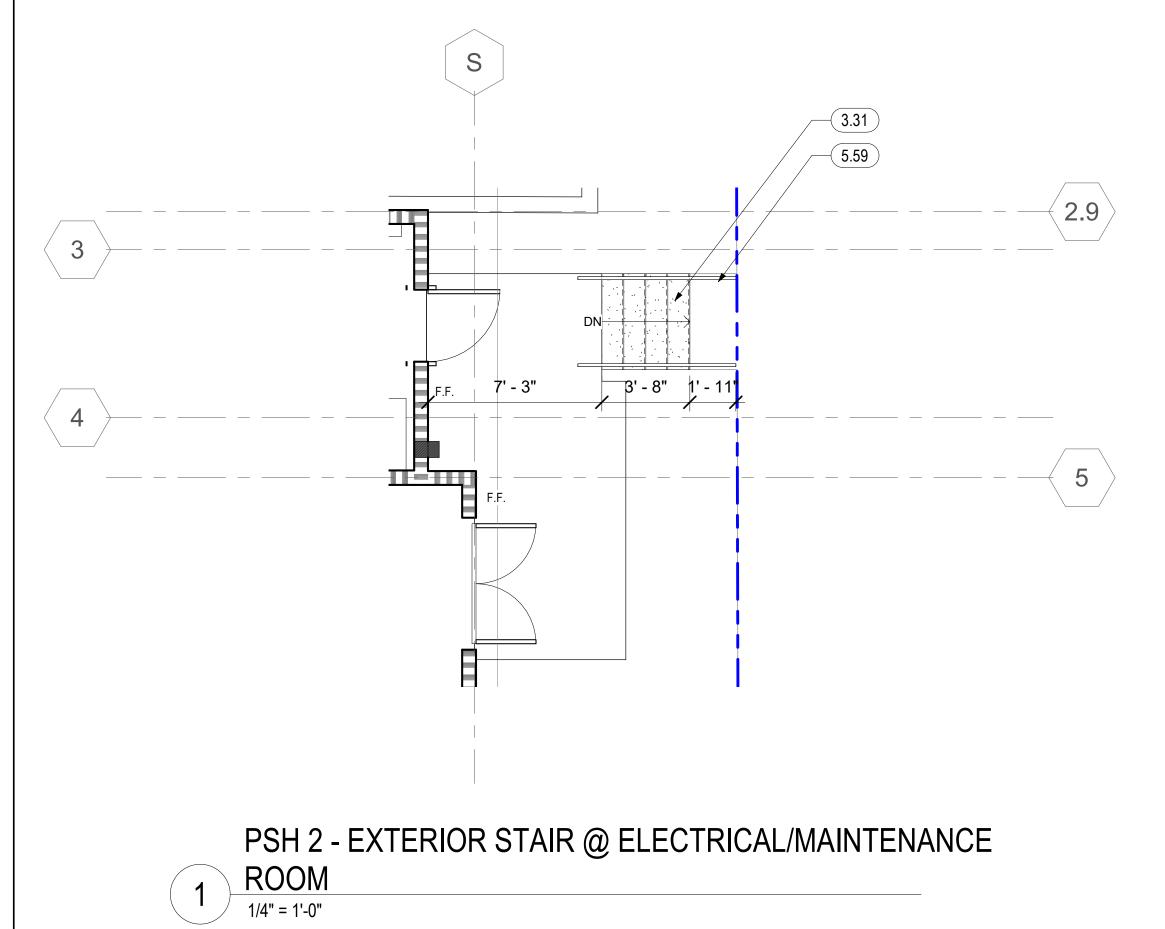

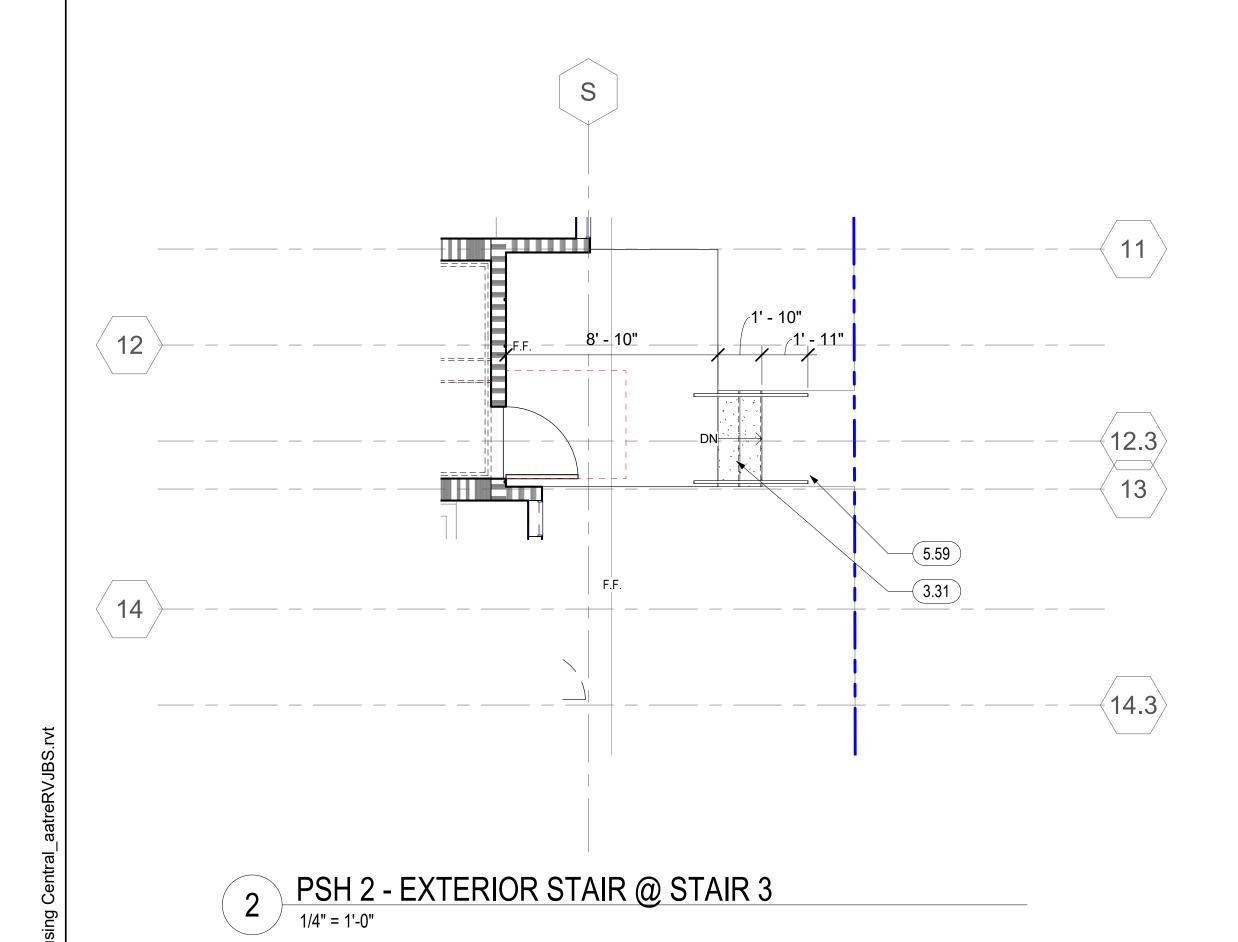

**GENERAL NOTES - VERTICAL CIRCULATION** 

A. SEE SHEETS A7.33 & A7.34 FOR ELEVATOR CONTROL ROOM LAYOUT, DETAILED

D. TYPICAL TREAD DEPTH TO BE 11" MINIMUM. TYPICAL RISER HEIGHT TO BE 7"

G. PROVIDE CONTRASTING STRIPE AT TOP AND BOTTOM TREAD OF EACH FLIGHT. INSTALL CONTRASTING CARPET STRIPE AT CARPET TREAD OR PAINTED STRIPE AT

H. SEE STRUCTURAL DRAWINGS FOR STAIR STRINGERS, SUPPORTS, BRACING AND

LOADING AND TRANSPORT OF AN AMBULANCE GURNEY OR STRETCHER [MAXIMUM SIZE 24 INCHES BY 84 INCHES WITH NOT LESS THAN 5-INCH RADIUS CORNERS IN THE

STEEL POST AS REQ'D. BY
ELEVATOR MANUFACTURER
TO SUPPORT RAIL BRACKET,
SSD, SEE ELEVATOR
SUBMITTAL

I. THE MEDICAL EMERGENCY SERVICE ELEVATOR SHALL ACCOMMODATE THE

HOISTWAY PLAN AND SECTION, AND BALANCE OF INFO.

F. SEE INTERIOR FINISH SCHEDULE FOR STAIR FLOOR FINISH.

B. FOR WALL TYPES, SEE SHEET A9.00

MAXIMUM.

CONCRETE TREAD.

C.FOR FLOOR ASSEMBLIES, SEE SHEET A8.10

E. FOR SIGNAGE AND SIGNAGE PLANS, SEE

RELATED STAIR STRUCTURAL DETAILS.

HORIZONTAL POSITION, CBC 3002.4


CHECKED

JOB CAPTAIN

DESCRIPTION 12/8/21 SD SET 03/22/22 100% DD SET 08/22/22 50% CD SET 3 03/01/23 PSH 2 Resubmittal 06/28/23 BID SET

DRAWING TITLE PSH 2 - ELEVATOR PLANS AND SECTIONS

SCALE

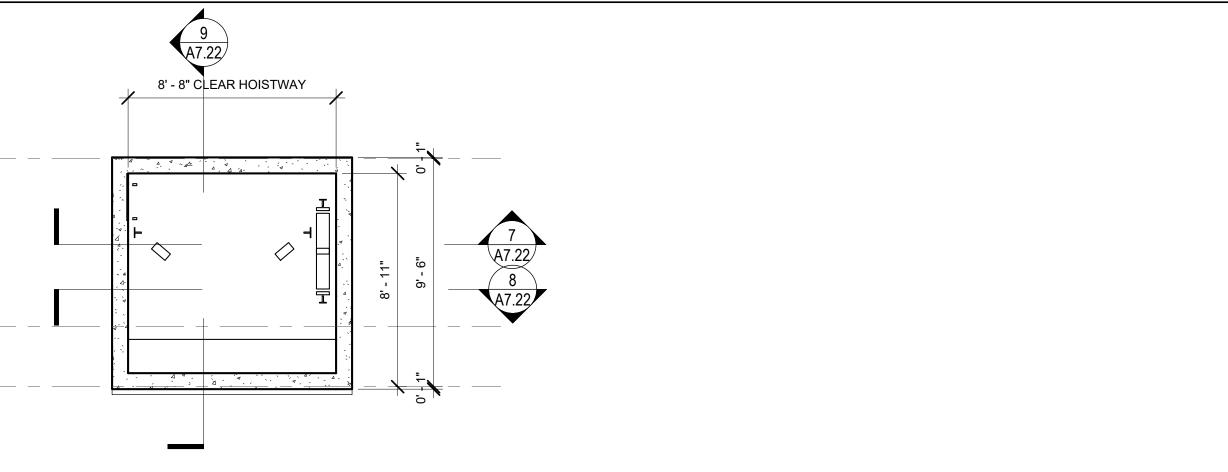

6 PSH 2 - ELEVATOR PIT - ENLARGED ELEVATOR 2


ARTIFICIAL BOTTOM SEAL. (3006.3 CBC) 14.20 | ELEVATOR CAR, SEE 6/A9.90 14.21 | ELEVATOR OVERRUN, PROVIDE SHAFT VENTS AS REQUIRED BY ELEVATOR MANUFACTURER, S.M.D. 14.22 ELEVATOR PIT, S.S.D., 14.24 ELEVATOR PIT LADDER, SEE DETAIL 14/A9.90 14.96 THE MEDICAL EMERGENCY SERVICE ELEVATOR SHALL ACCOMMODATE THE LOADING AND TRANSPORT OF AN AMBULANCE GURNEY OR STRETCHER [MAXIMUM SIZE 24 INCHES BY 84 INCHES WITH NOT LESS HAN 5-INCH RADIUS CORNERS IN THE HORIZONTAL POSITION, CBC 3002.4

\_T.<u>O. PENTHOUSE</u> 55' - 0"

LEVEL 4 - TOS 33' - 0" LEVEL 3 - TOS LEVEL 2 - TOS

LEVEL 1 - TOS 1 A9.40 ELEVATOR PIT - TOS -5' - 0"

PSH 2 - ELEVATOR 2 - E-W SECTION FACING SOUTH

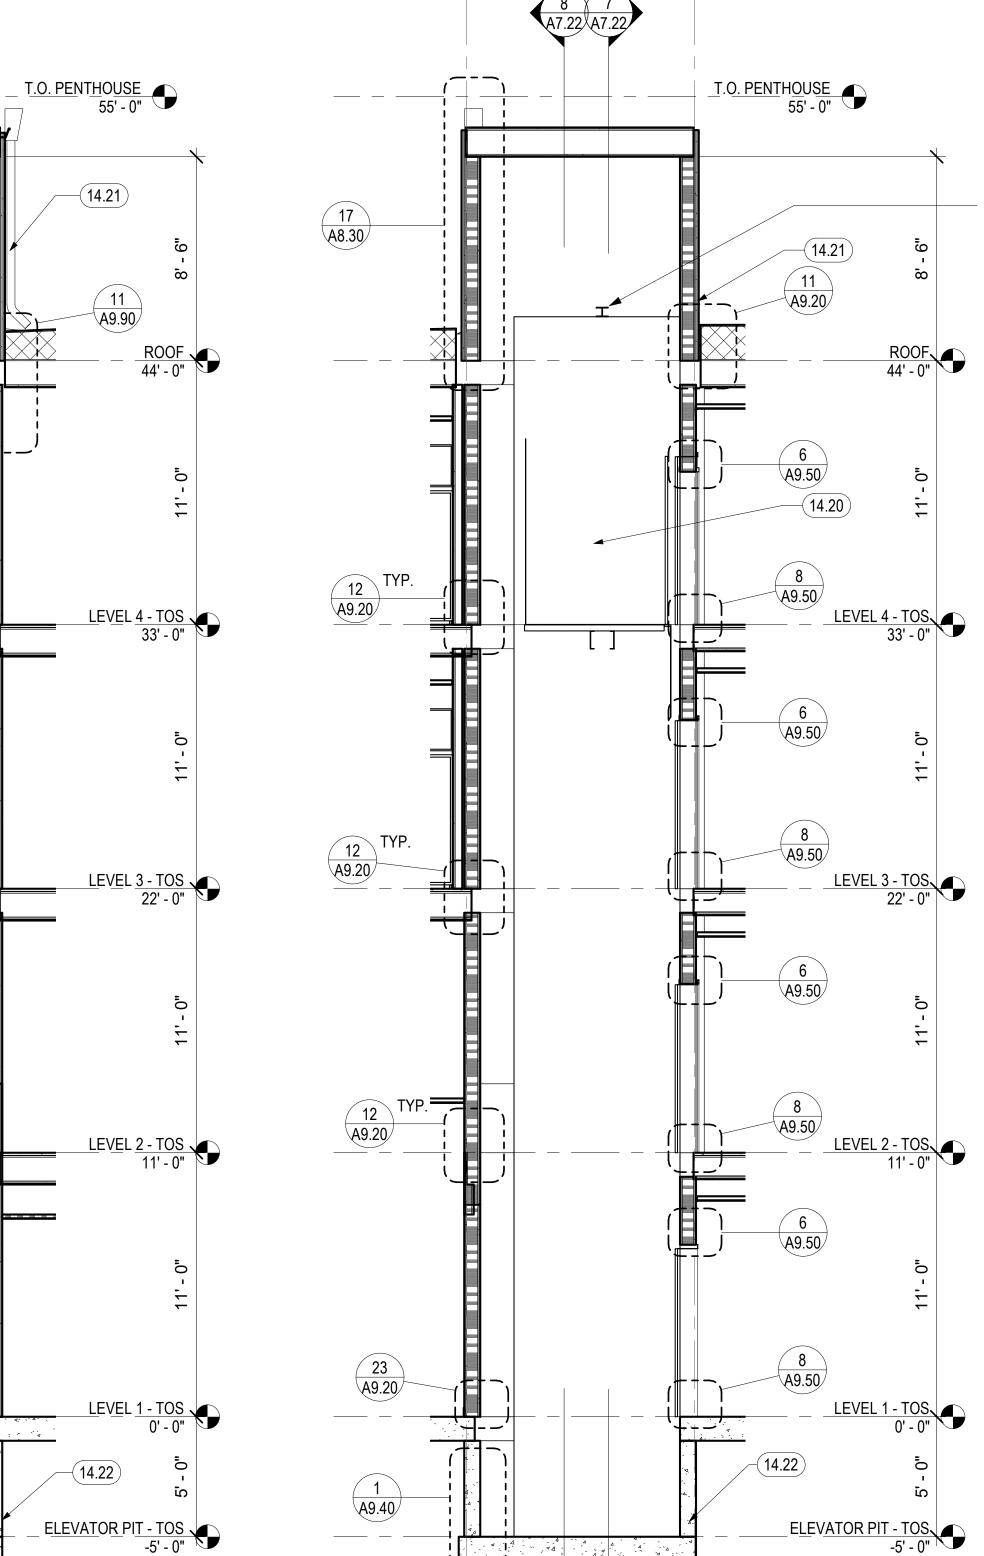

KEYNOTES

716.2.2.1.1 WHEN TESTED IN ACCORDANCE WITH UL 1784 WITHOUT AN

SMOKE AND DRAFT CONTROL DOOR ASSEMBLY REQUIREMENTS IN SECTION


8.02 ELEVATOR SMOKE DOOR(S) ON EMHO. DOOR SHALL COMPLY WITH THE


5.60 STEEL HOIST BEAM, S.S.D.


PSH 2 - ELEVATOR 2 - E-W SECTION FACING NORTH

1/4" = 1'-0"


9 PSH 2 - ELEVATOR 2 - N-S SECTION FACING WEST

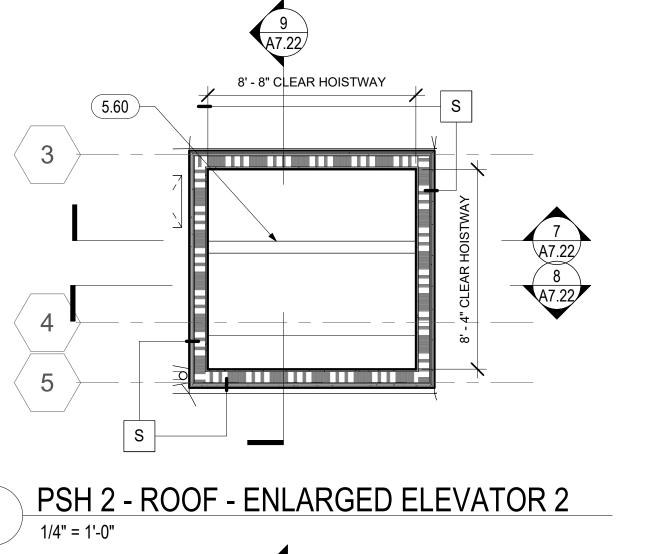

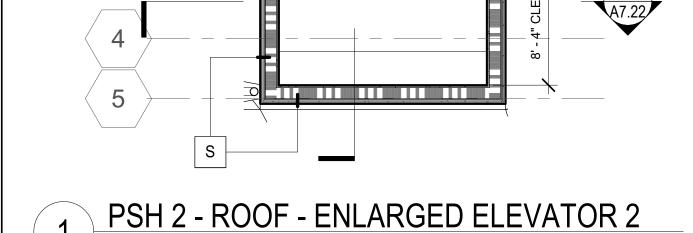


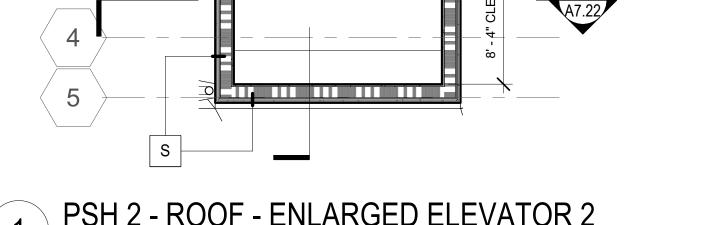



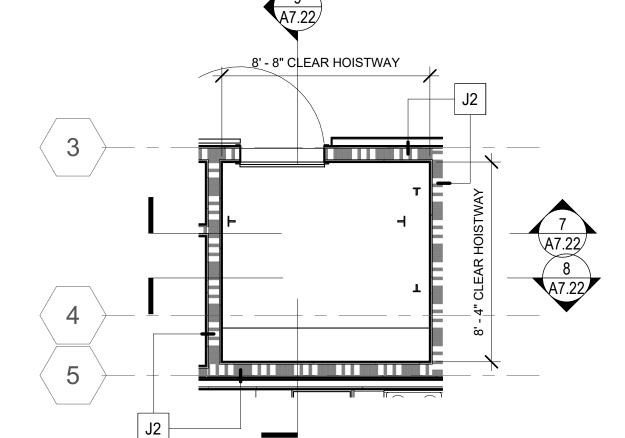




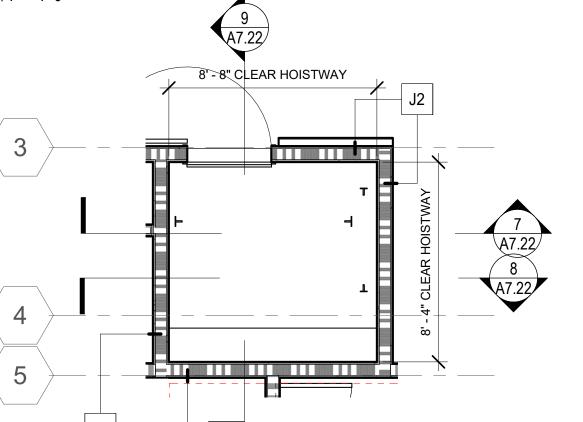

PSH 2 - LEVEL 2 - ENLARGED ELEVATOR 2

1/4" = 1'-0"

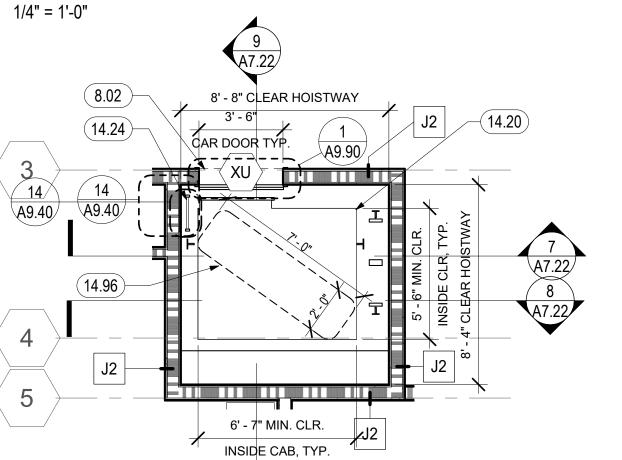

PSH 2 - LEVEL 1 - ENLARGED ELEVATOR 2

1 A9.40

INTERIOR


INTERIOR

FIRE RATING:

PLAN SYMBOL

FIRE RATING:

SOUND RATING:

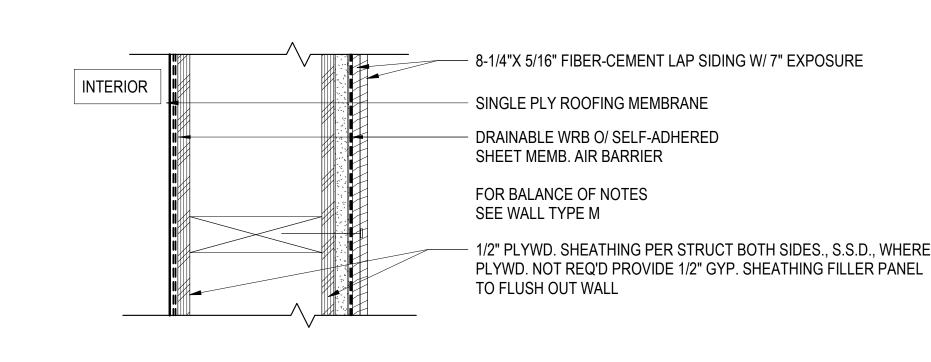

FOR PARAPET DETAIL, SEE (A8.31)

WALL TYPE Q - FIBER CEMENT PANEL @ PARAPET (FC-11, 6 FC-15, FC-18, FC-19)

NOT APPLICABLE

SOUND RATING: NOT APPLICABLE

7/8" EXT. CEMENT PLASTER SYSTEM O/ GALV. LATH 2 LAYERS DRAINABLE WRB O/ SELF-ADHERED SHEET MEMB. AIR BARRIER INTERIOR SINGLE PLY ROOFING MEMBRANE FOR BALANCE OF NOTES SEE WALL TYPE N TO FLUSH OUT WALL NOT APPLICABLE SOUND RATING: NOT APPLICABLE

7 WALL TYPE R - CEMENT PLASTER @ PARAPET (CP-13, CP-14, CP-15, CP-16)

1/2" PLYWD. SHEATHING PER STRUCT BOTH SIDES., S.S.D., WHERE PLYWD. NOT REQ'D PROVIDE 1/2" GYP. SHEATHING FILLER PANEL FOR PARAPET DETAIL, SEE  $\frac{4}{A8.31}$ 

WALL TYPE N - CEMENT PLASTER (CP-11, CP-12, CP-13, 2 CP-14, CP-15, CP-16, CP-17)
3" = 1'-0"

8-1/4"X 5/16" FIBER-CEMENT LAP SIDING W/ 7" EXPOSURE

5/8" TYPE X, EXTERIOR GYP. SHEATHING

1/2" PLYWD. SHEATHING PER STRUCT.,

1/2" GYP. SHEATHING FILLER PANEL TO

2X6 WOOD STUDS @ 16" O.C., TYP.

S.S.D., WHERE PLYWD. NOT REQ'D PROVIDE

MEMB. AIR BARRIER

FLUSH OUT WALL

R-19 BATT INSULATION

5/8" TYPE X, GYP. BD.

WALL TYPE M - FIBER CEMENT LAP SIDING (FC-13, FC-20)

5/8" TYPE X, GYPSUM BOARD

PANEL TO FLUSH OUT WALL

MIN. R-19 BATT THERMAL INSULATION

2X6 TYP. WOOD STUD @ 16"O.C. MAX.

1/2" PLYWD. SHEATHING PER STRUCT. S.S.D., WHERE PLYWD. NOT REQ'D PROVIDE 1/2" GYP. SHEATHING FILLER

2 LAYERS DRAINABLE WRB O/ SELF-ADHERED SHEET MEMB. AIR BARRIER

7/8" EXT. CEMENT PLASTER SYSTEM

O/ GALV. LATH. PLASTER MIX 1:4 FOR

BY VOLUME, CEMENT TO SAND

1 HOUR PER CBC *TABLE 721.1(2) ITEM - 15-1.3.* 

MIN STC 50 & MIN. ICC 50

FOR FLOOR/CEILING CONDITIONS, SEE 5 / A8.21 & 9 / A8.21

SCRATCH COAT AND 1:5 FOR BROWN COAT,

1 HOUR PER GA NO. WP8105

MIN STC 50 & MIN. ICC 50

FOR FLOOR/CEILING CONDITIONS, SEE 25 / A8.21 & 24 / A8.21

FLAT HEAD S.S. FASTENER

DRAINABLE WRB O/ SELF-ADHERED SHEET

5/8" TYPE X, GYPSUM BOARD INTERIOR MIN. R-19 BATT THERMAL INSULATION 5/8" TYPE X, EXTERIOR SHEATHING DRAINABLE WRB O/ SELF-ADHERED SHEET MEMB. AIR BARRIER FLUSH S.S. FLAT HEAD FASTENER, TYP. EA. SIDE VERTICAL ALUMINUM TRIM 5/16" FIBER-CEMENT PANEL 1/2" PLYWD. SHEATHING PER STRUCT., S.S.D., WHERE PLYWD. NOT REQ'D PROVIDE 1/2" GYP. SHEATHING FILLER PANEL TO FLUSH OUT WALL 2X6 WOOD STUDS @ 16" O.C., TYP.

MIN STC 50 & MIN. ICC 50


FOR FLOOR/CEILING CONDITIONS, SEE 19 / A8.21 & 20 / A8.21

1 HOUR PER GA NO. WP8105

WALL TYPE O - FIBER CEMENT PANEL (FC-11, FC-12, 3 FC-14, FC-15, FC-16, FC-17, FC-18, FC-19)

FLR. FIN. & UNDERLAYMENT, SEE SCHED., FOR TYP TRANSITION TO WALL LEVEL 1 \_\_\_\_\_\_\_\_\_\_\_ - PT CONCRETE SLAB, S.S.D. VAPOR BARRIER SUBGRADE TREATED PER GEOTECH REQUIREMENTS

H1 TYP. SLAB ASSEMBLY
3" = 1'-0"

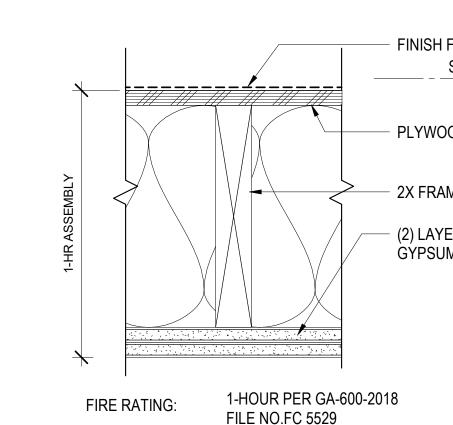

FLR FINISH AS SCHEDULED ACOUSTIC UNDERLAYMENT 1-1/4" GYPSUM CEMENT - TJI JOISTS, S.S.D. R-19 BATT INSULATION. PROVIDE MAX. 2" AIR GAP. (3) LAYERS 5/8" TYPE "X" GYP. BD. - 1/2" RESIL. CHANNELS @ 16" O.C. (1) LAYER 5/8" TYPE "X" GYP. BD. NOTE: ASSEMBLY OCCURS AT FIRE RATING: 2-HOUR PER GA FILE NO.FC 5750 FLOOR - CEILING CONDITIONS ABOVE TRASH ROOMS AND AT SOUND RATING: IIC RATING 50 STC MINIMUM

FIRE RATING: 1-HOUR PER GA FILE NO.FC 5241 NOTE: ASSEMBLY OCCURS AT

5/8" TYPE X, GYPSUM BOARD

INTERIOR

MIN. R-19 BATT THERMAL INSULATION

2X6 TYP. WOOD STUD @ 16"O.C. MAX.

1/2" PLYWD. SHEATHING PER STRUCT.,

2 LAYERS DRAINABLE WRB O/ SELF-ADHERED

O/ GALV. LATH. PLASTER MIX 1:4 FOR SCRATCH

COAT AND 1:5 FOR BROWN COAT, BY VOLUME,

S.S.D., WHERE PLYWD. NOT REQ'D PROVIDE 1/2" GYP. SHEATHING FILLER

7/8" EXT. CEMENT PLASTER SYSTEM

PANEL TO FLUSH OUT WALL

SHEET MEMB. AIR BARRIER

CEMENT TO SAND

8 WALL TYPE S - CEMENT PLASTER @ STAIRS & ELEVATOR @ ROOF (CP-13, CP-14)

FLR FINISH AS SCHEDULED

1-1/4" GYPCRETE

TJI JOISTS, S.S.D.

MAX. 2" AIR GAP.

1/4" ACOUSTICAL MAT

- 3/4" PLYWOOD SHEATHING, SSD

- R-19 BATT INSULATION. PROVIDE

1/2" RESIL. CHANNELS @ 16" O.C.

(2) LAYERS 5/8" TYPE "X" GYP. BD.

ERRCS ROOMS ONLY

FLOOR - CEILING CONDITIONS ABOVE DWELLING UNITS ONLY

1 HOUR PER CBC TABLE 721.1(2) ITEM - 15-1.3.

H5 2 HR. WOOD FLOOR ASSEMBLY
3" = 1'-0"

SOUND RATING: IIC RATING 54 STC 59 PER

TEST # 10106.20

TYPICAL WOOD FLOOR ASSEMBLY

**WALL TYPES GENERAL NOTES:** 

1. WALL TYPE DETAILS SHOWN IN PLAN VIEW U.O.N

RECESSED EQUIPMENT, ELECTRICAL BOXES, FIXTURES AND OTHER RECESSES SHALL BE CONSTRUCTED IN A MANNER TO MAINTAIN FIRE RATING, SEE A9.10, A9.11 A9.20 AND A9.30.

AT ACOUSTICALLY RATED ASSEMBLIES, RECESSED WALL FIXTURES SUCH AS MEDICINE CABINETS OR ELECTRICAL, TELEPHONE OR TELEVISION OUTLETS THAT PENETRATE THE GYPSUM BOARD, SHALL NOT BE LOCATED BACK TO BACK OR IN THE SAME STUD CAVITY. ALL OPENINGS SHALL BE SEALED TO MAINTAIN ACOUSTICAL PERFORMANCE OF THE ASSEMBLY.

FOR ACOUSTICALLY RATED ASSEMBLIES, FLEXIBLE SEALANT OR ACOUSTICAL GASKETS SHALL BE USED BETWEEN THE RATED ASSEMBLY

REFER TO PLANS FOR LOCATION OF FIRE RATED WALL ASSEMBLIES REFER TO EGRESS DIAGRAMS ON GENERAL SERIES SHEETS FOR COMPLETE DISTICTION OF TYPES OF WALLS. REFER TO LEGEND FOR COLOR CODING OF FIRE BARRIERS, FIRE PARTIONS AND REATED BEARING WALLS ON EGRESS DIAGRAMS.

REFER TO 23RD EDITION GA-600-2018 MANUAL FOR ASSEMBLIES LISTED WITH GA NUMBERS. WHERE ASSEMBLY IS LISTED AS "PROPRIETARY," PROVIDE PRODUCTS BY MANUFACTURERS LISTED IN GA FILE REFERENCED.

SEAL ALL PENETRATIONS IN FIRE RATED ASSEMBLIES, OFFSET ITEMS WHICH ARE BACK-TO-BACK. PROVIDE FIRESTOPPING AT ALL THROUGH PENETRATIONS AND MEMBRANE PENETRATIONS OF FIRE RATED WALLS (I.E. PARTY, BEARING, CORRIDOR, AREA). FIRESTOP MATERIALS SHALL BE U.L. CLASSIFIED FOR THE TYPE AND SIZE OF THE VOID TO BE FIRESTOPPED AND SHALL NOT BE LESS THAN THE REQUIRED FIRE RESISTANCE RATING OF THE ASSEMBLY BEING PENETRATED. PENETRATIONS IN NON-BEARING WALLS WITHIN RESIDENTIAL UNITS NEED NOT BE FIRESTOPPED. SEE MEP SHEETS FOR PENETRATION DETAILS.

FIRE AND SMOKE RATED ASSEMBLIES OR ANY OTHER WALL REQUIRED TO HAVE PROTECTED OPENINGS OR PENETRATIONS SHALL BE EFFECTIVELY AND PERMANENTLY IDENTIFIED WITH SIGNS OR STENCILING. MARKINGS SHALL BE LOCATED IN AN ACCESSIBLE CONCEALED FLOOR, FLOOR-CEILING OR ATTIC SPACE, AND BE REPEATED AT INTERVALS NOT EXCEEDING 30 FEET MEASURED HORIZONTALLY ALONG THE WALL OR PARTITIONS. THE LETTERING SHALL NOT BE LESS THAN .5 INCH IN HEIGHT, INCORPORATING THE SUGGESTED WORDING: "FIRE AND/OR SMOKE BARRIER - PROTECT ALL OPENINGS," OR OTHER WORDING PER CBC 703.7.



Alameda, CA 94501 JOB NO. **DRAWN Author** 

CHECKED Checker JOB CAPTAIN Approver

North Housing,


Block A


**ISSUE** DESCRIPTION 08/27/21 ENTITLEMENT SET 12/8/21 SD SET 03/22/22 | 100% DD SET 08/22/22 50% CD SET 09/29/22 | PERMIT SUBMITTAL 03/01/23 | Senior Resubmittal 2 | 03/01/23 | PSH 1 Resubmittal 3 | 03/01/23 | PSH 2 Resubmittal 1 5 | 04/28/23 | PSH 1 Resubmittal 2

6 04/28/23 PSH 2 Resubmittal 2 06/28/23 BID SET


DRAWING TITLE **EXTERIOR WALL** TYPES & HORIZONTAL **ASSEMBLIES** 

SCALE 3" = 1'-0"

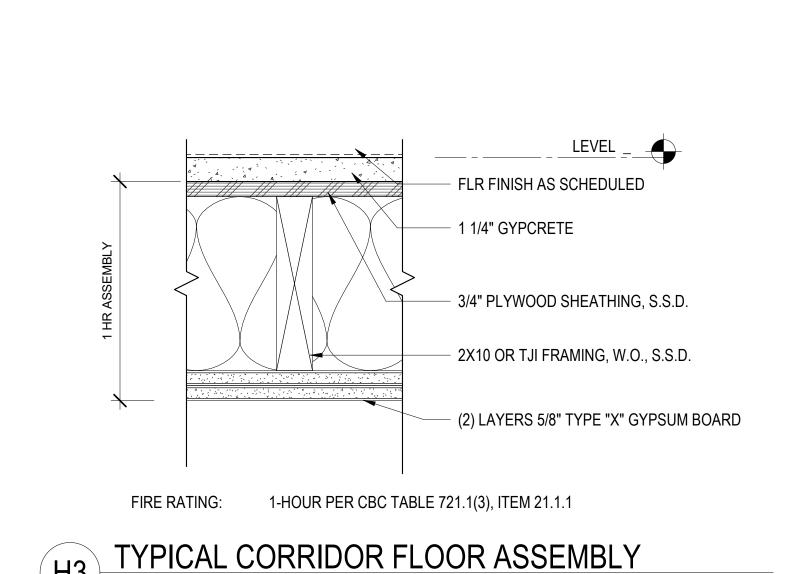

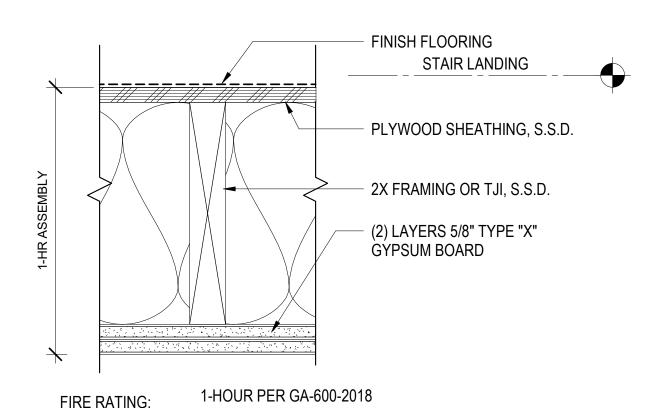

H4) TYPICAL INTERMEDIATE STAIR LANDING

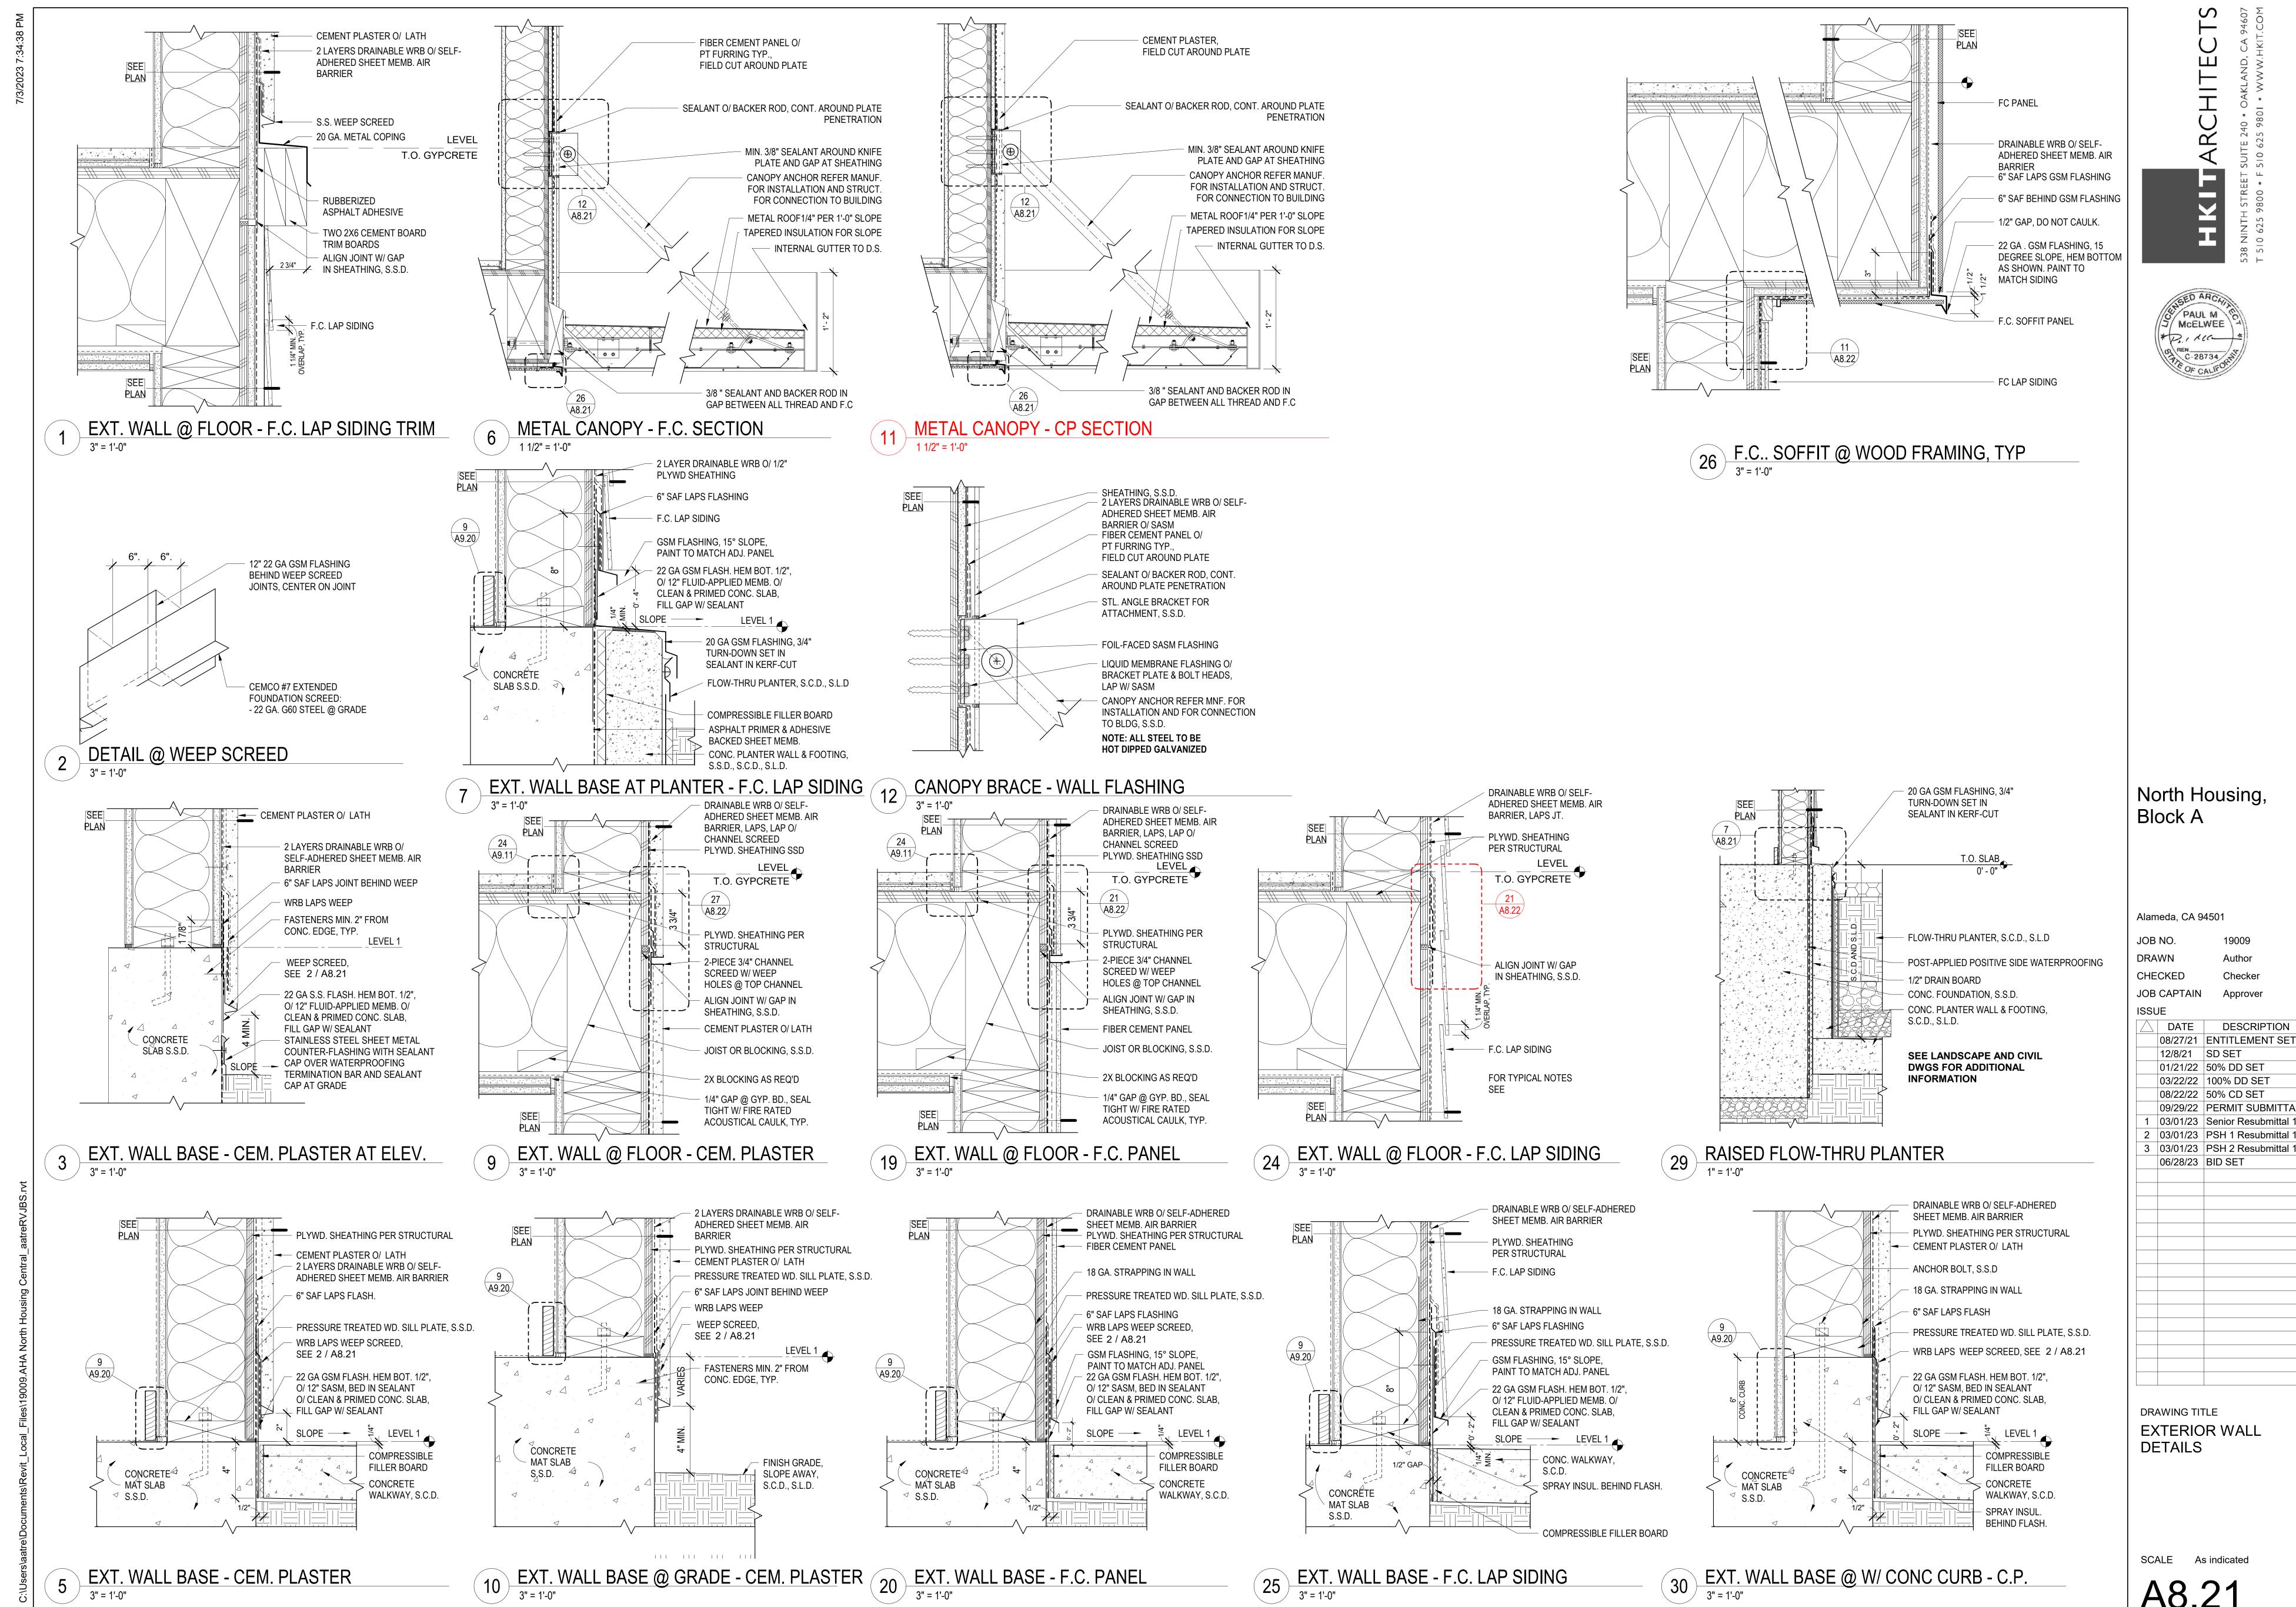

**Author** 

Checker Approver

08/27/21 ENTITLEMENT SET 01/21/22 50% DD SET 03/22/22 | 100% DD SET 08/22/22 | 50% CD SET


09/29/22 PERMIT SUBMITTAL 1 | 03/01/23 | Senior Resubmittal 1 2 | 03/01/23 | PSH 1 Resubmittal 1

COPYRIGHT © 2020 HKIT ARCHITECTS

COPYRIGHT © 2016 HKIT ARCHITECTS

SCALE As indicated

A8.23
COPYRIGHT © 2020 HKIT ARCHITECTS

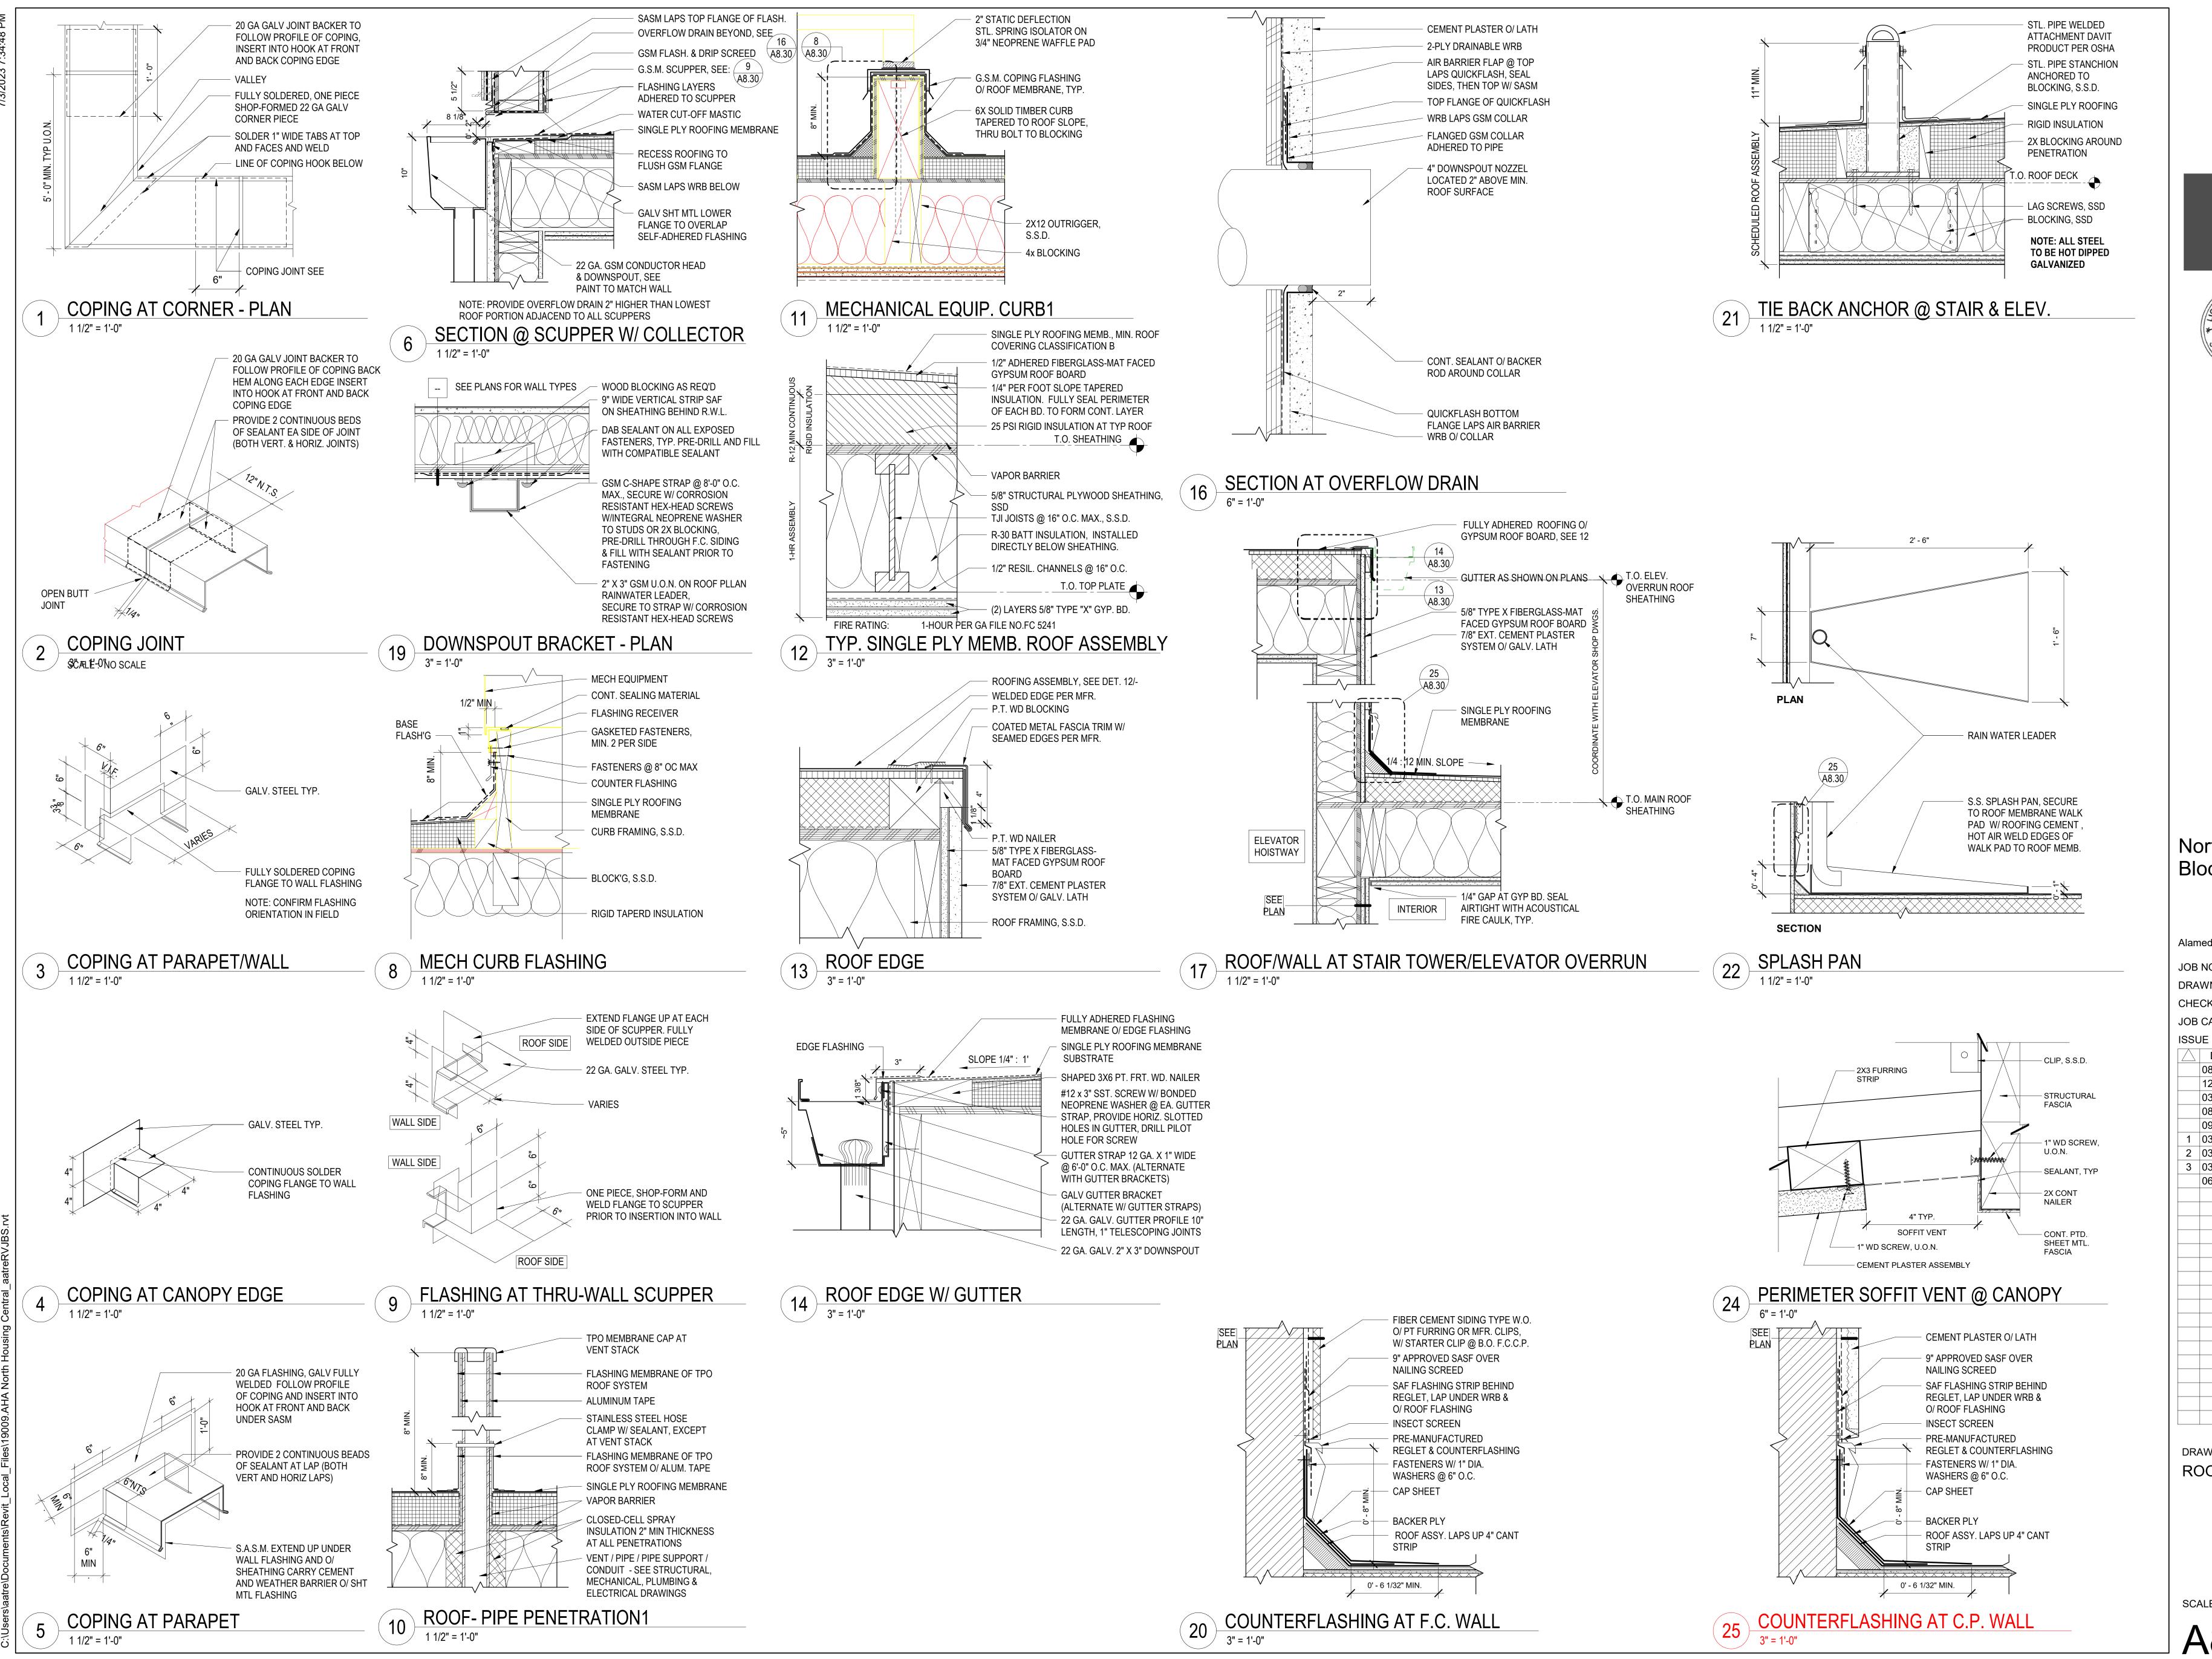



North Housing, Block A

Alameda, CA 94501

JOB NO. DRAWN

CHECKED

JOB CAPTAIN

DESCRIPTION 08/27/21 ENTITLEMENT SET 12/8/21 SD SET 03/22/22 | 100% DD SET

08/22/22 50% CD SET 09/29/22 PERMIT SUBMITTAL

03/01/23 | Senior Resubmittal 1 2 | 03/01/23 | PSH 1 Resubmittal 1


3 | 03/01/23 | PSH 2 Resubmittal 1


06/28/23 BID SET


DRAWING TITLE **ROOF DETAILS** 

SCALE As indicated


COPYRIGHT © 2016 HKIT ARCHITECTS

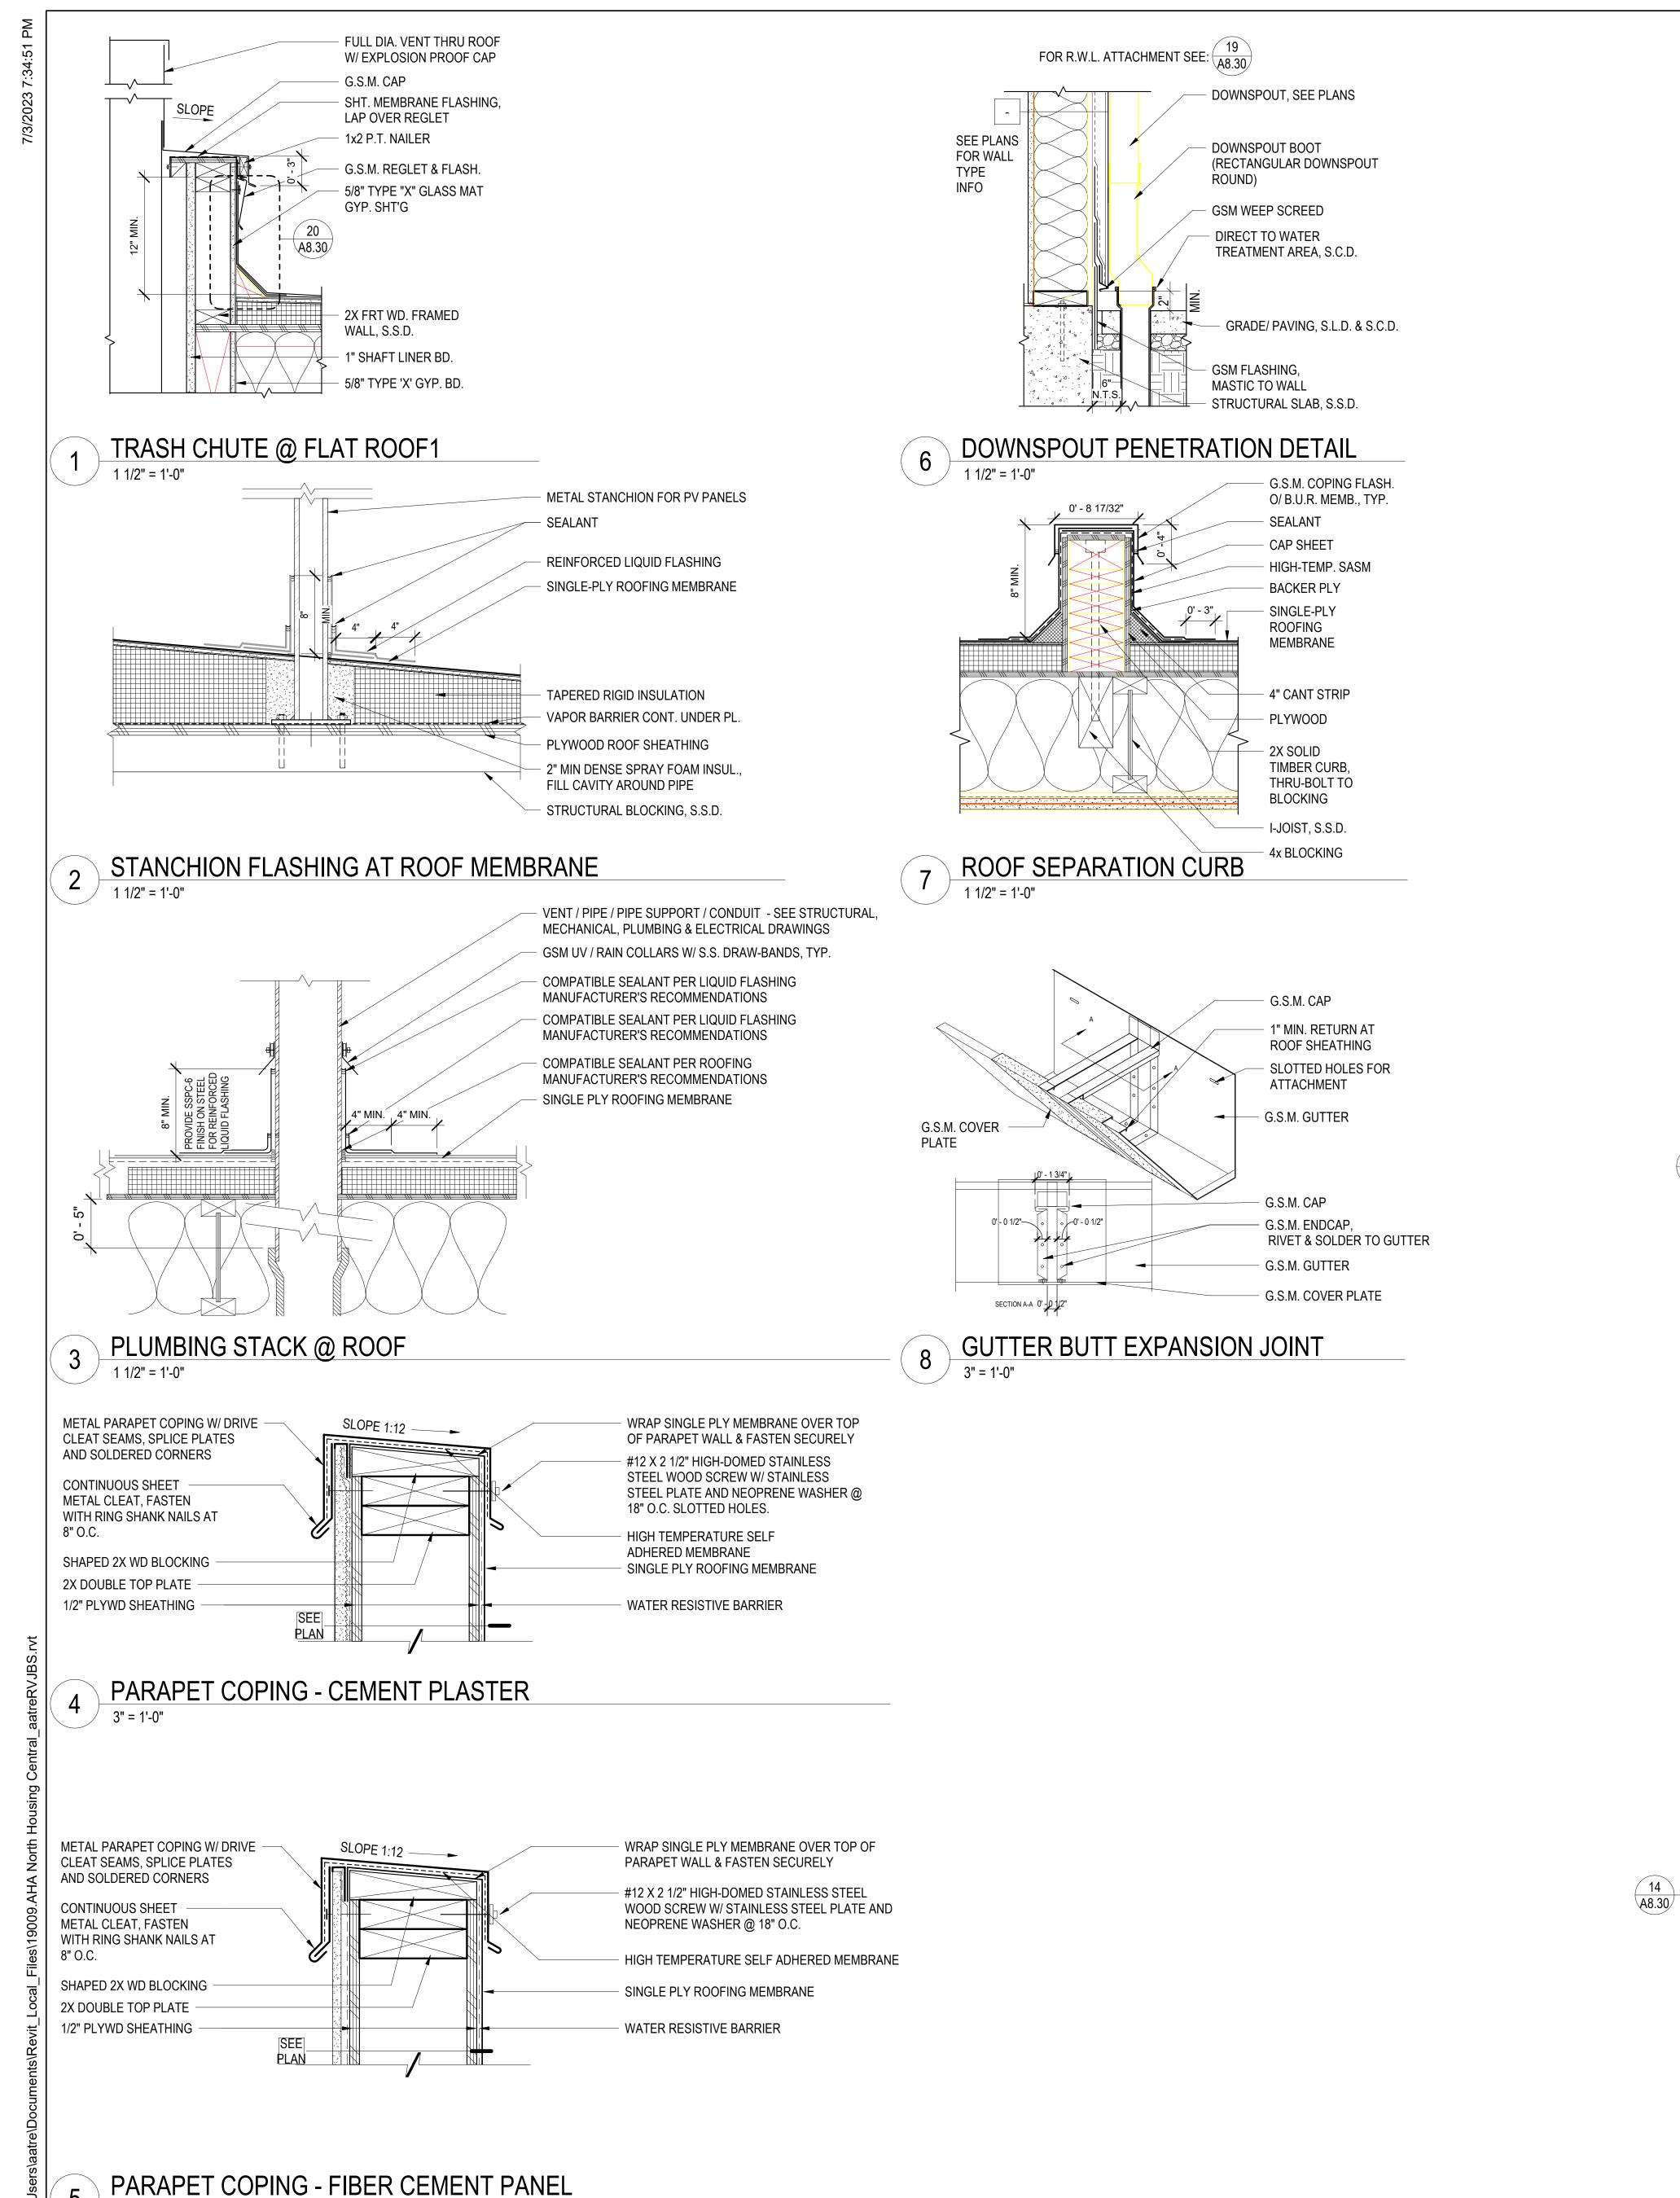

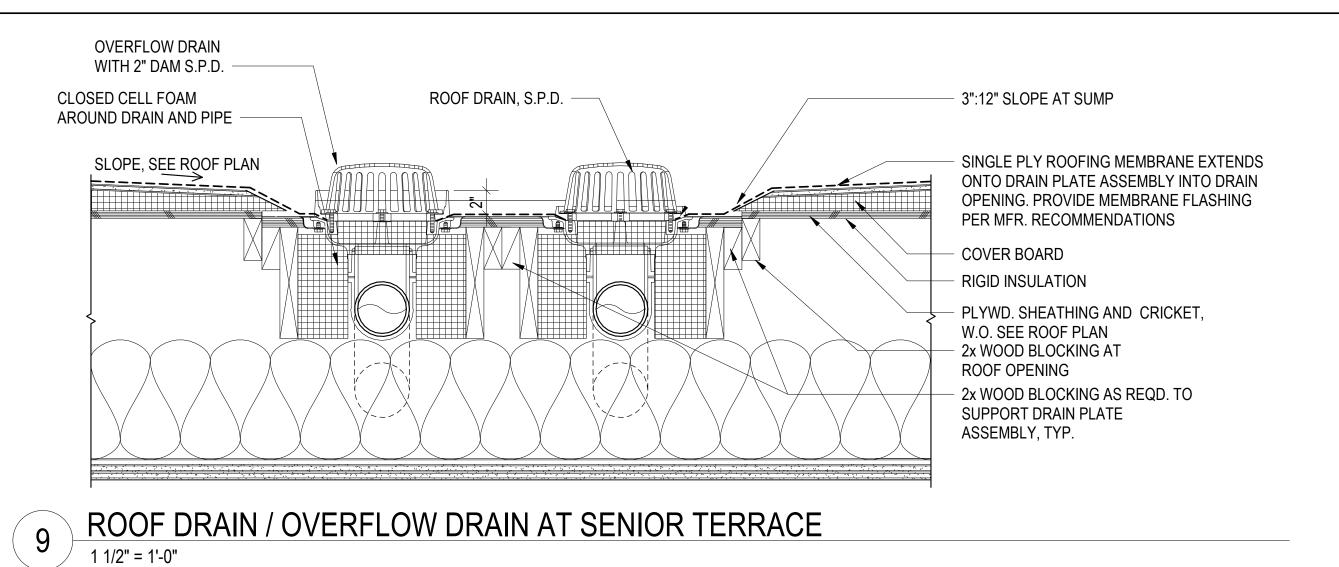

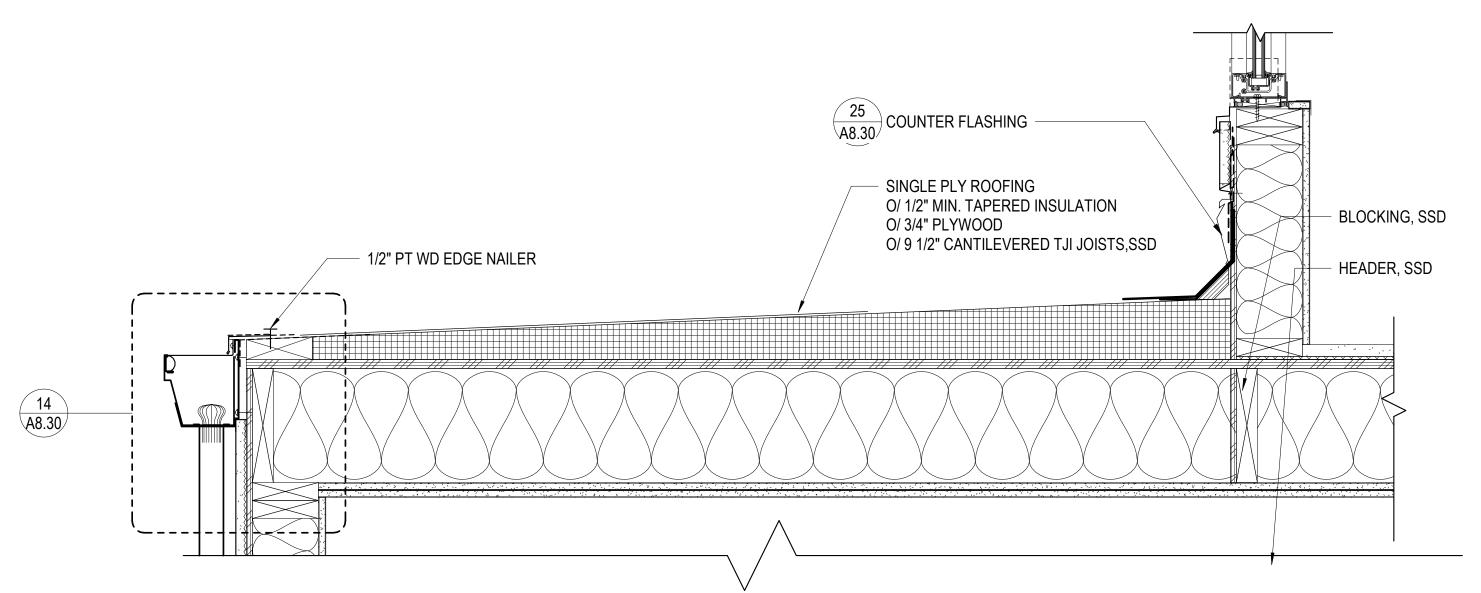

PSH 1 SOUTH LOBBY LOW ROOF

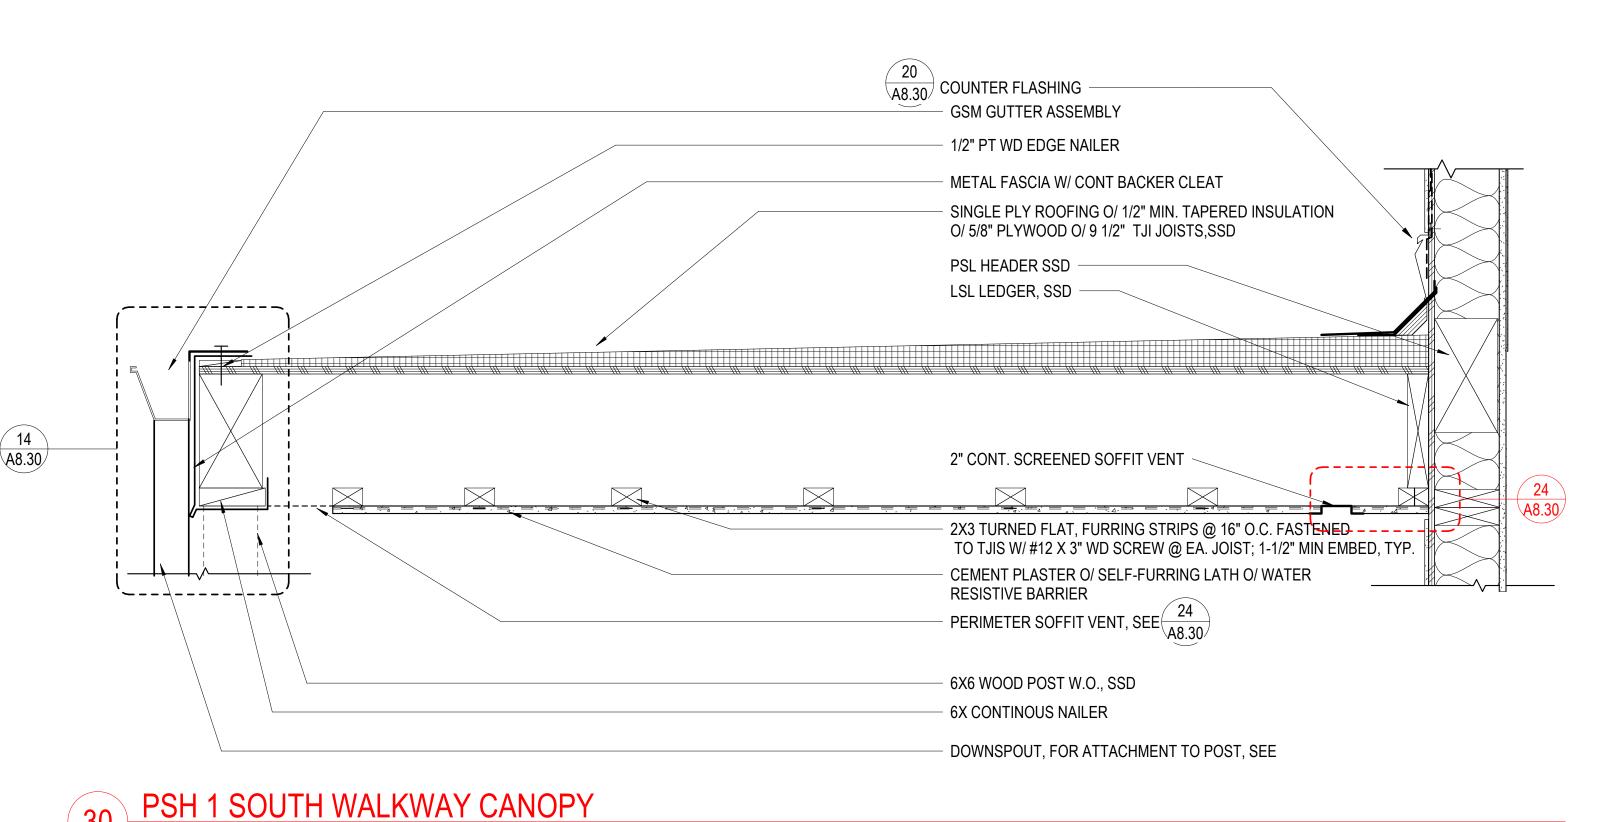

S38 NINTH STREET SUITE 240 • OAKLAND, CA 94607
T 510 625 9800 • F 510 625 9801 • WWW.HKIT.COM



# North Housing, Block A

Alameda, CA 94501

JOB NO. 19009
DRAWN Author
CHECKED Checker

JOB CAPTAIN ISSUE

 DATE
 DESCRIPTION

 08/27/21
 ENTITLEMENT SET

 12/8/21
 SD SET

 03/22/22
 100% DD SET

 08/22/22
 50% CD SET

 09/29/22
 PERMIT SUBMITTAL

 1
 03/01/23
 Senior Resubmittal 1

 2
 03/01/23
 PSH 1 Resubmittal 1

 3
 03/01/23
 PSH 2 Resubmittal 1


 06/28/23
 BID SET

Approver

DRAWING TITLE
ROOF DETAILS

SCALE As indicated

A8.31

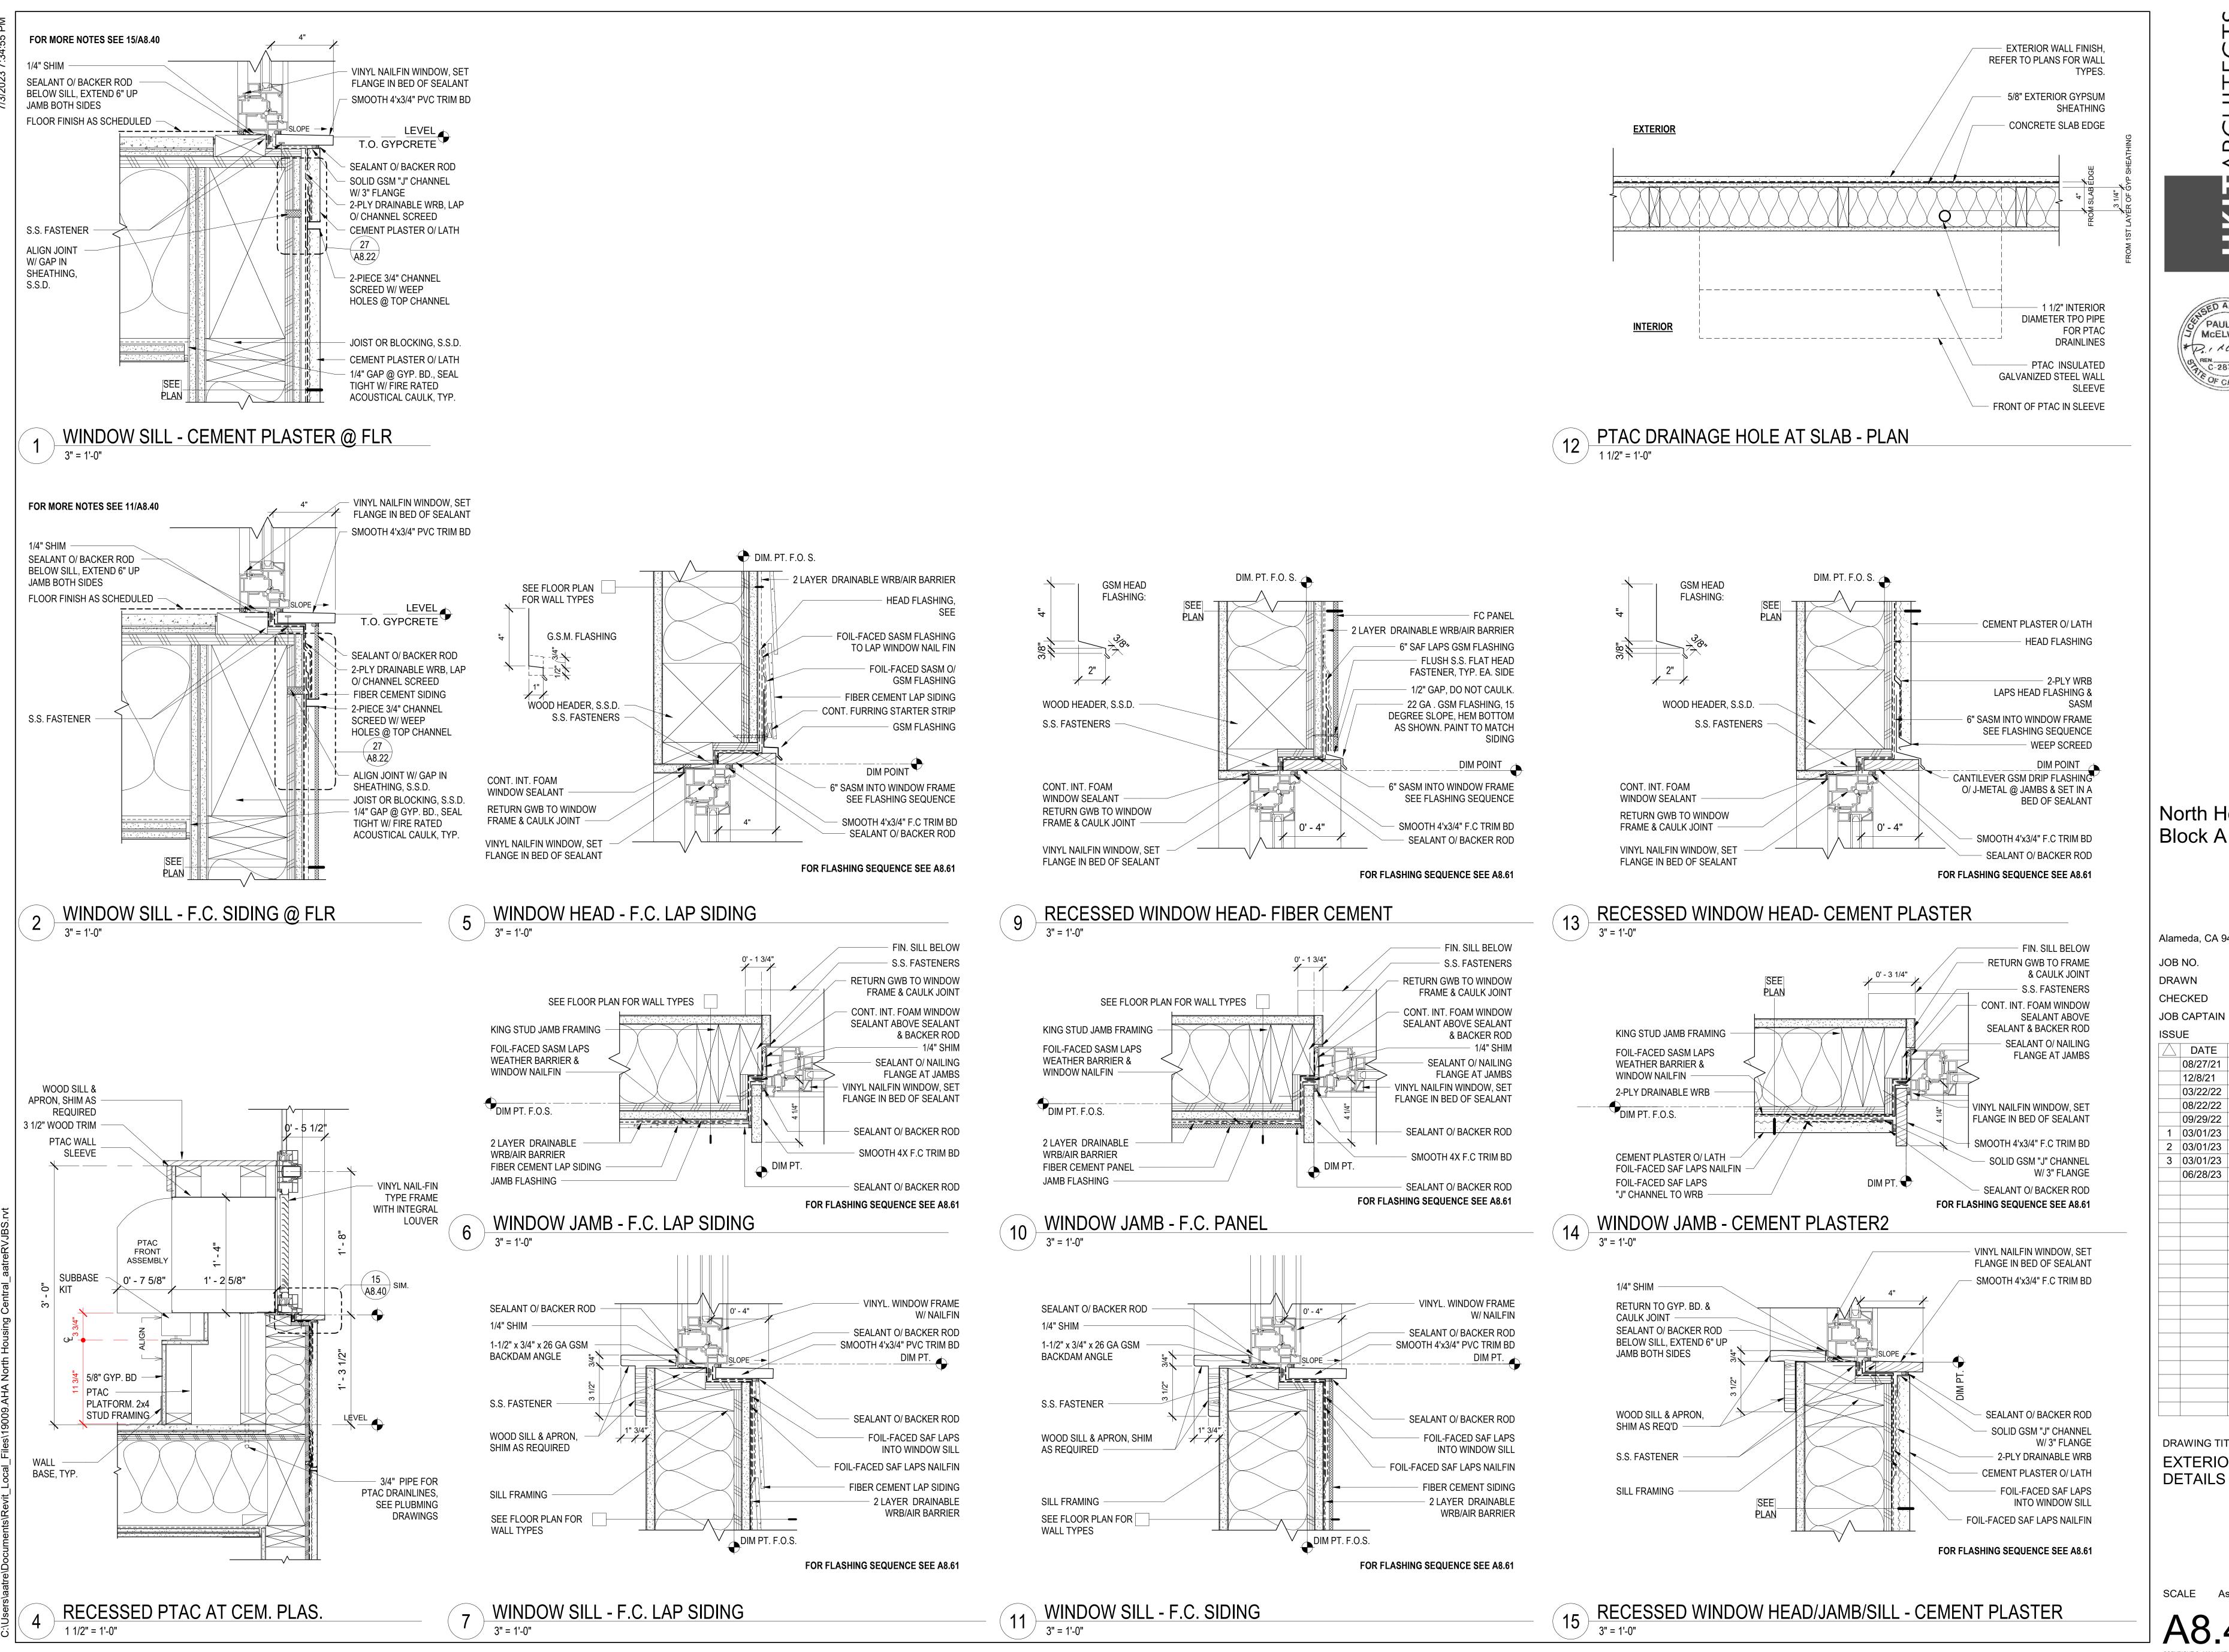

MCELWEE

North Housing, Block A

Alameda, CA 94501

JOB NO.

19009 **Author** 

Checker

JOB CAPTAIN Approver


DATE DESCRIPTION 08/27/21 ENTITLEMENT SET 12/8/21 SD SET 03/22/22 | 100% DD SET 08/22/22 50% CD SET

09/29/22 PERMIT SUBMITTAL 03/01/23 | Senior Resubmittal 1 2 03/01/23 PSH 1 Resubmittal 1 3 03/01/23 PSH 2 Resubmittal 1

06/28/23 BID SET

DRAWING TITLE **EXTERIOR WINDOW** 

SCALE As indicated

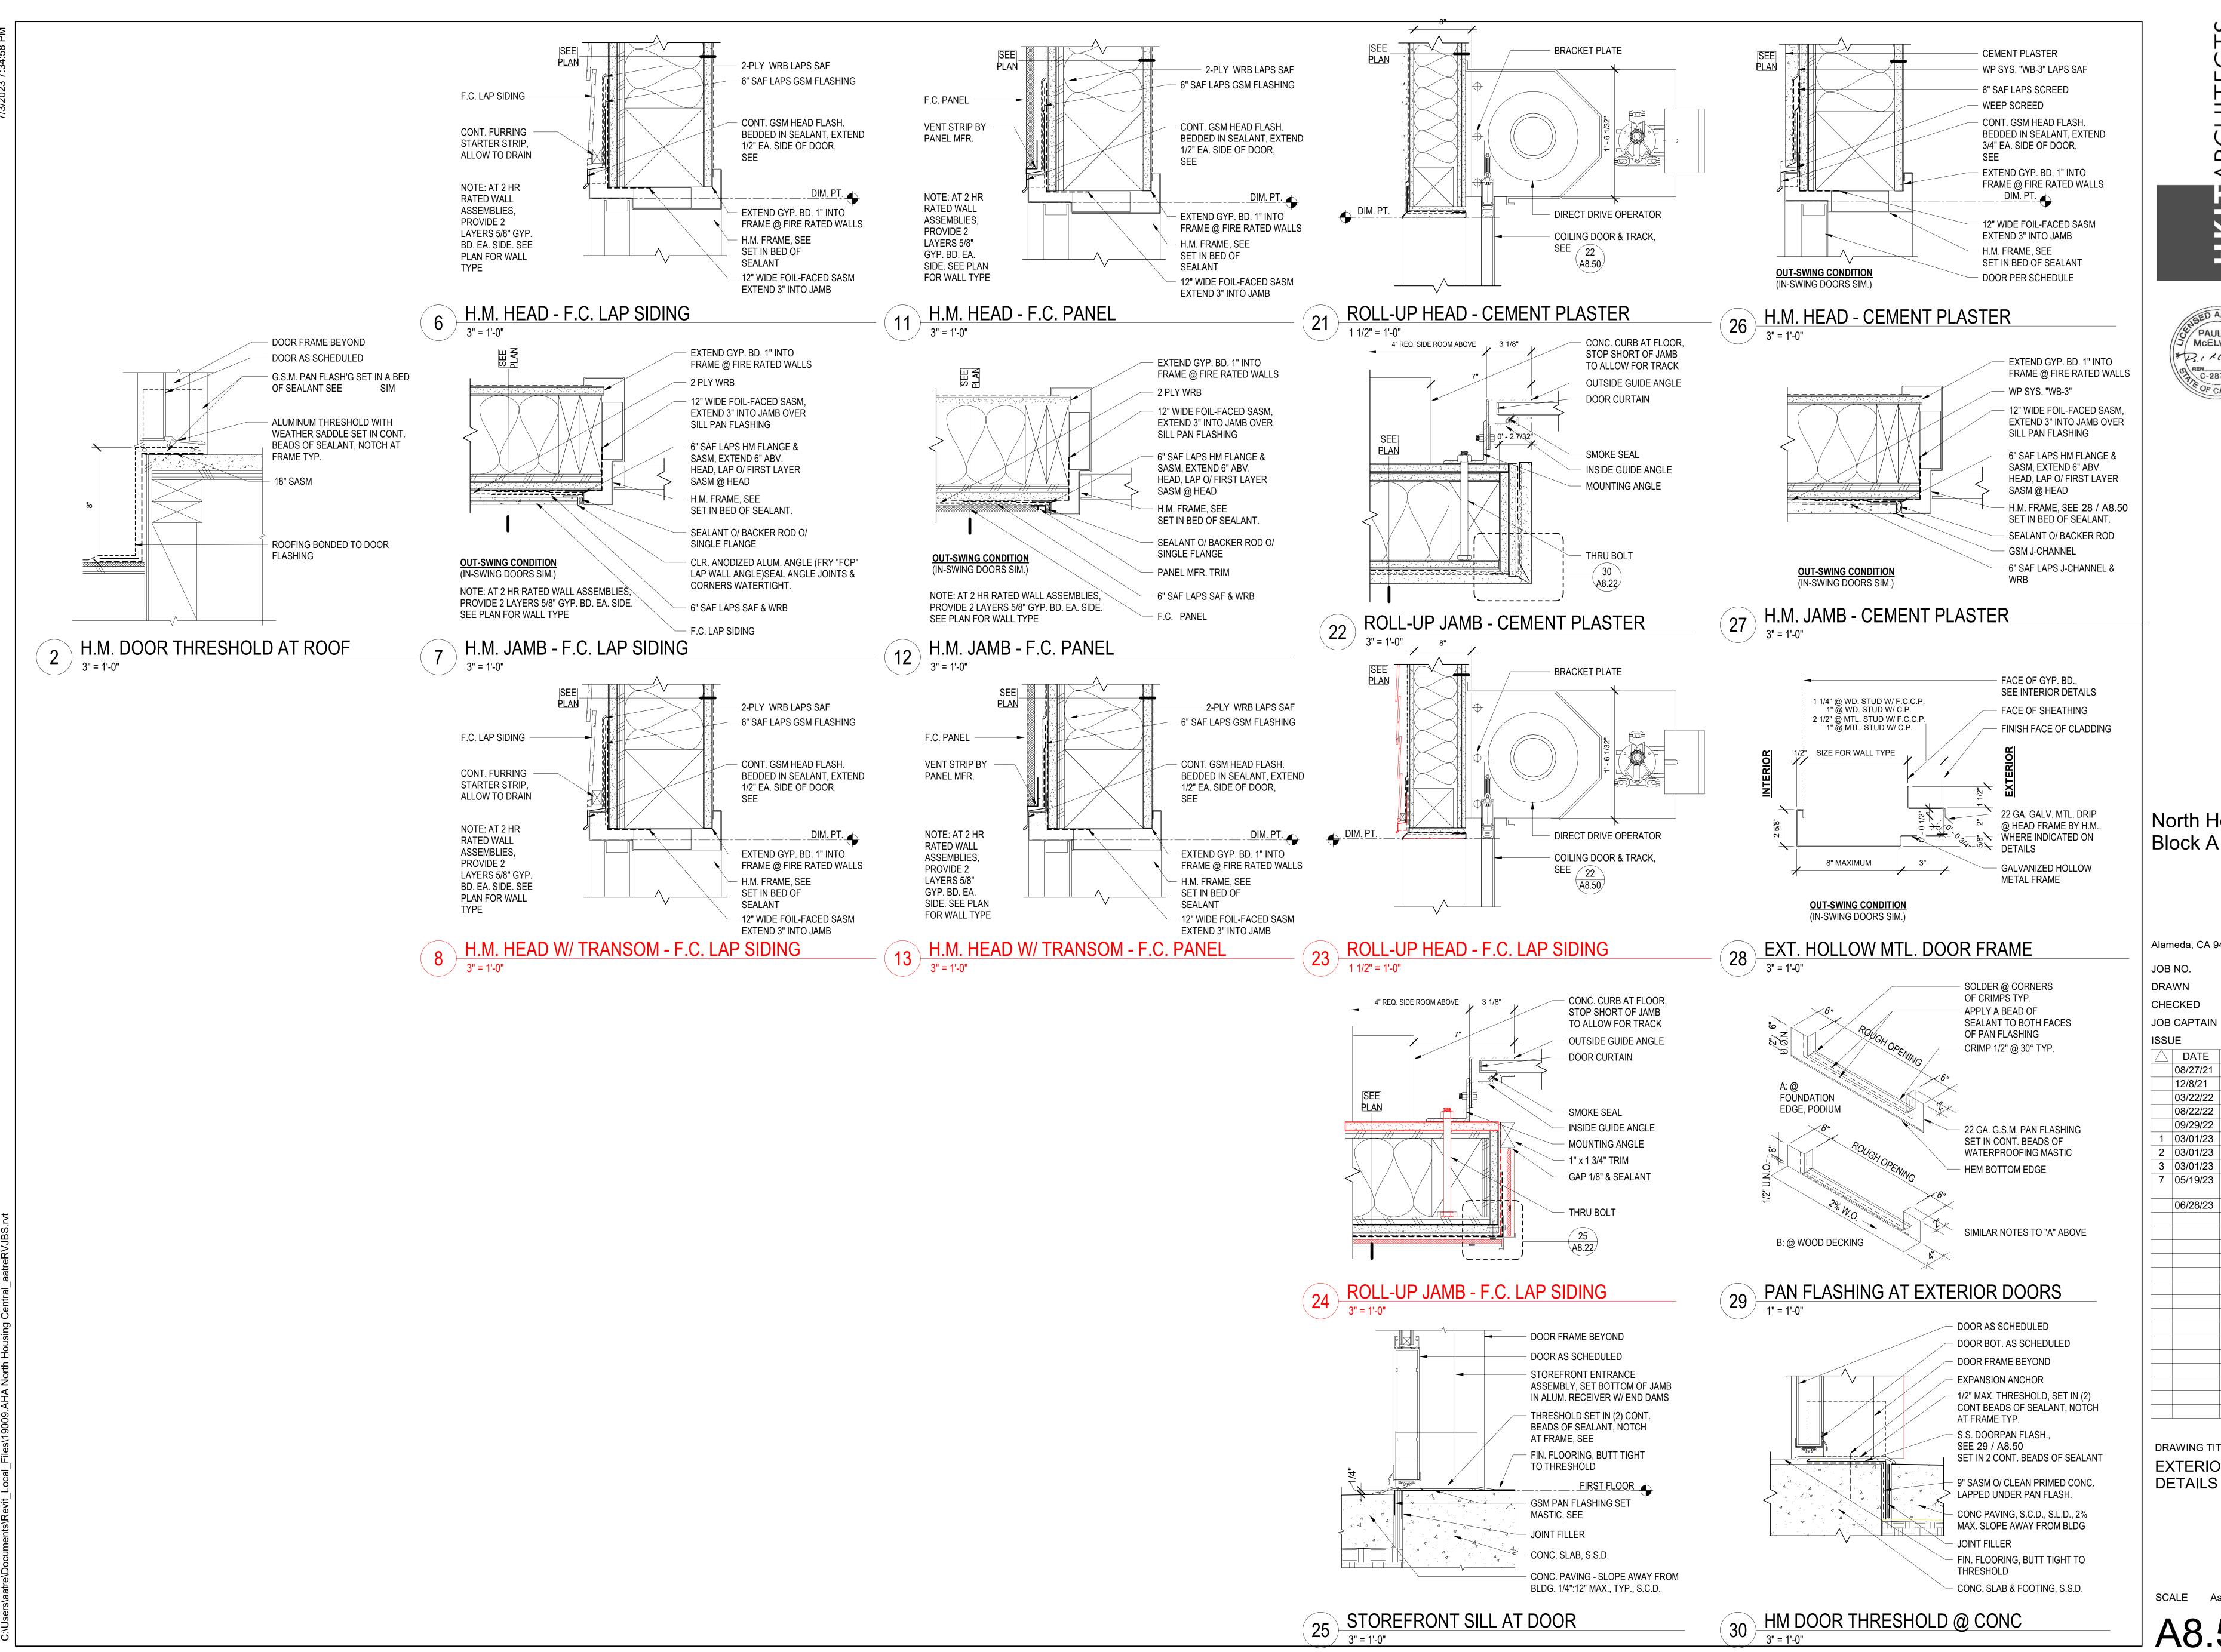

PAUL M MCELWEE \*PS. 1 ACC OF CALIFOR

North Housing, Block A

Alameda, CA 94501 JOB NO.

**Author** DRAWN

CHECKED Checker JOB CAPTAIN Approver

**ISSUE** 

DESCRIPTION 08/27/21 ENTITLEMENT SET 12/8/21 SD SET 03/22/22 | 100% DD SET

08/22/22 50% CD SET 09/29/22 PERMIT SUBMITTAL 03/01/23 | Senior Resubmittal 1 2 | 03/01/23 | PSH 1 Resubmittal 1

3 | 03/01/23 | PSH 2 Resubmittal 1 7 | 05/19/23 | PSH 1&2 Resubmittal

06/28/23 BID SET

DRAWING TITLE **EXTERIOR DOOR** 

SCALE As indicated

COPYRIGHT © 2020 HKIT ARCHITECTS

GED ARCA PAUL M MCELWEE 18.1 ACC OF CALIFORN

North Housing,

Alameda, CA 94501

**Author** Checker

Approver

DESCRIPTION 01/21/22 | 50% DD SET 03/22/22 | 100% DD SET

09/29/22 PERMIT SUBMITTAL 1 | 03/01/23 | Senior Resubmittal 1

2 | 03/01/23 | PSH 1 Resubmittal 1 3 | 03/01/23 | PSH 2 Resubmittal 1

7 | 05/19/23 | PSH 1&2 Resubmittal

STOREFRONT

SCALE As indicated

STARTER LAYER OF

WEATHER BARRIER

SILL FLASHING-

FLASHING

PRE-MANF. CORNER

SECOND LAYER OF SILL FLASHING

JAMB FLASHING

NAIL HEADS SET

FLUSH WITH FACE OF SHEATHING

STARTER LAYER

SASM SILL FLASHING

STEP 2: SILL FLASHING

OF WEATHER BARRIER

SHEATHING




AND ASTM E2112 STANDARDS. MANUFACTURER APPROVED FASTENERS SHALL BE DRIVEN STRAIGHT AND BE FLUSH SO TO NOT DAMAGE INSTALLED FLASHING MATERIALS EXTERIOR FINISH FASTENERS SHALL NOT PENETRATE MAILING FLANGES.

WINDOWS SHALL BE INSTALLED PLUMB, LEVEL AND SQUARE SO NOT TO AFFECT THEIR REQUIREMENT OF OPERATION.

THE CONTRACTOR IS REPSONSIBLE FOR PROTECTION OF FLASHING MATERIALS FROM WEATHER, OTHER TRADES, AND/OR VANDALISM. ADDITIONALLY, THE GENERAL CONTRACTOR IS RESPONSIBLE FOR INTEGRATING TRADE INSTALLED FLASHING SYSTEMS TO PROVIDE A WEATHER RESITANT ENVELOPE

4. PROVIDE MOCK-UP FOR RECESSED WINDOWS FOR EACH WALL CLADDING TYPE.

ENSURE APPROPRIATE "J" AND "V" ROLLERS ARE UTILIZED IN EACH STEP AS APPROPRAITE TO ACOID ANY FISH MOUTHS OR VOIDS

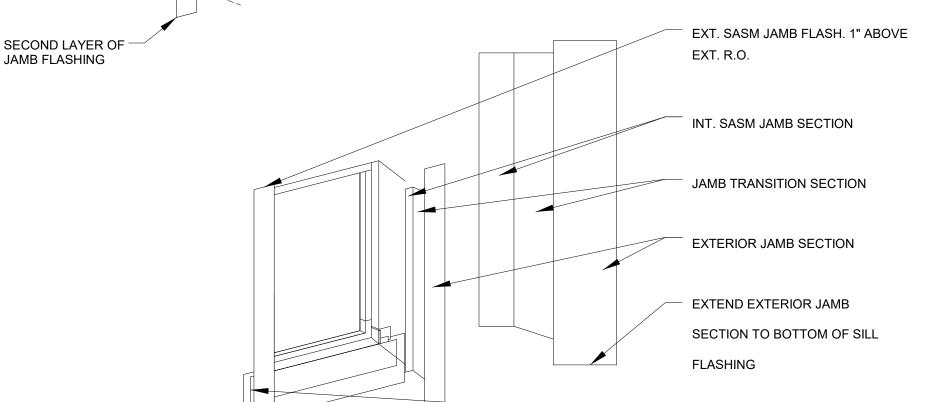

SASM CORNER FLASHING

**HEAD FLASHING** 

WINDOW HEAD FLASHING, SEE


AXONOMETRIC ON THIS SHEET

TRIM SILL FLASHING ONCE

JAMB IN PLACE


STEP 1: STARTER LAYER OF WEATHER BARRIER

RECESSED WINDOW FLASHING COMPONENTS

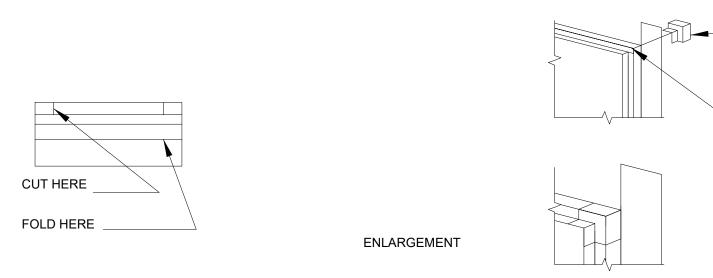

CORNER FLASHING


JAMB FLASHING

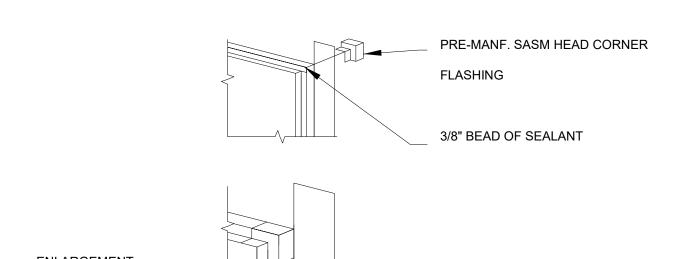


STEP 6: HEAD INSIDE CORNER FLASHING

STEP 7: INSTALL WINDOW

STEP 5: INSTALL JAMB FLASHING

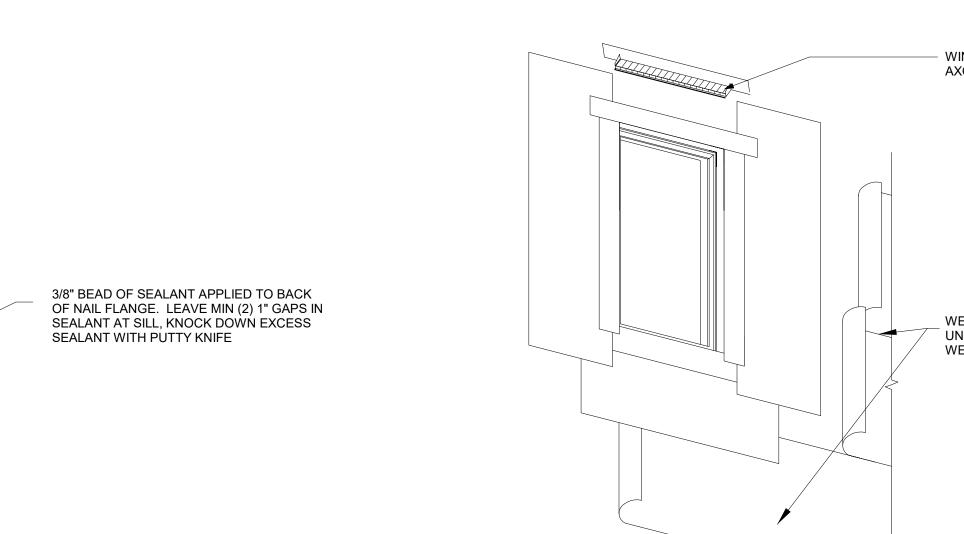

STEP 11: BUILDING PAPER INTEGRATION

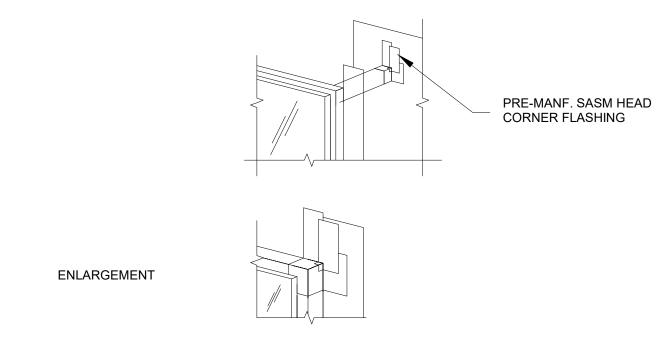

STEP 8: SECOND LAYER OF JAMB FLASHING


APPLY SECOND LAYER OF SASM


CORNERS OF RECESS OPENING

WEATHER BARRIER, HELD 2" FROM


JAMB FLASHING O/ STARTER


#### STEP 9: HEAD OUTSIDE CORNER FLASHING

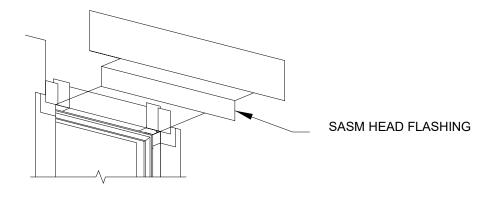

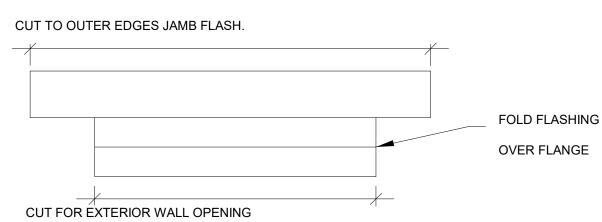


STEP 10: HEAD FLASHING

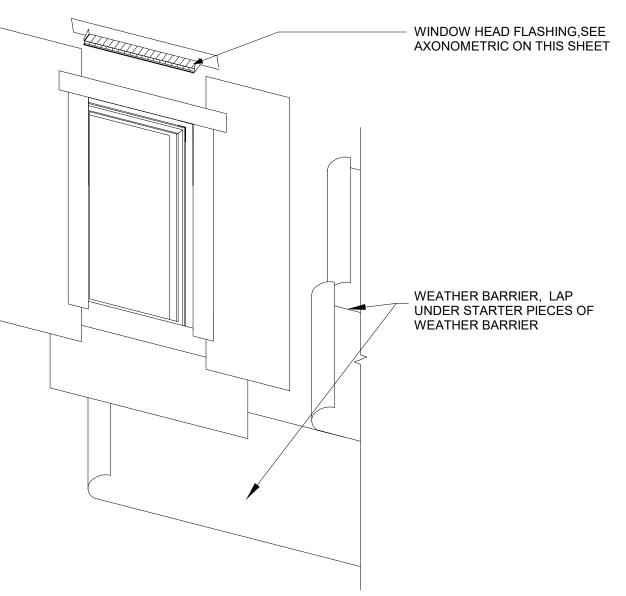


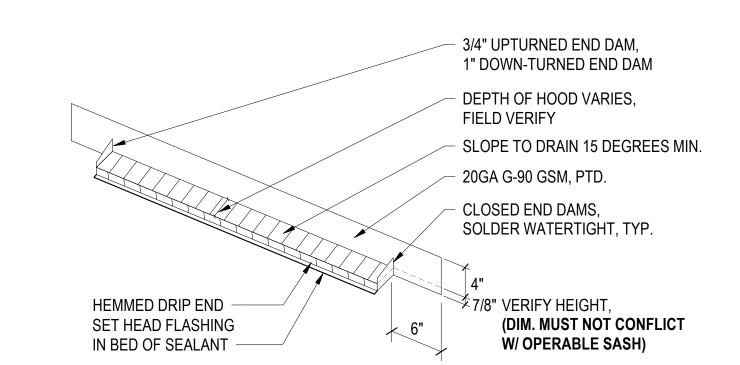



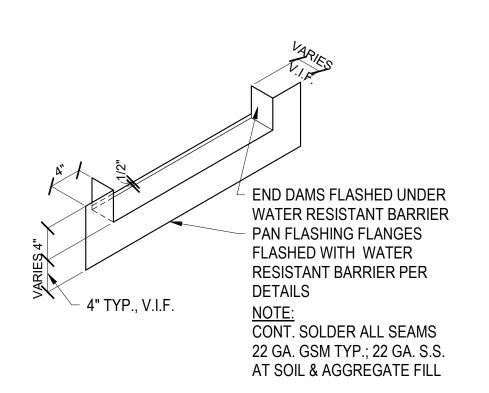

# PAN FLASHING AT STOREFRONT TYPE WINDOWS

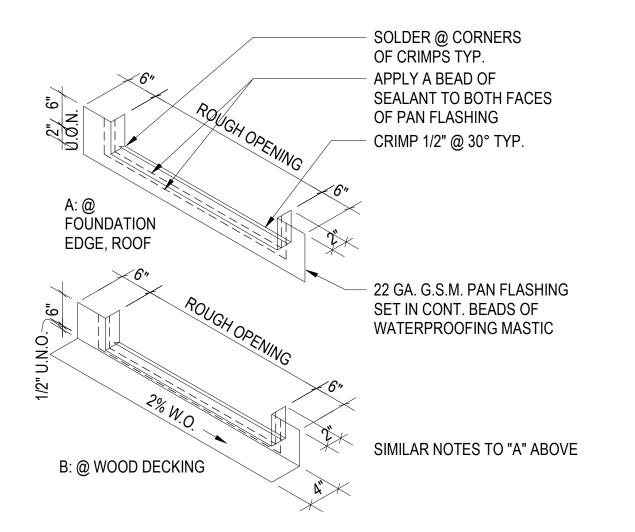

3 PAN FLASHING AT EXTERIOR DOORS1

Block A

North Housing,

Alameda, CA 94501

JOB NO. DRAWN CHECKED


JOB CAPTAIN

ISSUE DESCRIPTION 01/21/22 50% DD SET 03/22/22 | 100% DD SET 08/22/22 | 50% CD SET 09/29/22 PERMIT SUBMITTAL

1 | 03/01/23 | Senior Resubmittal 1 2 | 03/01/23 | PSH 1 Resubmittal 1 3 | 03/01/23 | PSH 2 Resubmittal 1 7 05/19/23 PSH 1&2 Resubmittal

06/28/23 BID SET

DRAWING TITLE **OPENING FLASHING DETAILS** 

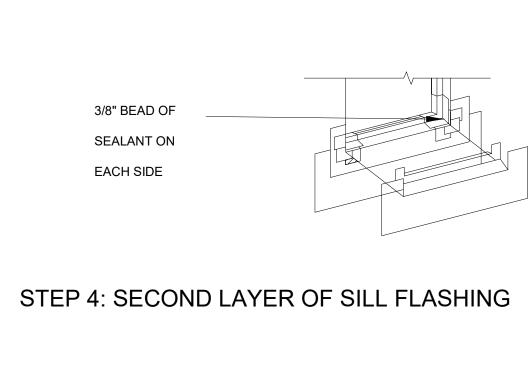


WINDOW FLASHING SYSTEM (RECESSED WINDOWS)


PRE-MANF. CORNER FLASHING

ENLARGEMENT STEP 3.1 ENLARGEMENT STEP 3.2

**ENLARGEMENT** 

STEP 3: SILL CORNER FLASHING

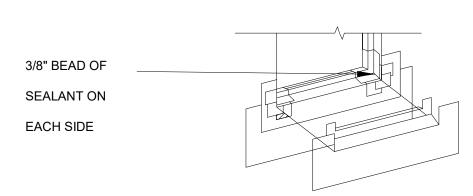

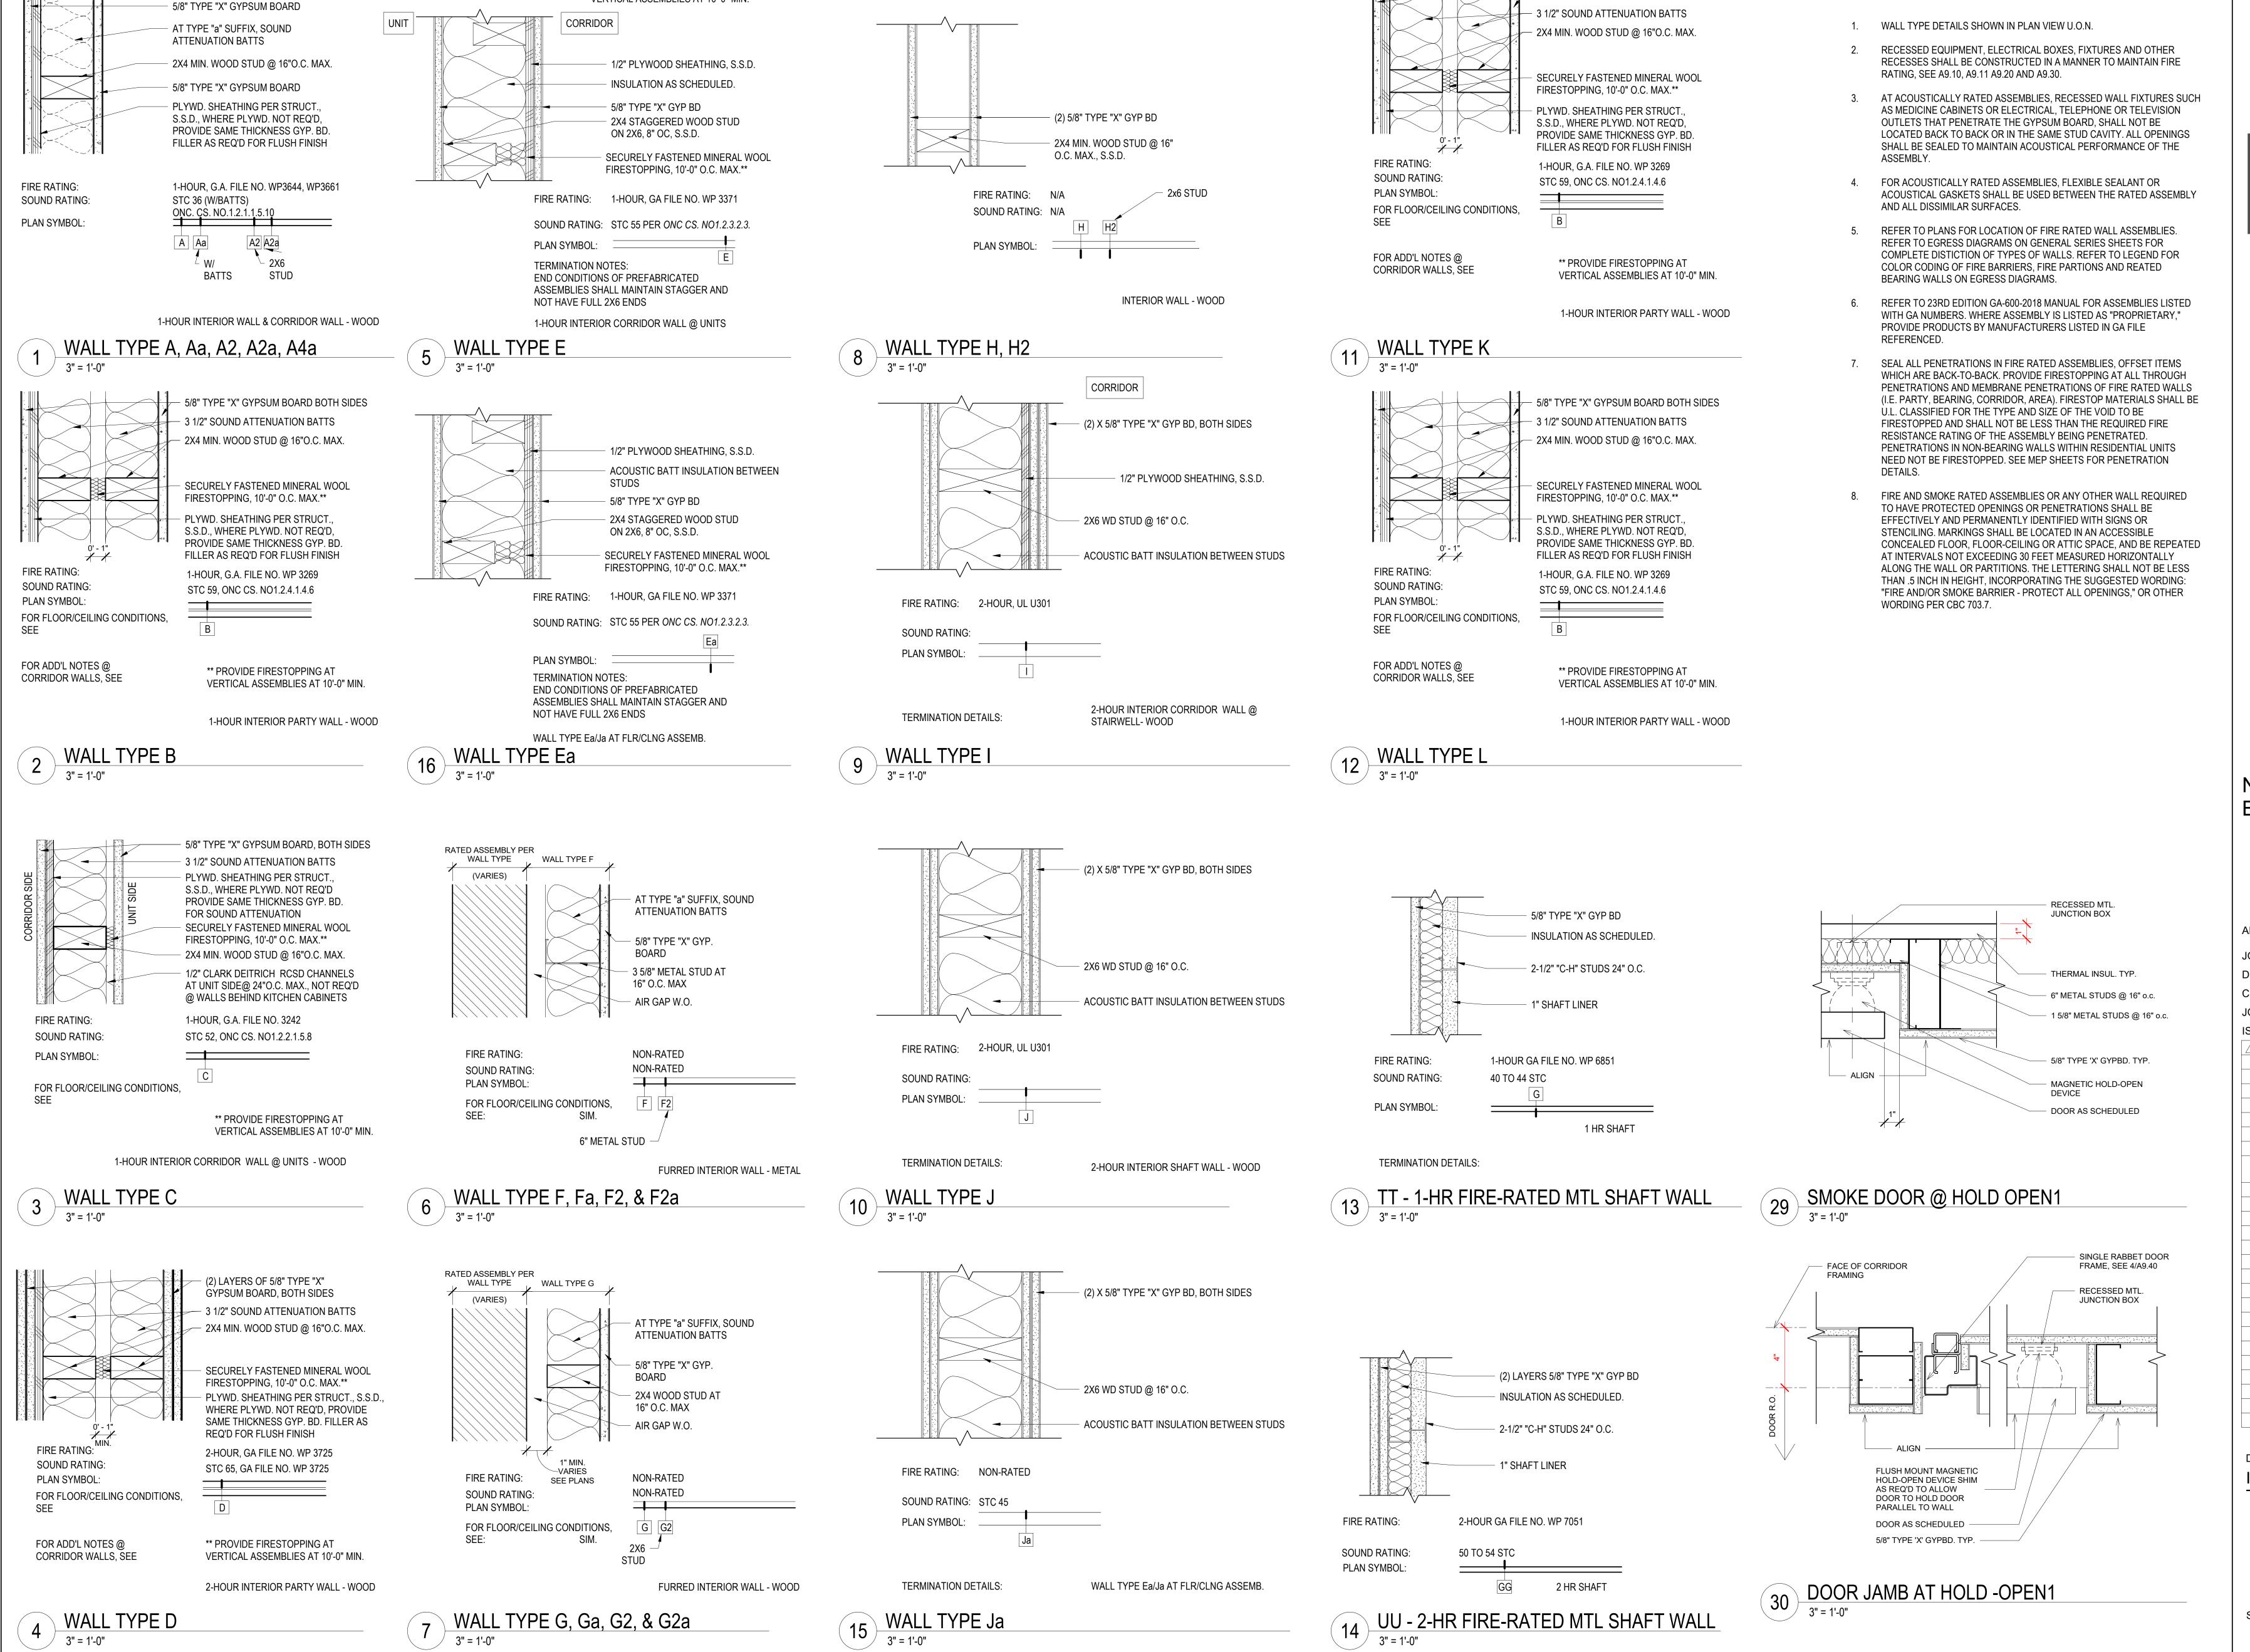

\*\* PROVIDE FIRESTOPPING AT

VERTICAL ASSEMBLIES AT 10'-0" MIN.

**WALL TYPES GENERAL NOTES:** 

5/8" TYPE "X" GYPSUM BOARD BOTH SIDES

GED ARCA PAUL M

MCELWEE

\* P3.1 1.CC-

OF CALIFORN

North Housing, Block A

Alameda, CA 94501 JOB NO.

**DRAWN Author** 

CHECKED JOB CAPTAIN

**ISSUE** 

DESCRIPTION 01/21/22 | 50% DD SET

03/22/22 | 100% DD SET 08/22/22 | 50% CD SET

Checker

Approve

09/29/22 PERMIT SUBMITTAL

03/01/23 | Senior Resubmittal 1 2 | 03/01/23 | PSH 1 Resubmittal


3 | 03/01/23 | PSH 2 Resubmittal 1

7 | 05/19/23 | PSH 1&2 Resubmittal

06/28/23 BID SET


DRAWING TITLE INTERIOR WALL **TYPES** 


SCALE 3" = 1'-0"

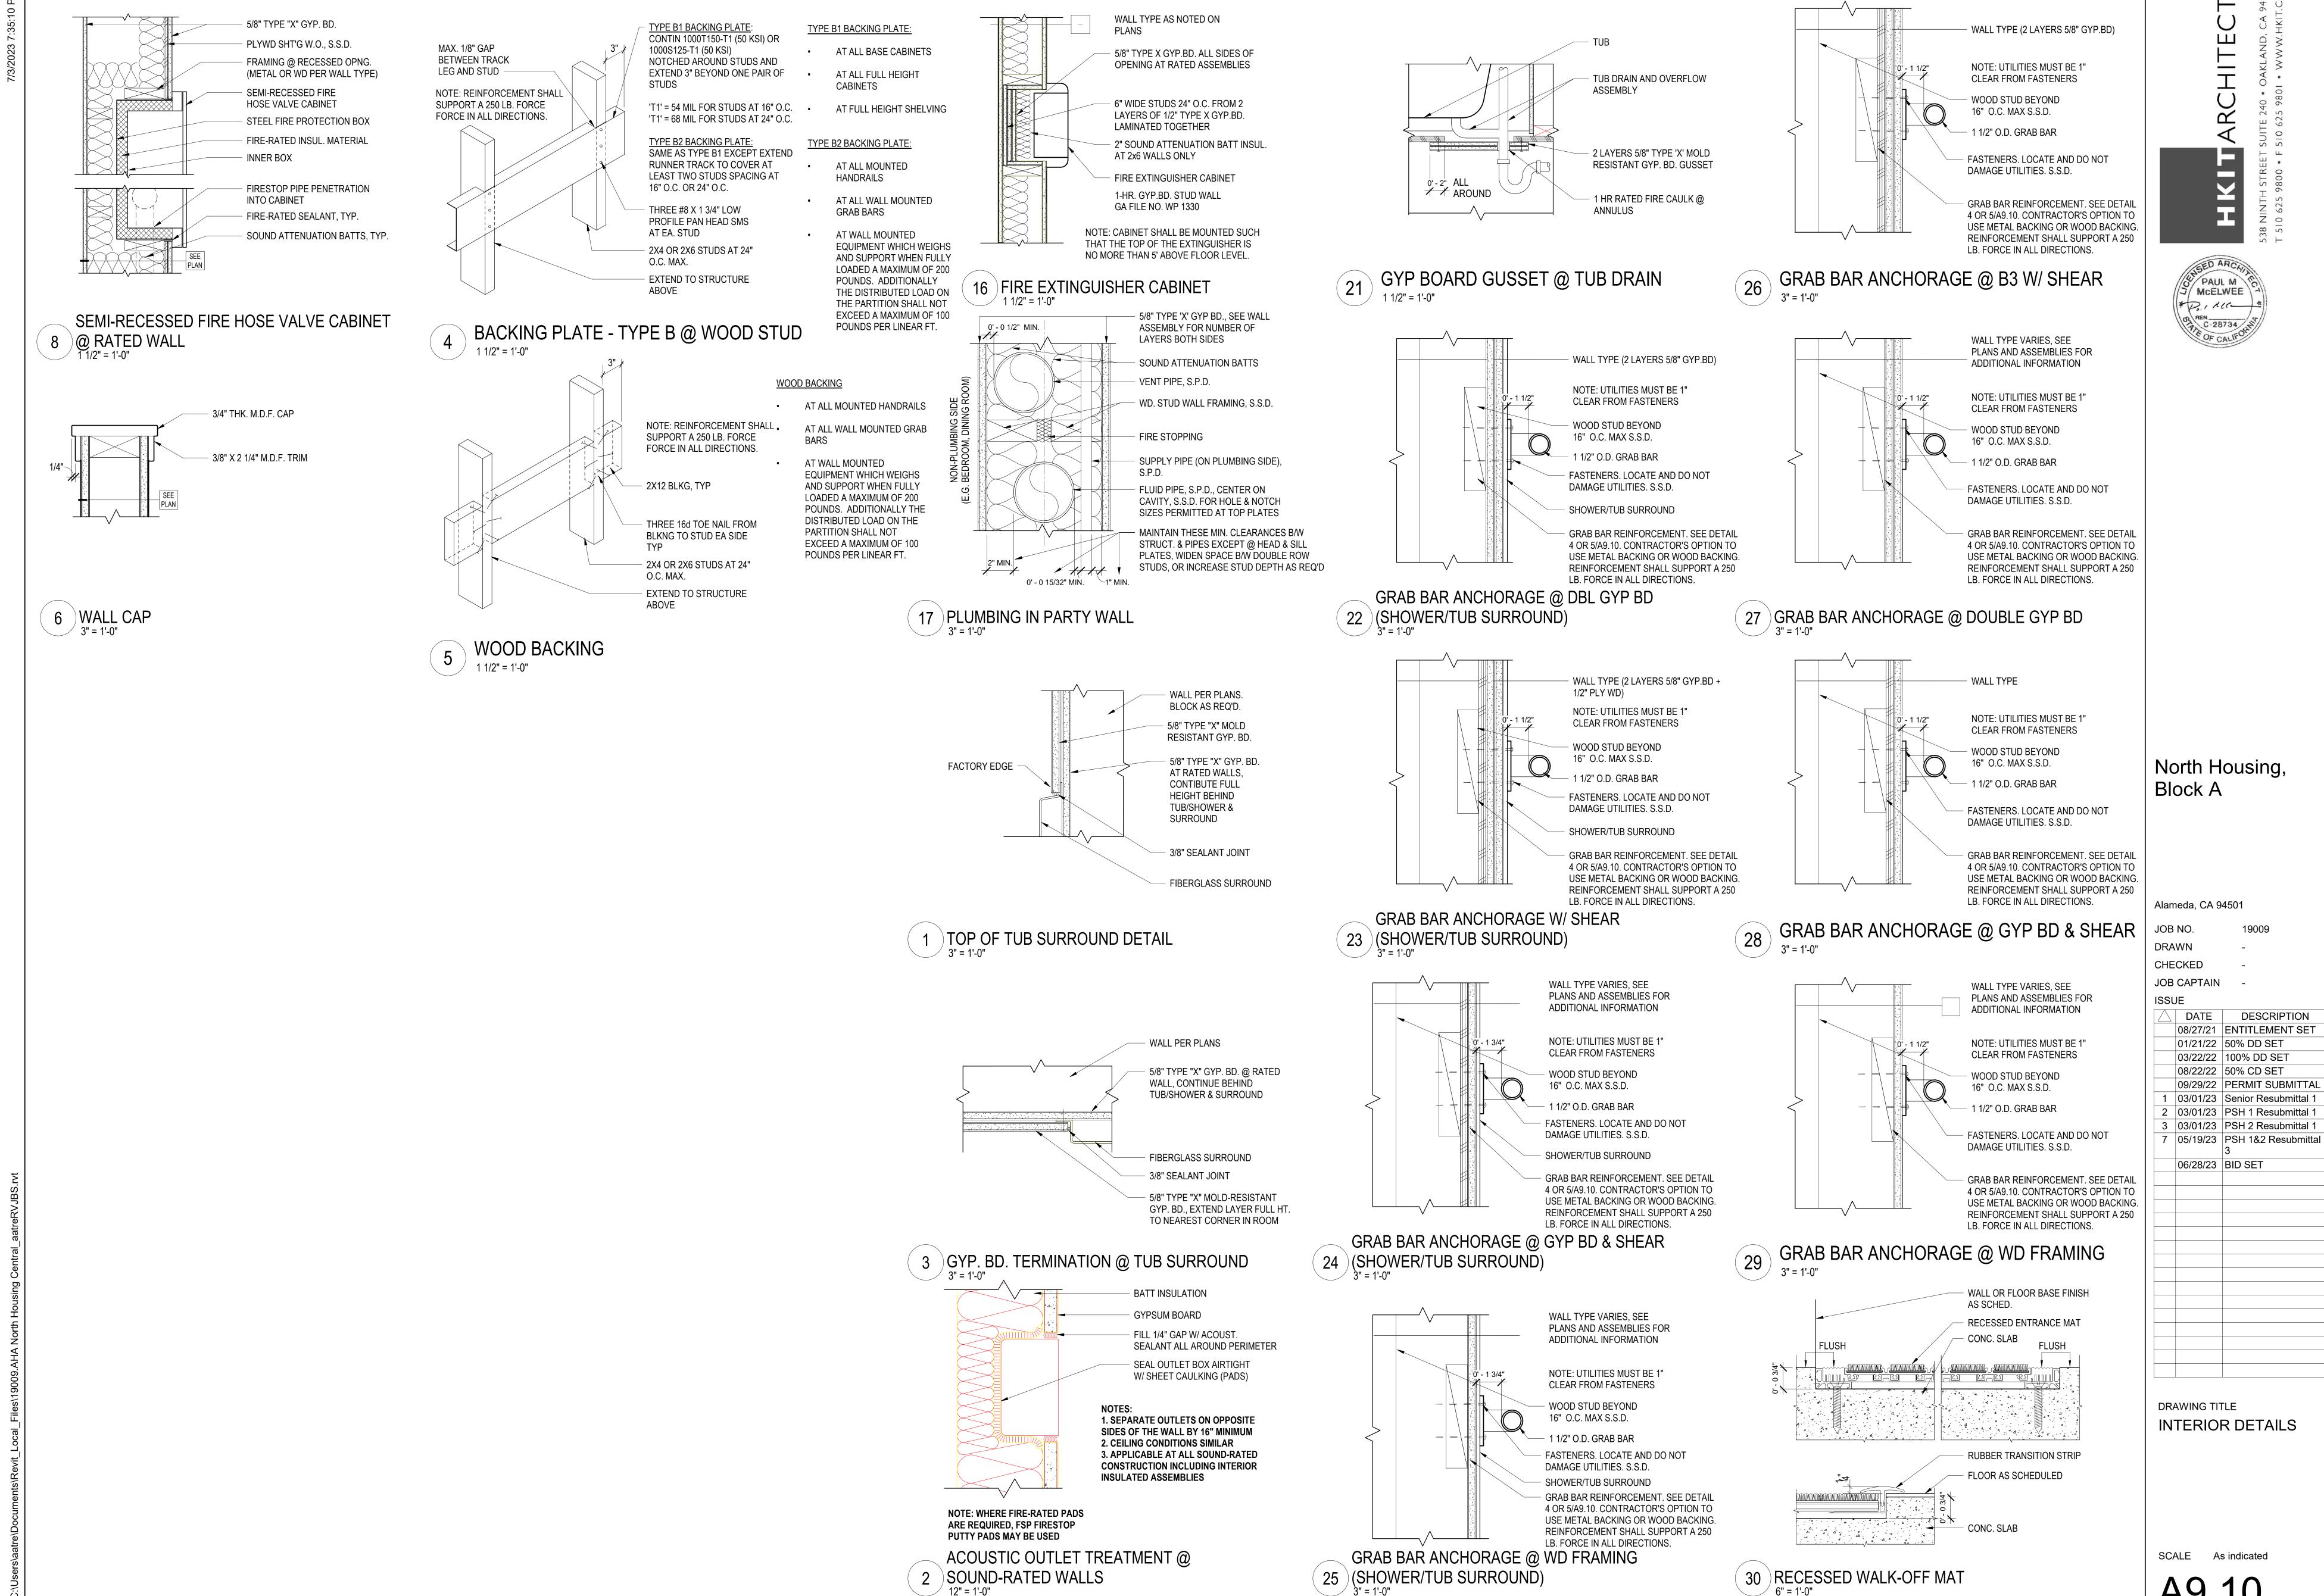


DESCRIPTION

COPYRIGHT © 2016 HKIT ARCHITECTS

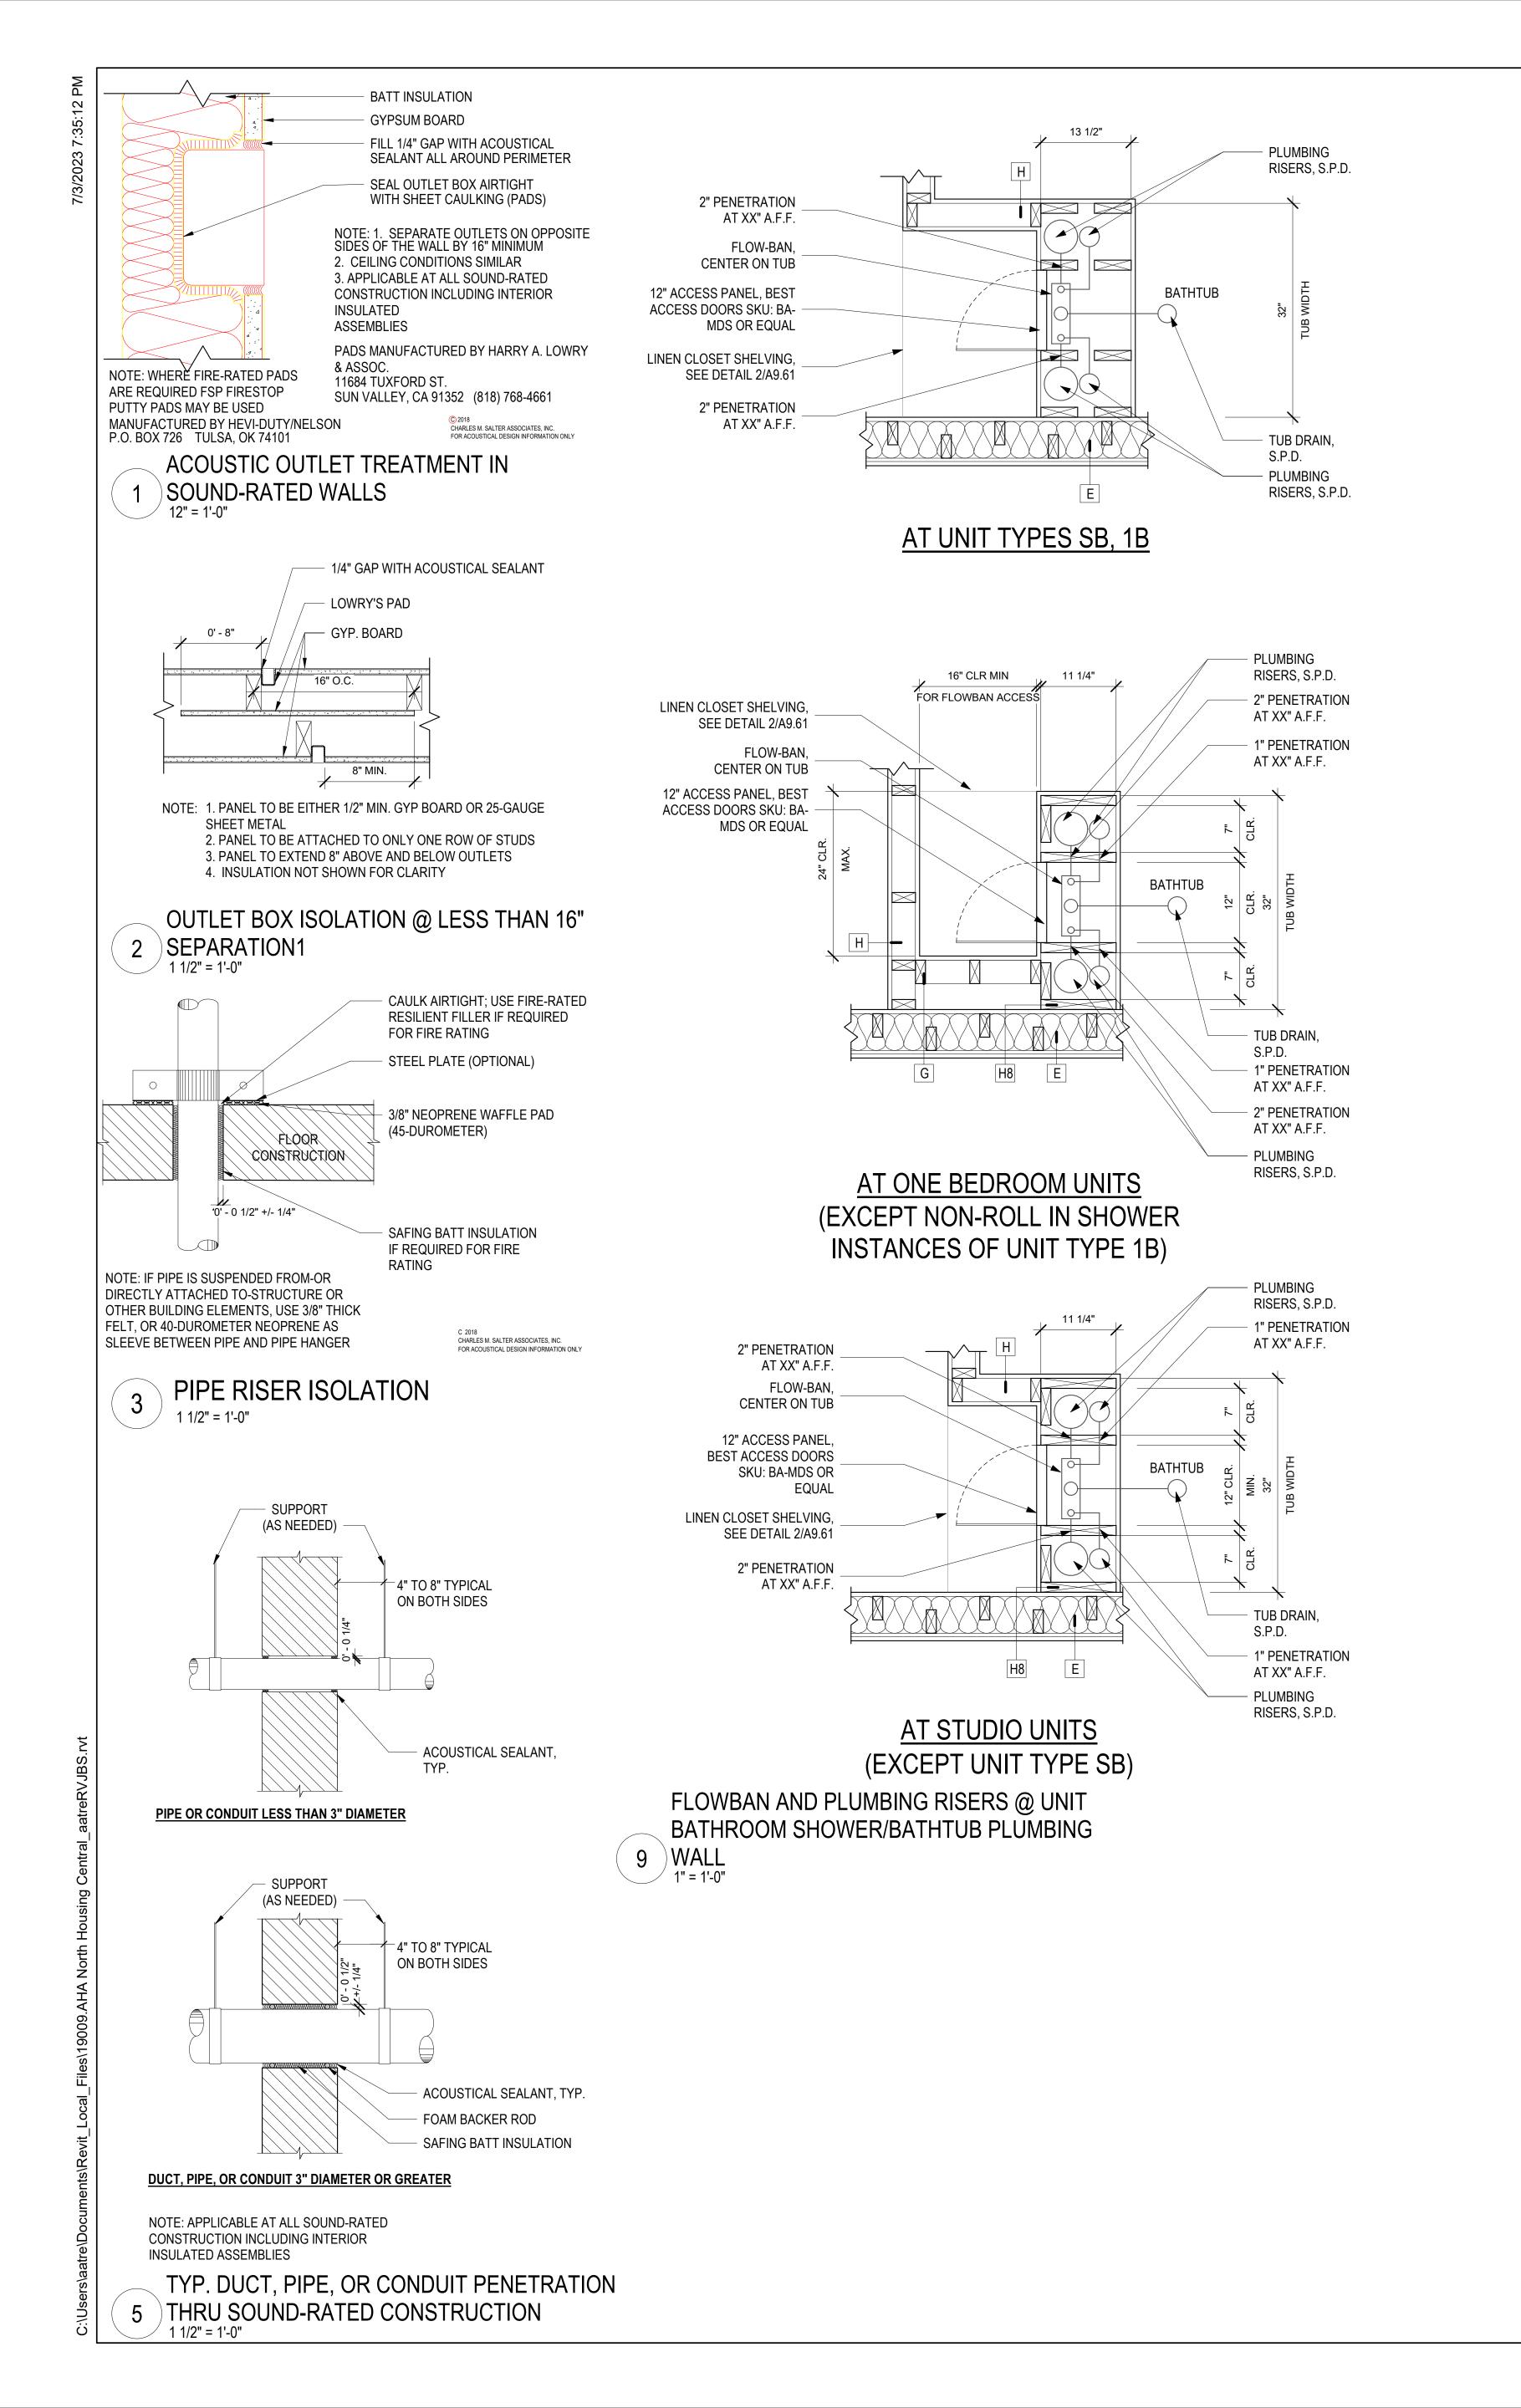


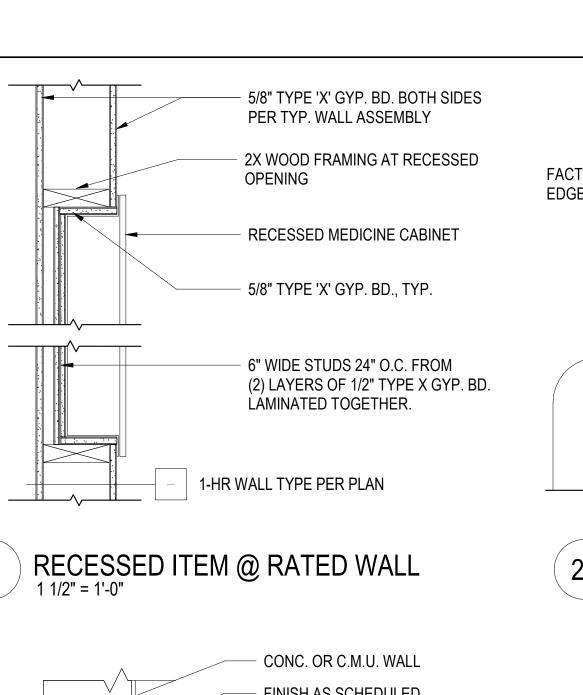





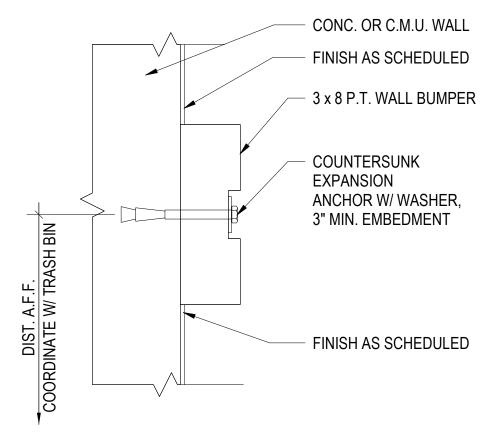


22 WALL BUMPER

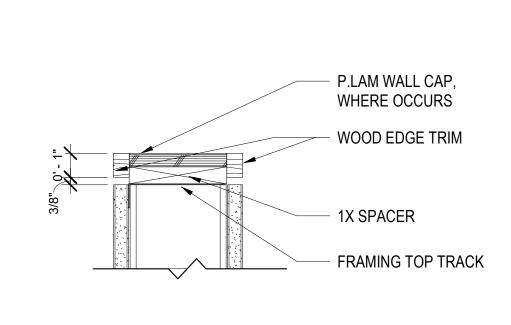

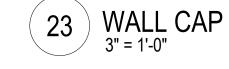


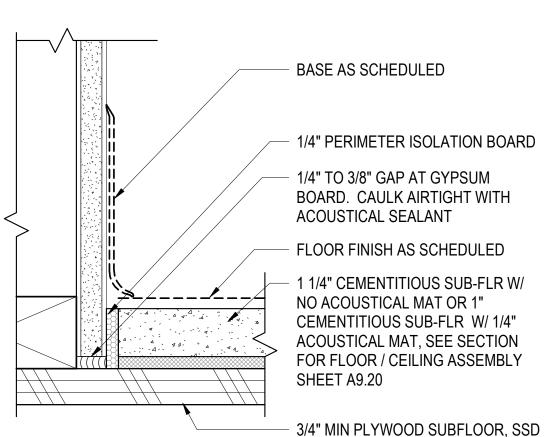


WALL BASE AT GYP. CONC. FLOOR

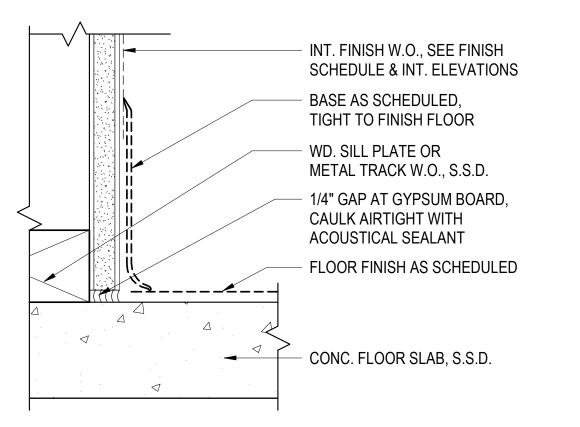


WALL BASE AT CONCRETE FLOOR

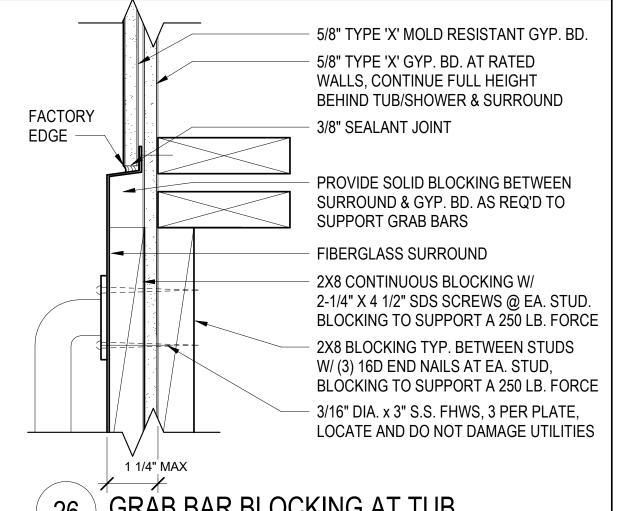

GRAB BAR BLOCKING AT TUB

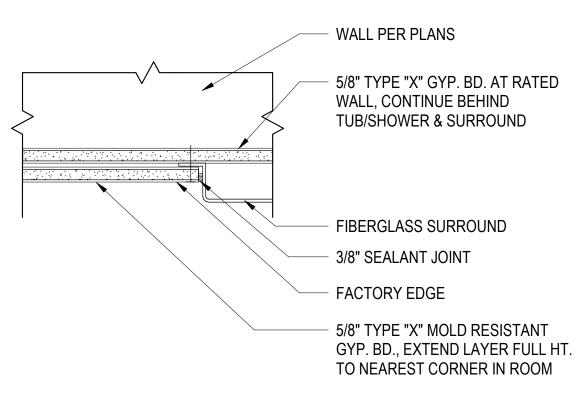

GYP. BD. TERMINATION @ TUB SURROUND

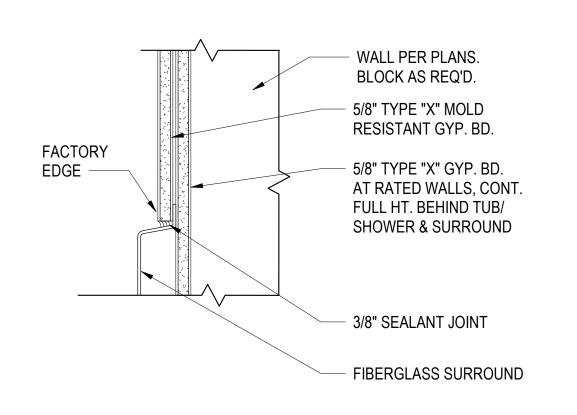

TOP OF TUB SURROUND DETAIL1

North Housing, Block A

GED ARCA

PAUL M MCELWEE

1 × 13.1 100

C-28734 CF CALIFORN

Alameda, CA 94501


JOB	NO.	19009
DRA	WN	GB
CHE	CKED	-
JOB	CAPTAIN	-
ISSL	JE	
	DATE	DESCRIPTION
	01/21/22	50% DD SET
	03/22/22	100% DD SET


7	DATE	DESCRIPTION
	01/21/22	50% DD SET
	03/22/22	100% DD SET
	08/22/22	50% CD SET
	09/29/22	PERMIT SUBMITTAL
	03/01/23	Senior Resubmittal 1
	03/01/23	PSH 1 Resubmittal 1
	03/01/23	PSH 2 Resubmittal 1
	05/19/23	PSH 1&2 Resubmittal 3

06/28/23 BID SET

DRAWING TITLE INTERIOR DETAILS, INTERIOR ACOUSTICAL DETAILS

SCALE As indicated

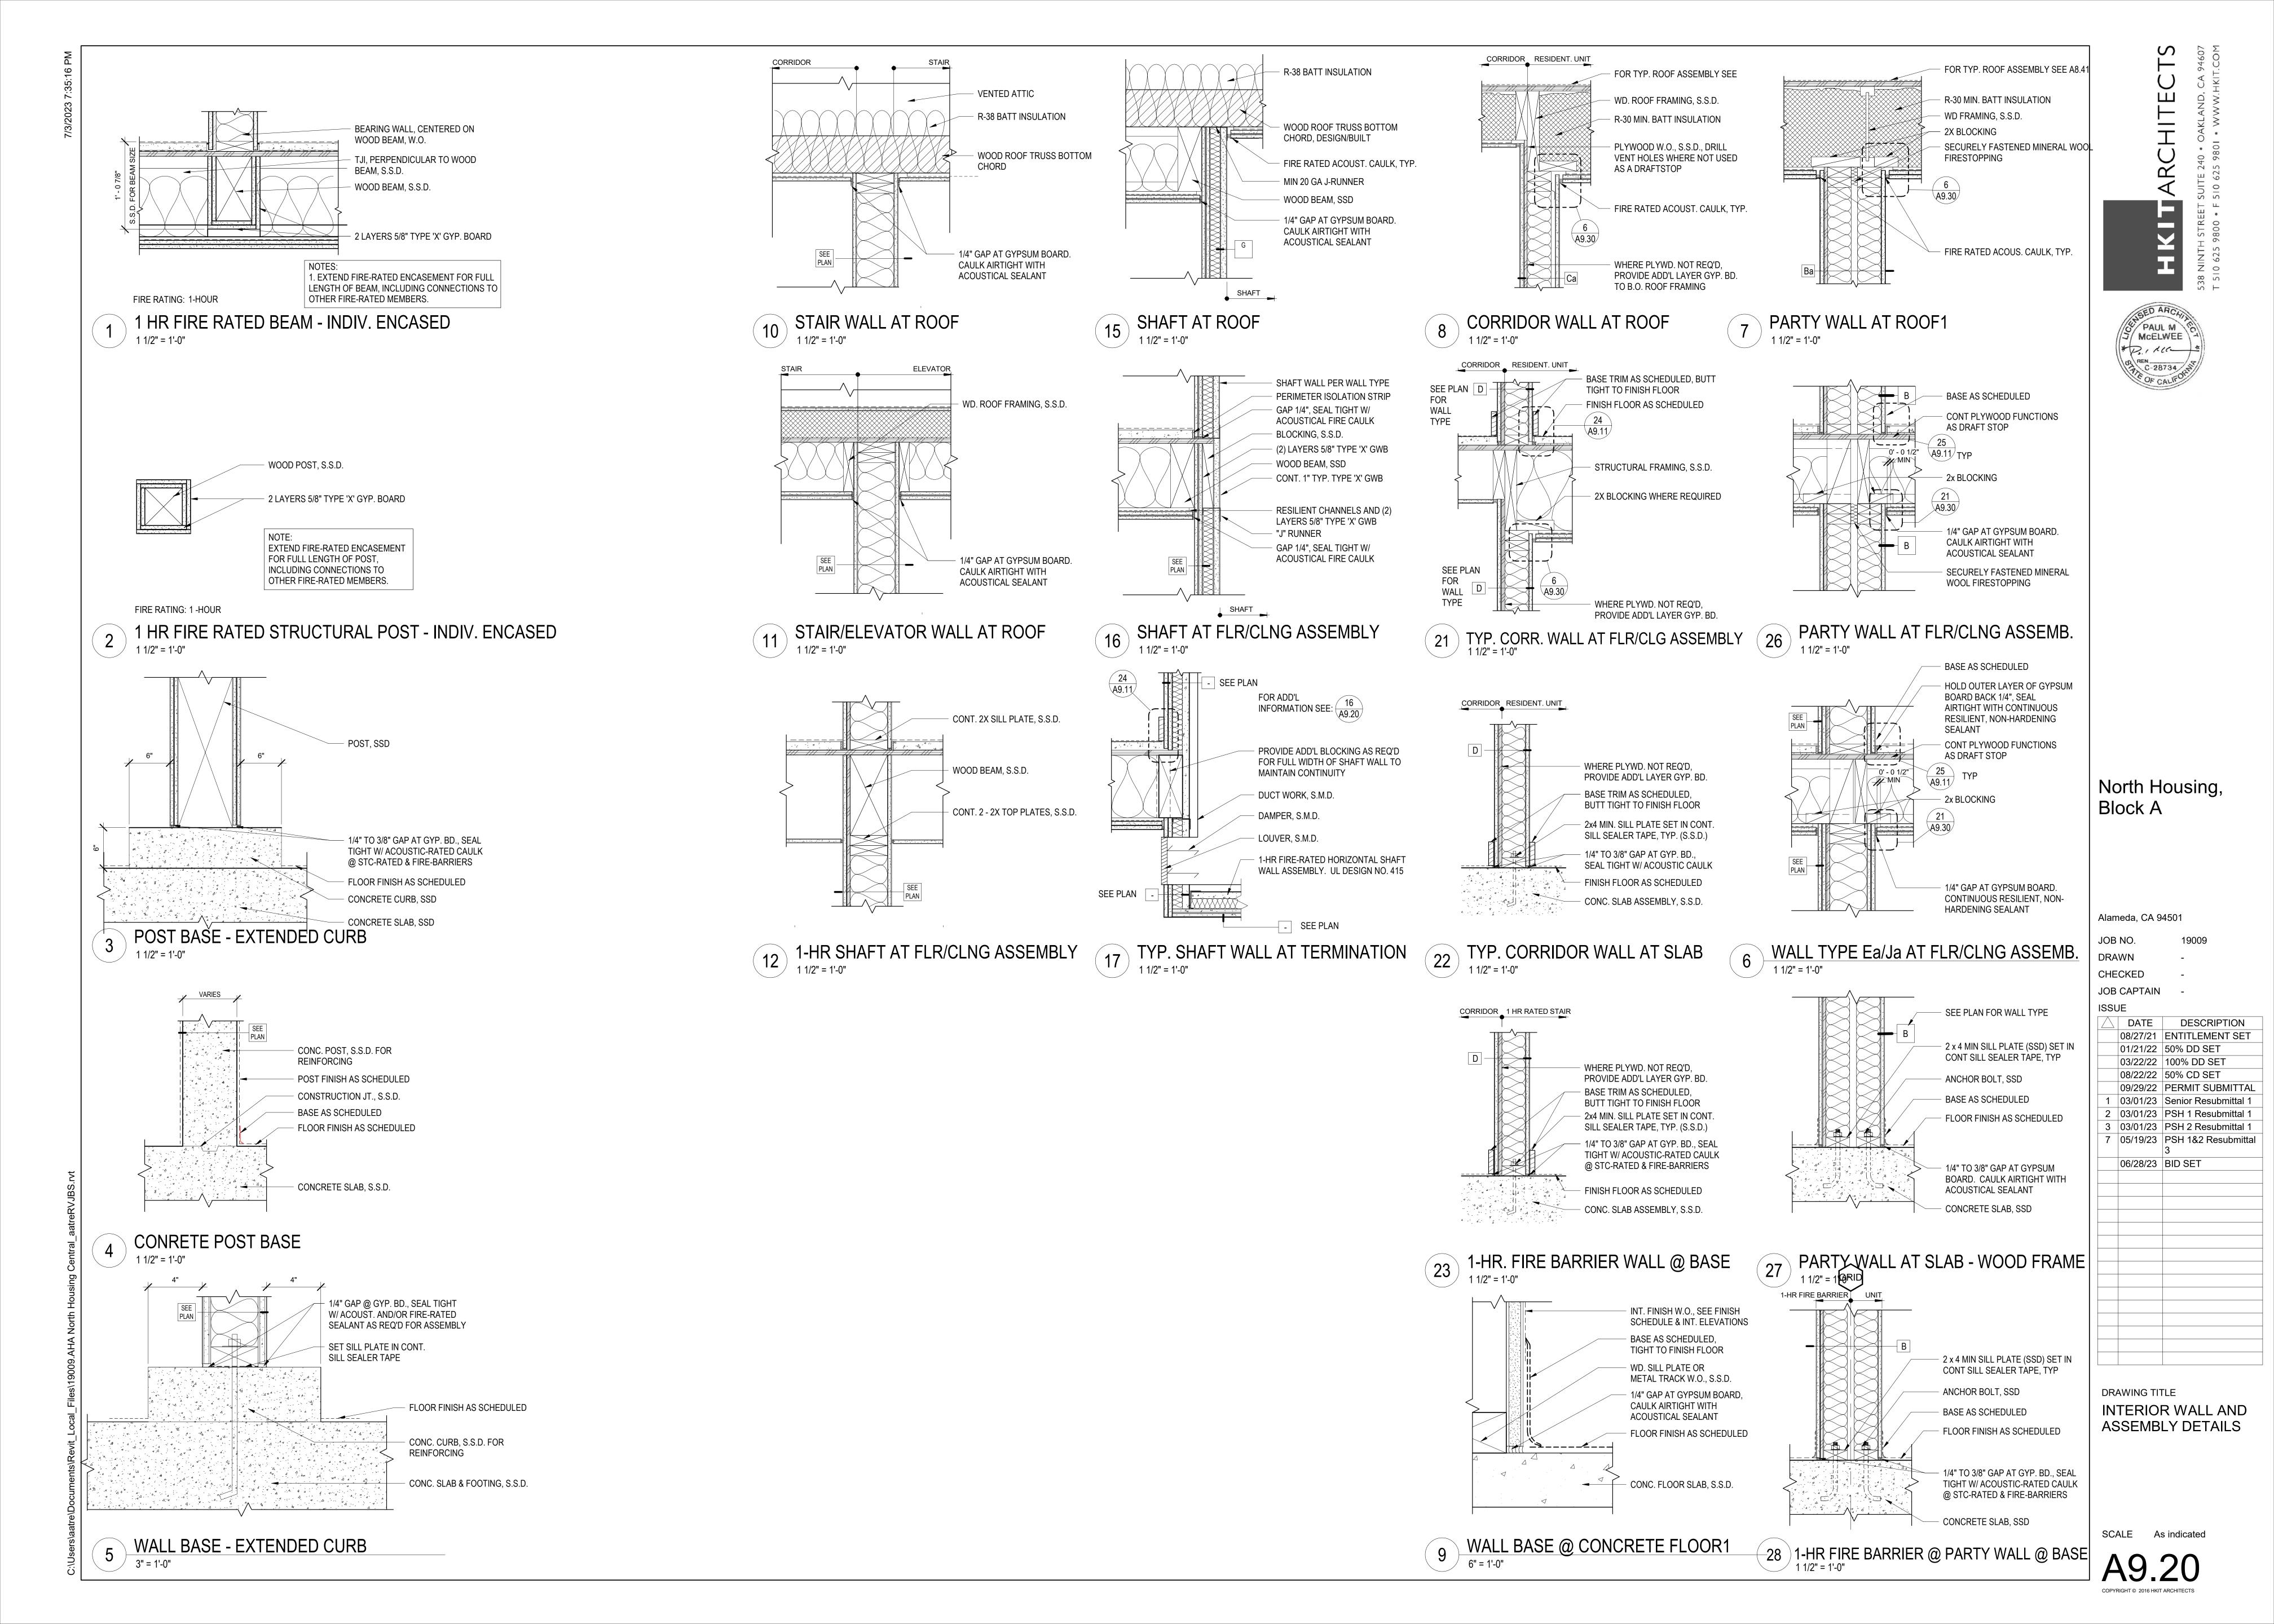

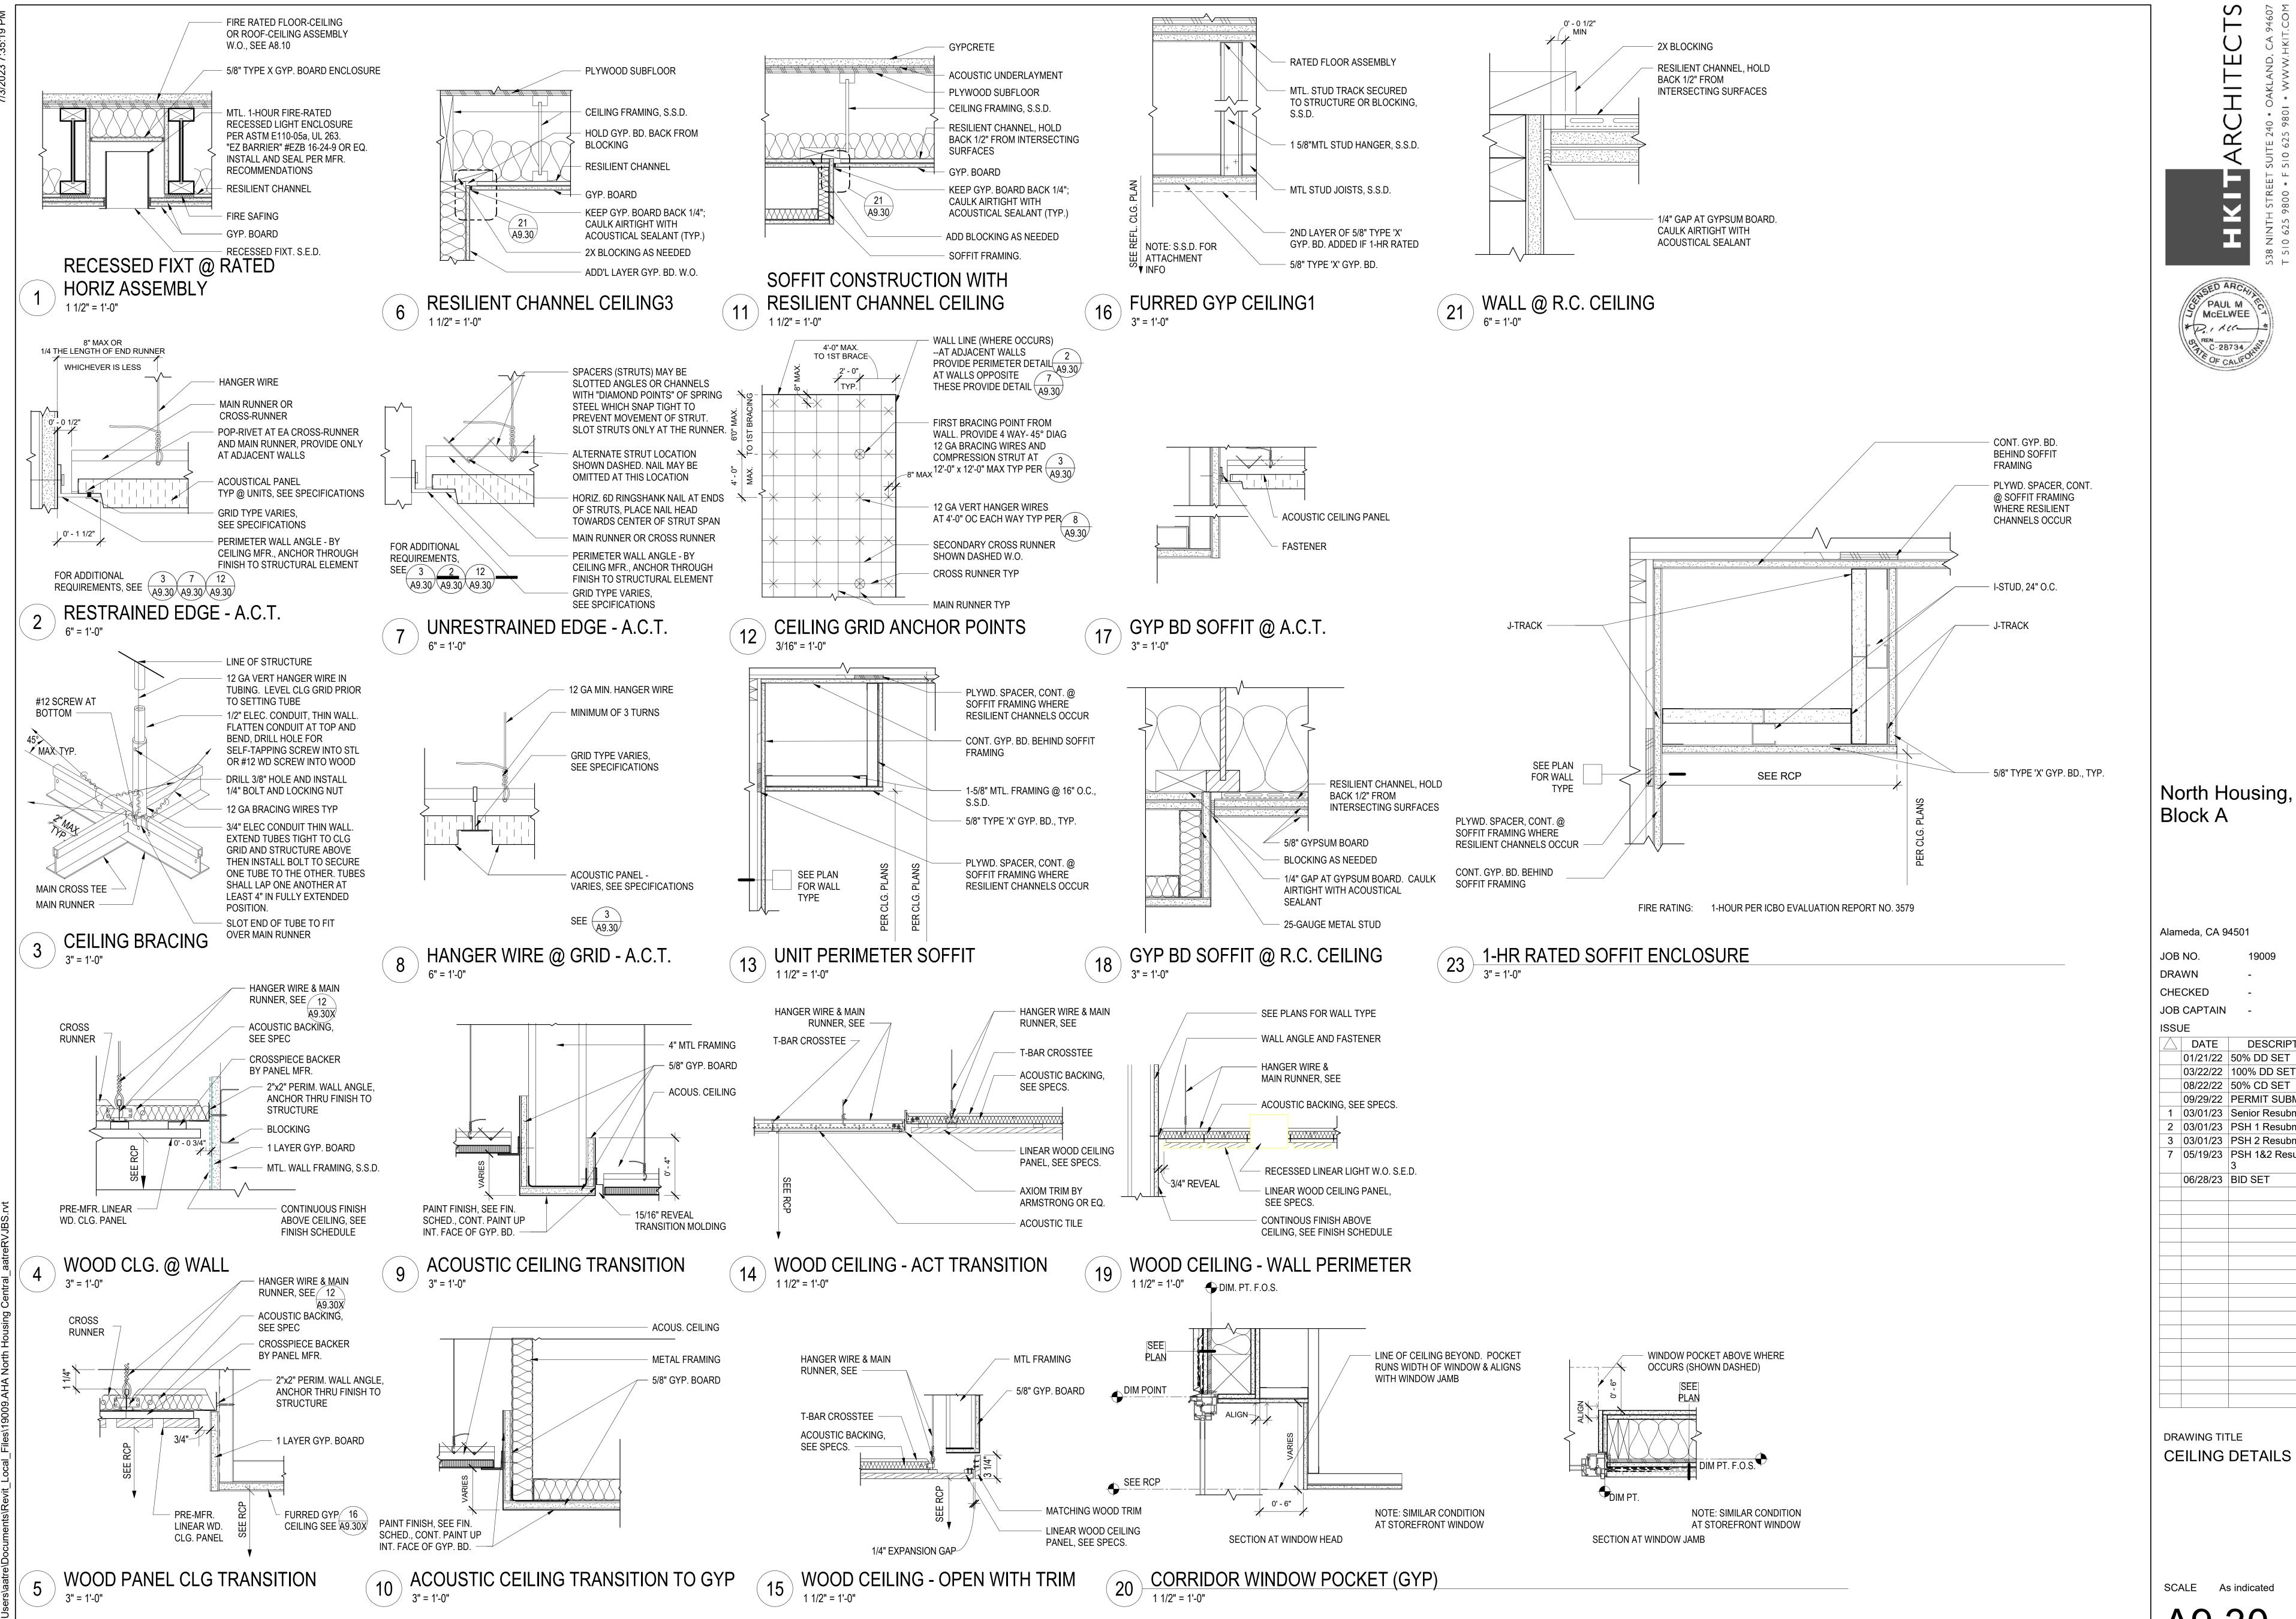

GED ARCA

North Housing,

Alameda, CA 94501

DESCRIPTION 01/21/22 | 50% DD SET

08/22/22 50% CD SET

09/29/22 PERMIT SUBMITTAL

1 | 03/01/23 | Senior Resubmittal 1


2 | 03/01/23 | PSH 1 Resubmittal 1

3 | 03/01/23 | PSH 2 Resubmittal 1


7 | 05/19/23 | PSH 1&2 Resubmittal

06/28/23 BID SET

SCALE As indicated

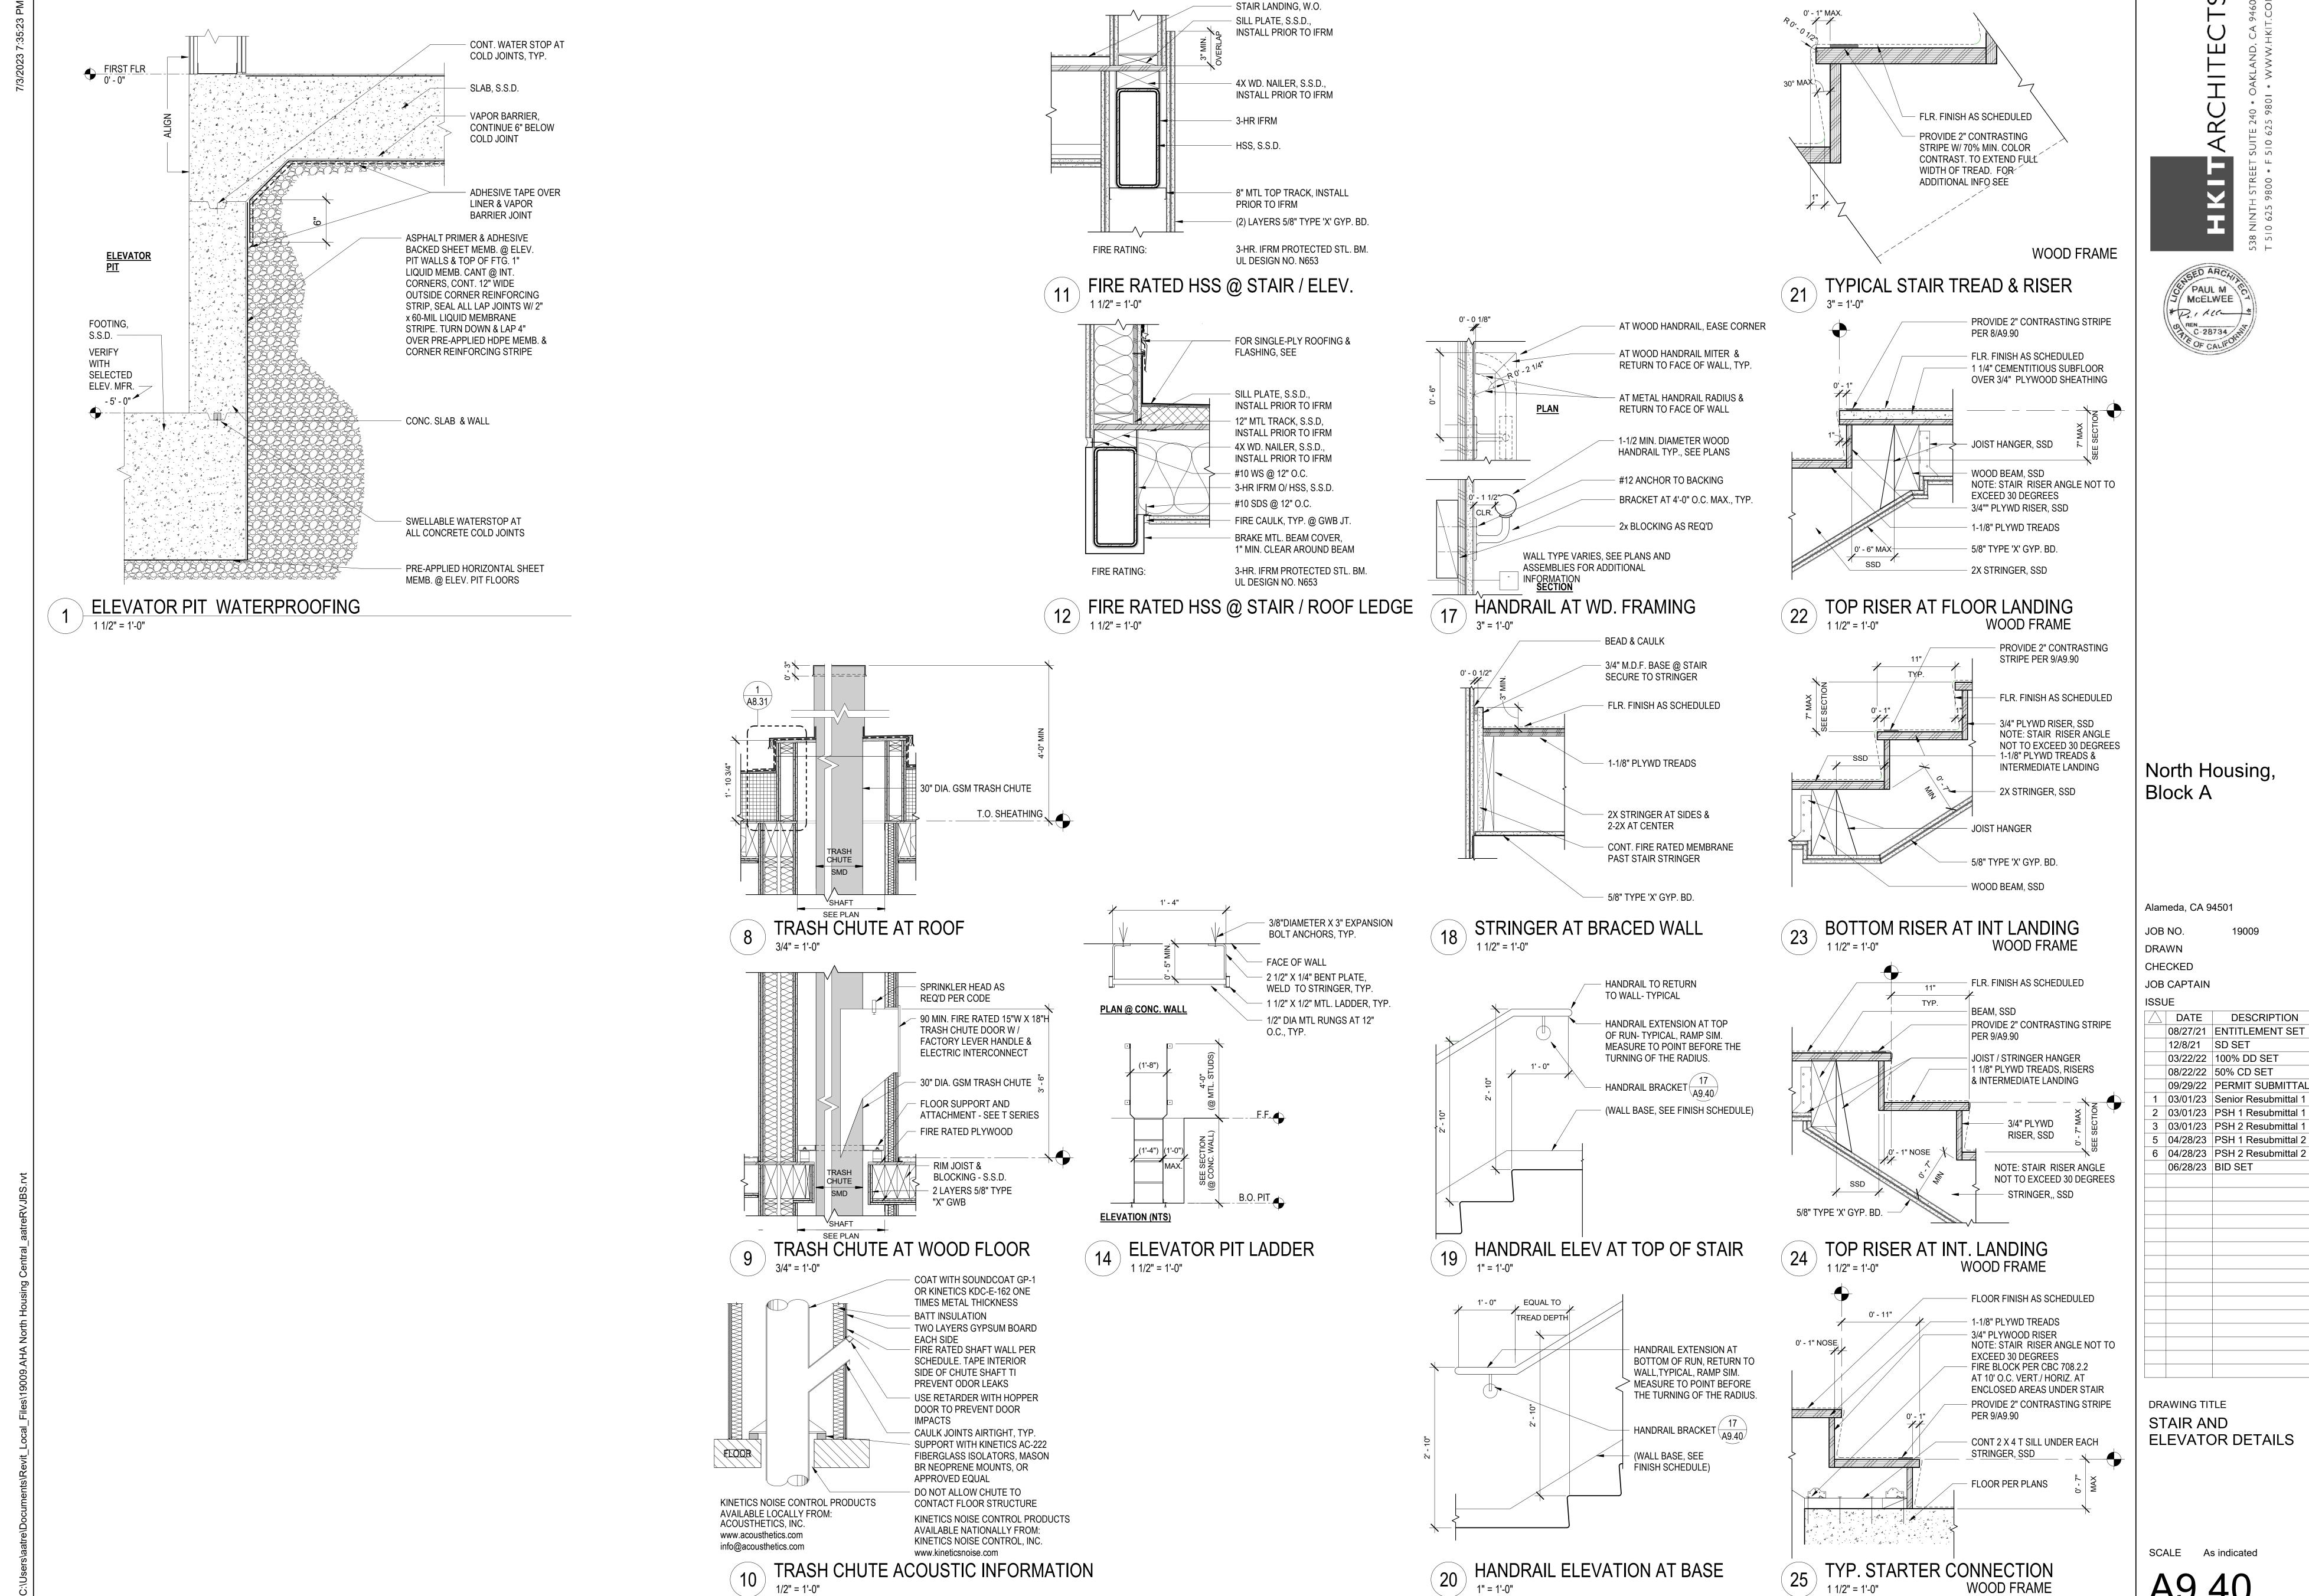

DATE DESCRIPTION

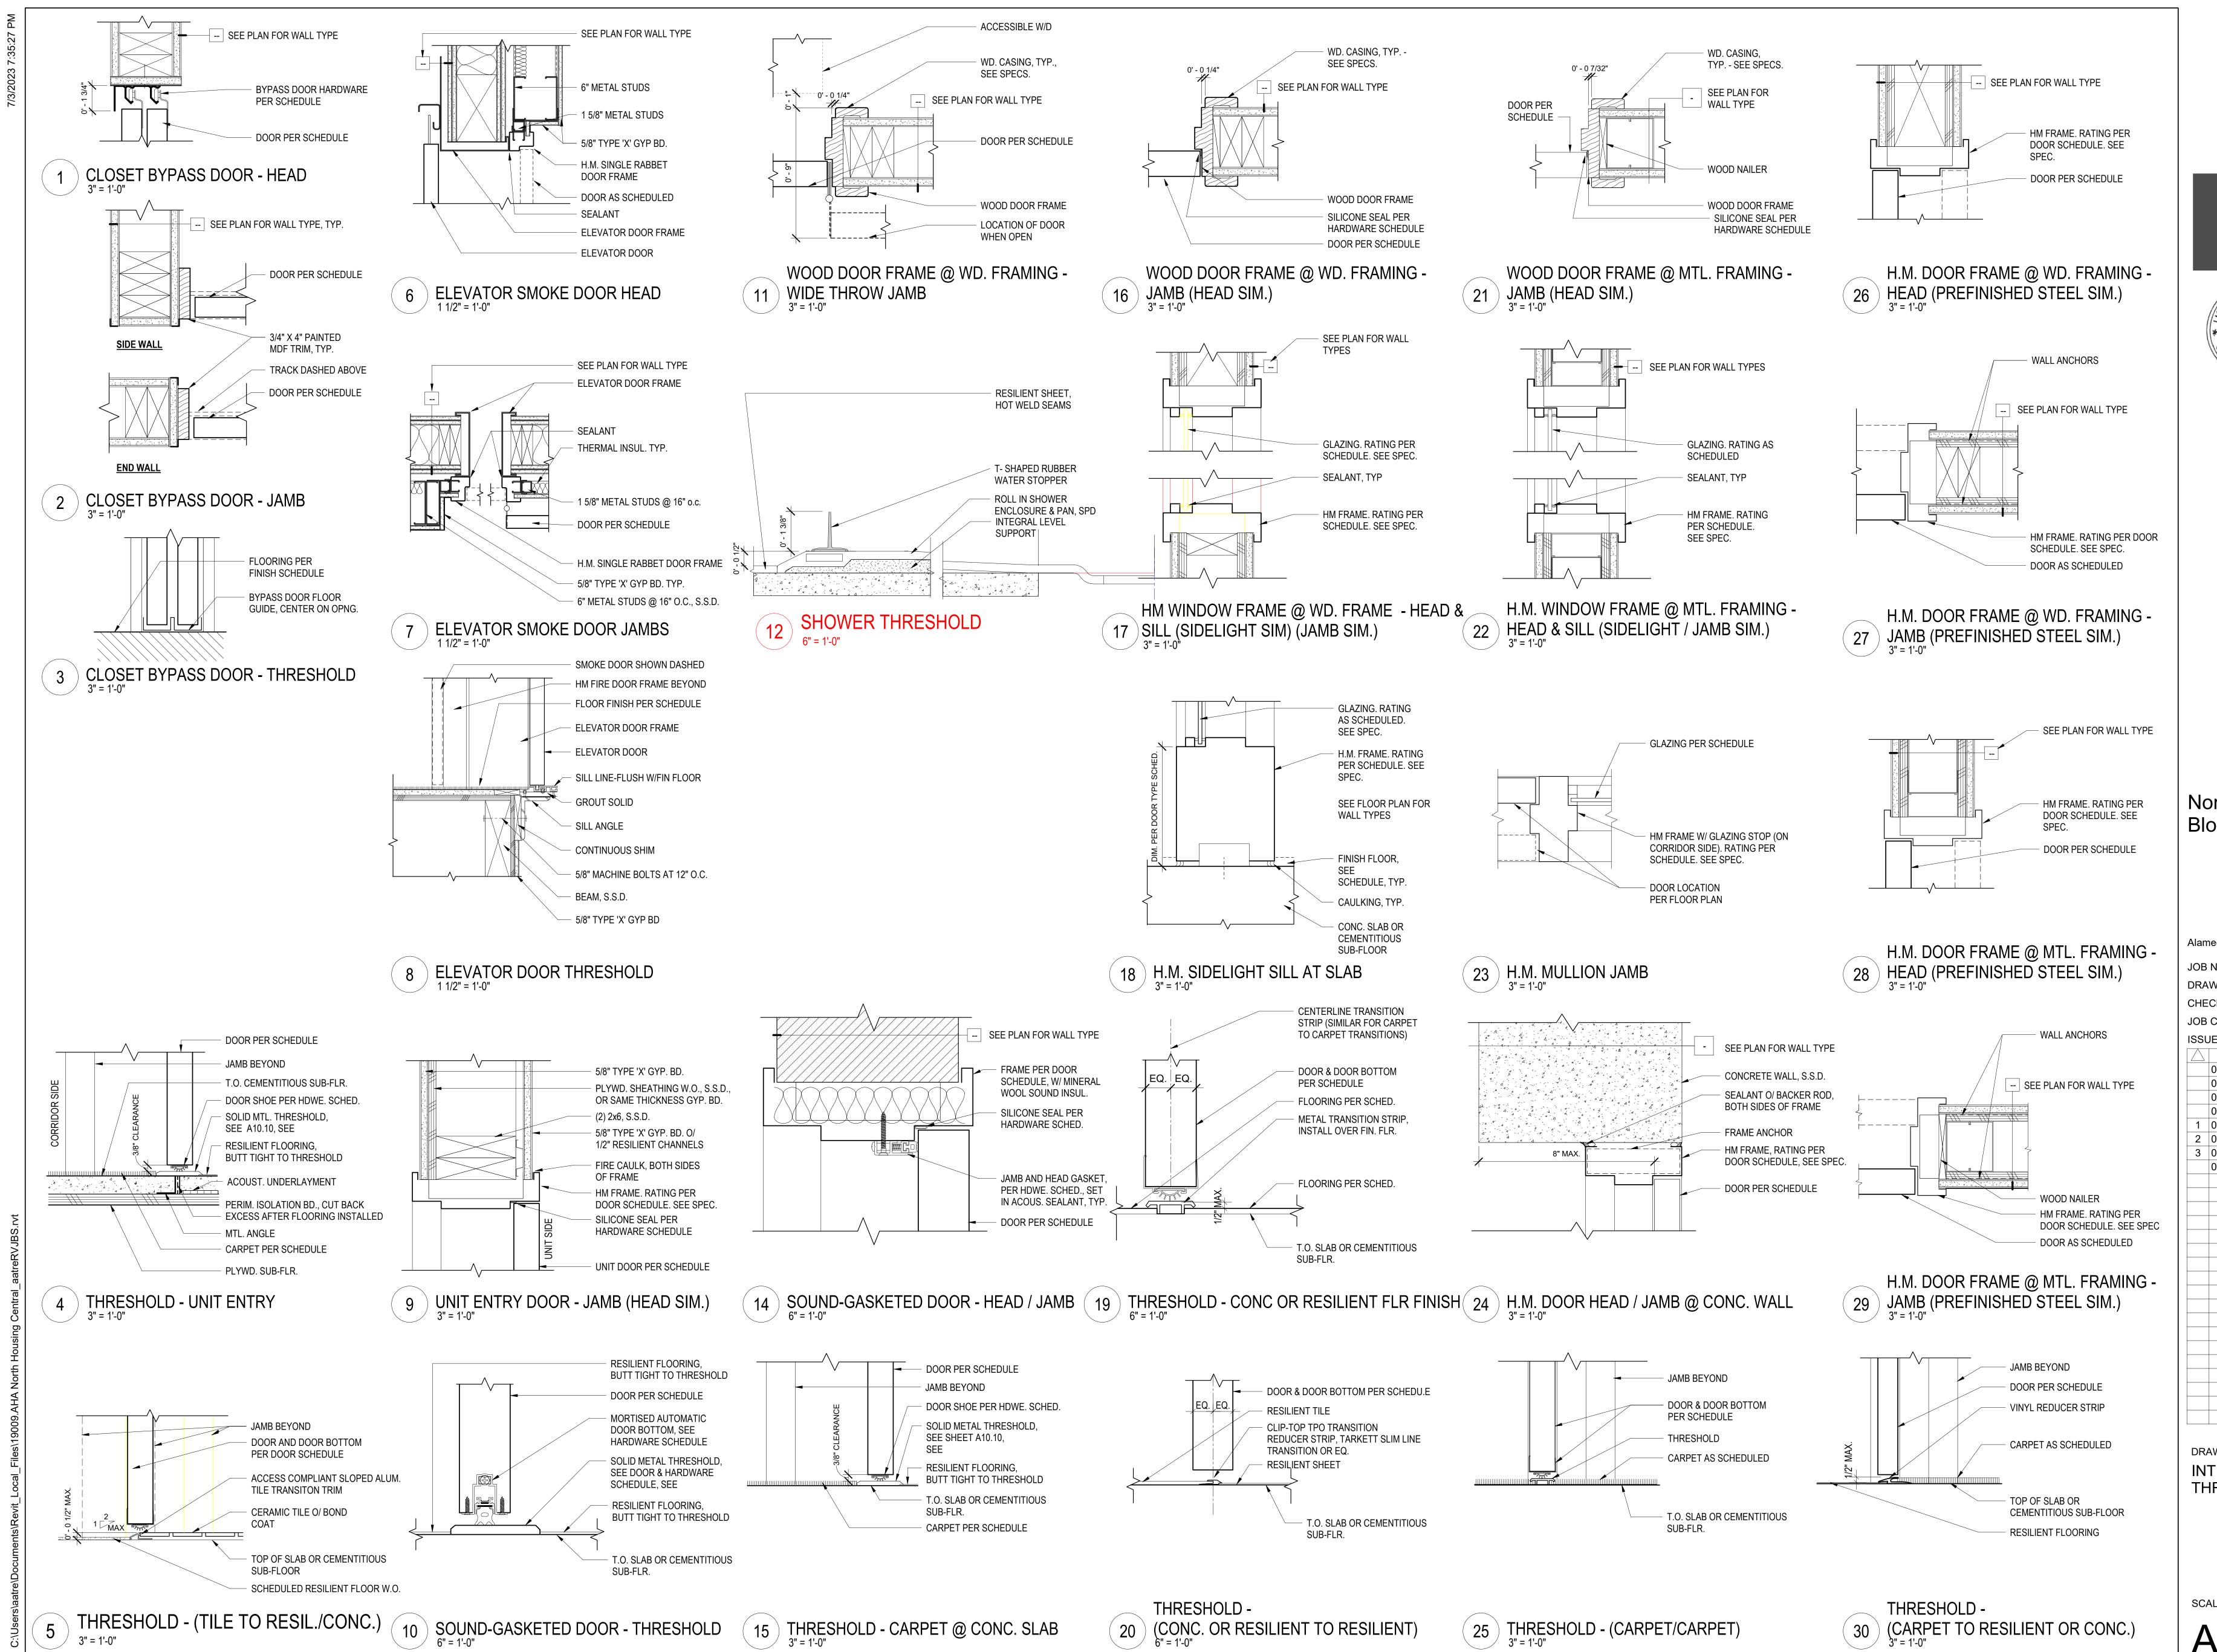

SED ARCHIA PAUL M MCELWEE REN C-28734 ANT OF CALIFORNIA

North Housing, Block A

Alameda, CA 94501

JOB NO. DRAWN

CHECKED Checker JOB CAPTAIN

Approve

DESCRIPTION 08/27/21 ENTITLEMENT SET

03/22/22 | 100% DD SET 08/22/22 50% CD SET 09/29/22 PERMIT SUBMITTAL

03/01/23 | Senior Resubmittal 1 2 | 03/01/23 | PSH 1 Resubmittal 3 | 03/01/23 | PSH 2 Resubmittal 1


06/28/23 BID SET

DRAWING TITLE


INTERIOR DOOR & THRESHOLD DETAILS

SCALE As indicated

COPYRIGHT © 2016 HKIT ARCHITECTS

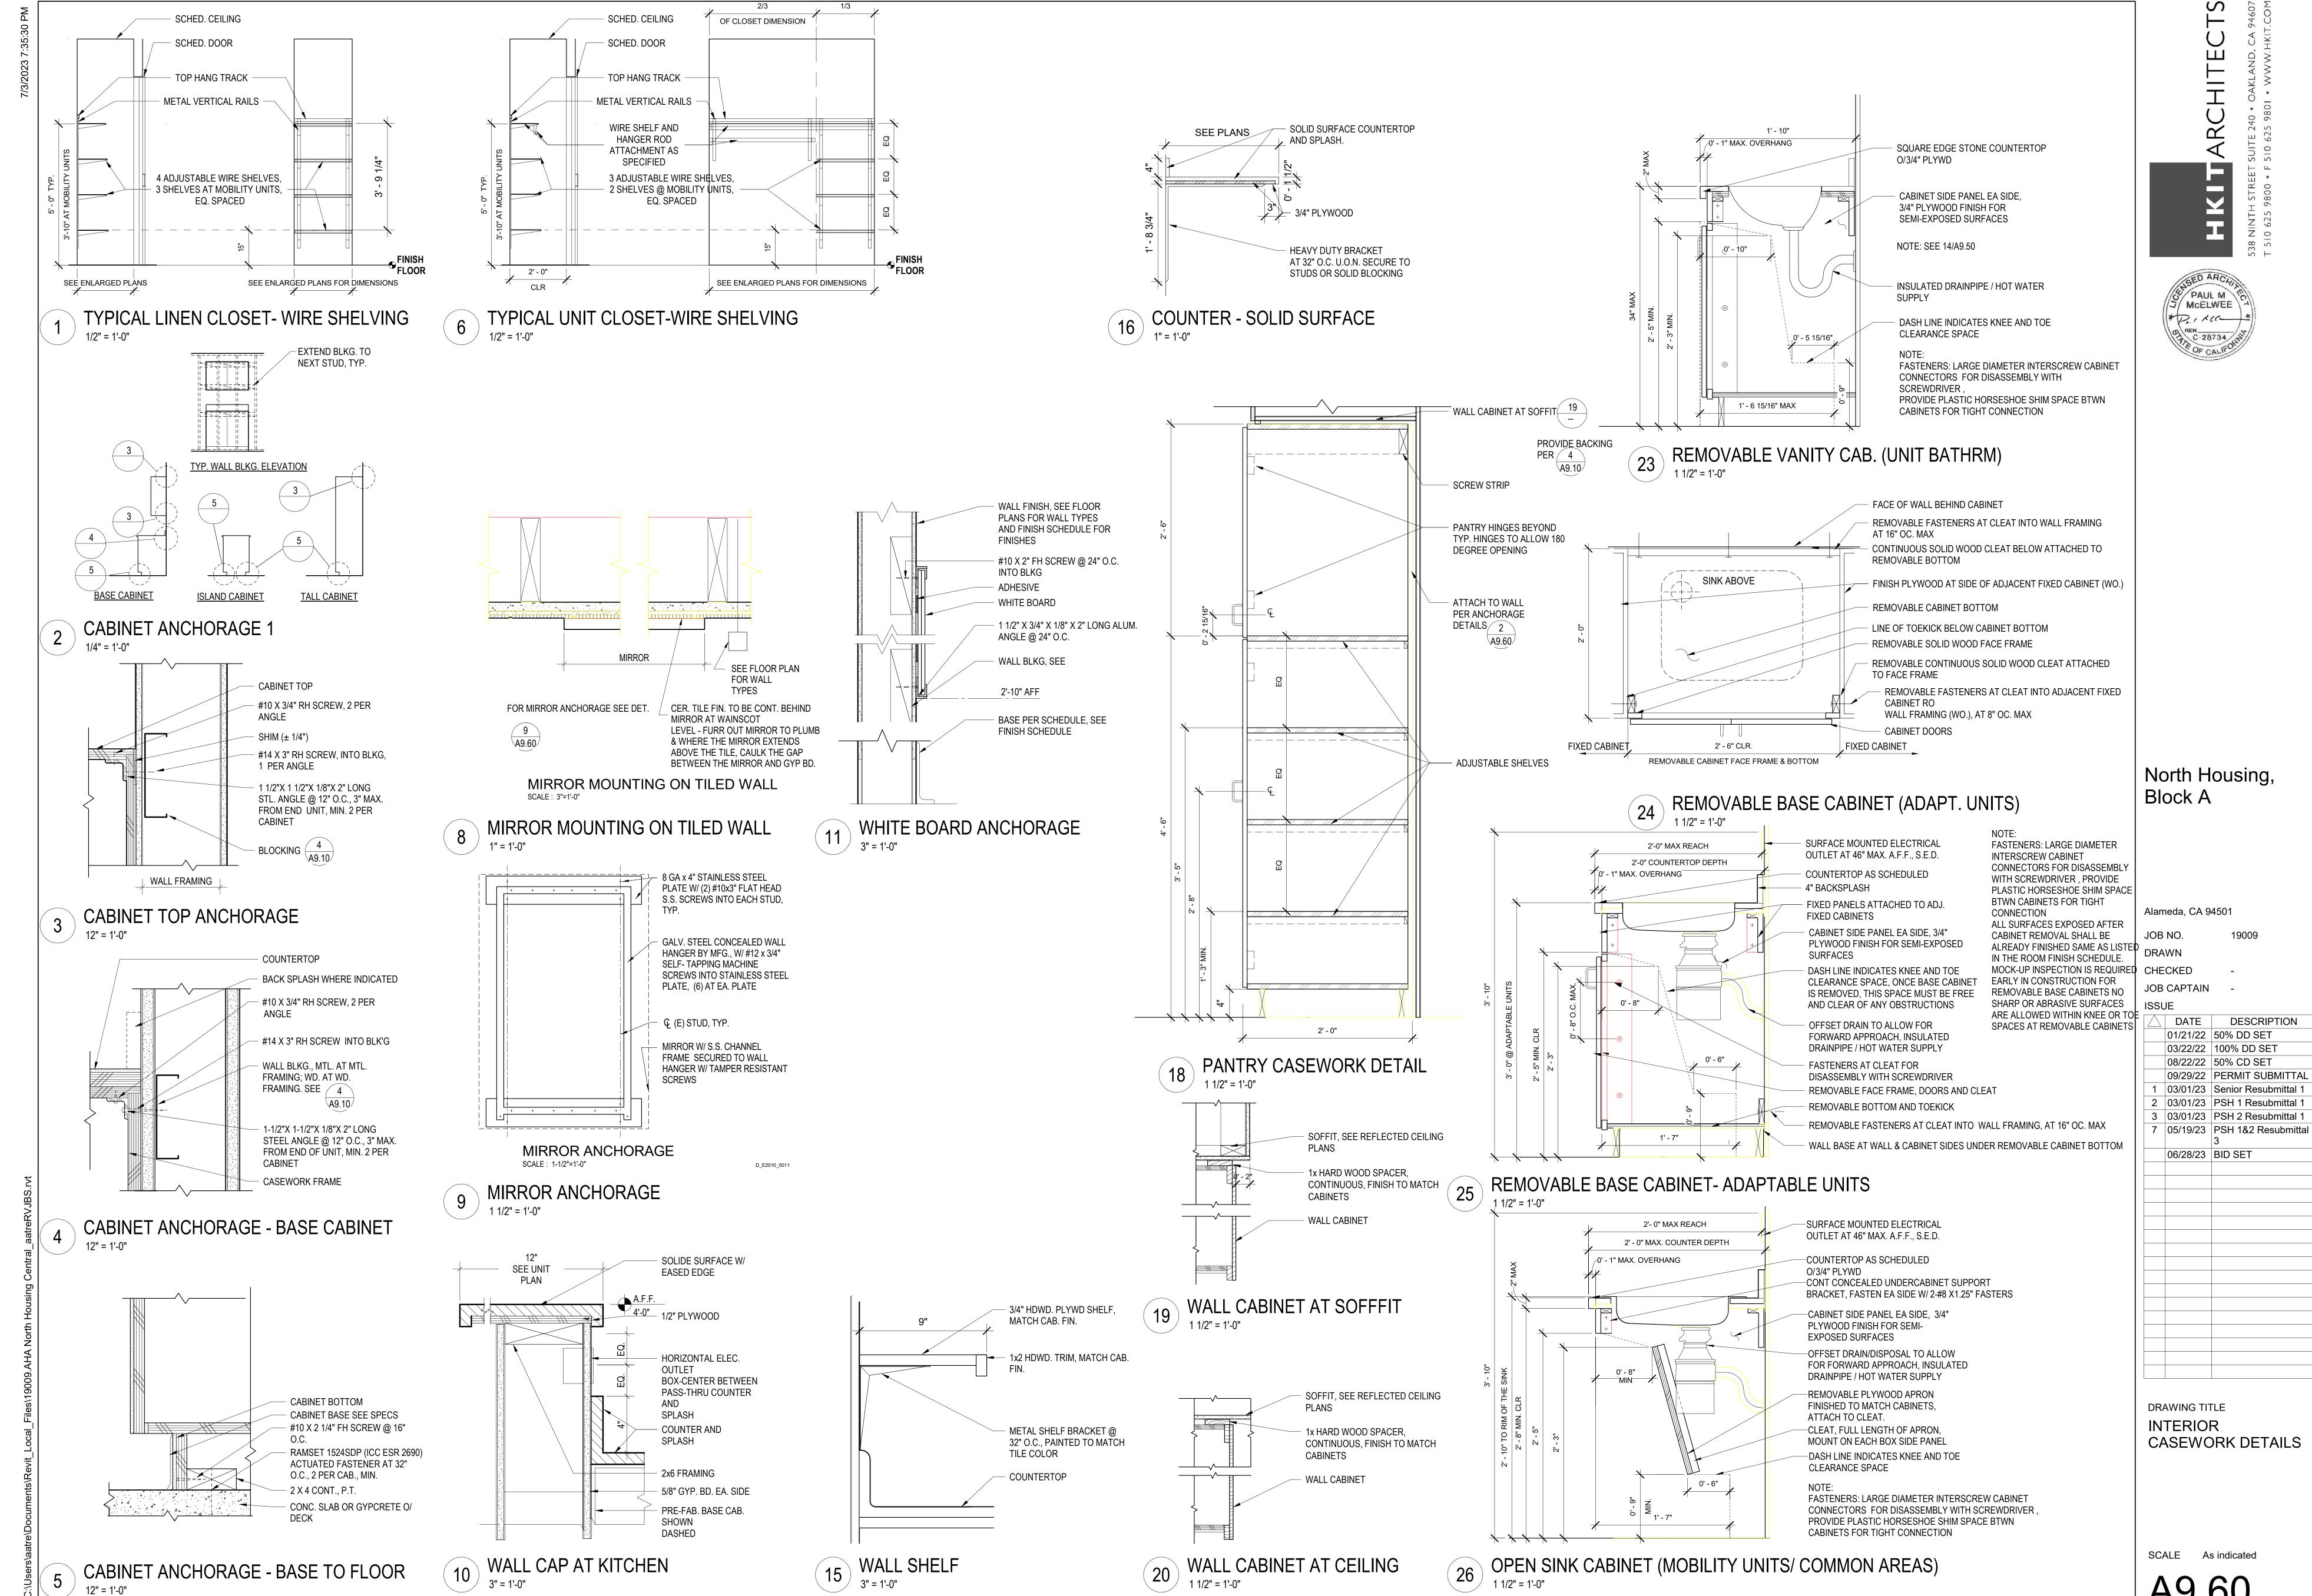

2' - 1"

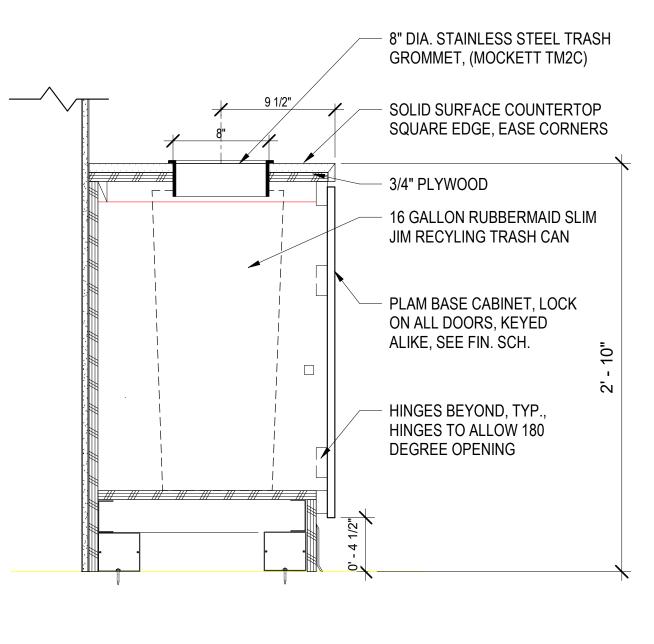

1 MAILBOX AT WALL SECTION
1 1/2" = 1'-0"

- WALLCOVERING

DIMENSIONS.

FRAMING - SIZE AS REQ'D TO ACHEIVE OVERALL

PLASTIC LAMINATE OVER
1/2" PLYWOOD
PLAM-1

- SEE PLAN FOR WALL TYPE

PRE-FABRICATED MAILBOXES, TYP.

DOUBLE 3/4" PLYWOOD AT MAILBOX PLATFORM

PLASTIC LAMINATE OVER

- MTL. STUD FRAMING - SIZE AS REQ'D TO ACHEIVE OVERALL DIMENSIONS.

- 'HILTI FASTENERS TO CONCRETE SLAB - SEE STRUCTURAL DWGS.

1/2" PLYWOOD

BASE PER SCHEDULE

- SOLID SURFACE COUNTERTOP SS 2

SQUARE EDGE, EASE CORNERS SS-2

2 MAILBOX END DETAIL
1 1/2" = 1'-0"

SOLID SURFACE OVER 1/2"

FRAMING - SIZE AS REQ'D

PLASTIC LAMINATE (PLAM-1)

TO ACHEIVE OVERALL

DIMENSIONS.

O/ 1/2" PLYWD —

PRE-FABRICATED MAILBOXES, TYP.

1 X WD. FURRING STRIPS @ 16" O.C. -

BASE

CORNERS

SS-2

PLYWD., SQUARE EDGE - EASE

4 MAILBOX RECYCLING COUNTER
1 1/2" = 1'-0"

Alameda, CA 94501

JOB NO. DRAWN Author

North Housing, Block A

Checker CHECKED JOB CAPTAIN Approver

DATE DESCRIPTION 03/22/22 100% DD SET 08/22/22 50% CD SET 09/29/22 PERMIT SUBMITTAL 1 03/01/23 Senior Resubmittal 1 2 03/01/23 PSH 1 Resubmittal 1 3 03/01/23 PSH 2 Resubmittal 1 7 05/19/23 PSH 1&2 Resubmittal

06/28/23 BID SET

DRAWING TITLE MAILBOX DETAILS (PSH 1 & SEN)


SCALE 1 1/2" = 1'-0"

DATE DESCRIPTION


DRAWING TITLE
SECURITY DESK
DETAILS (PSH 1)

SCALE 3" = 1'-0"


**49.63**PYRIGHT © 2016 HKIT ARCHITECTS

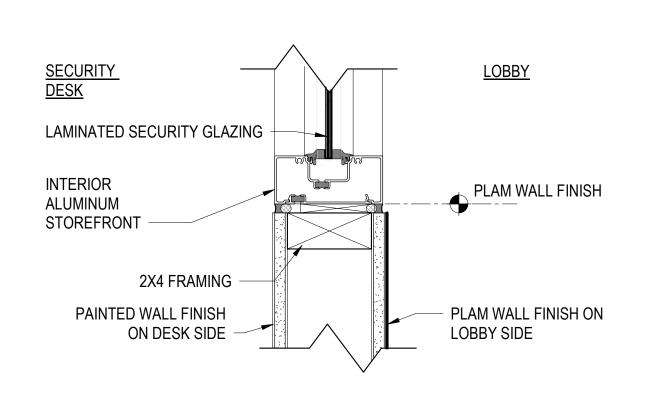

1 PSH1 - LOBBY GLAZING SILL, JAMB SIM.
3" = 1'-0"

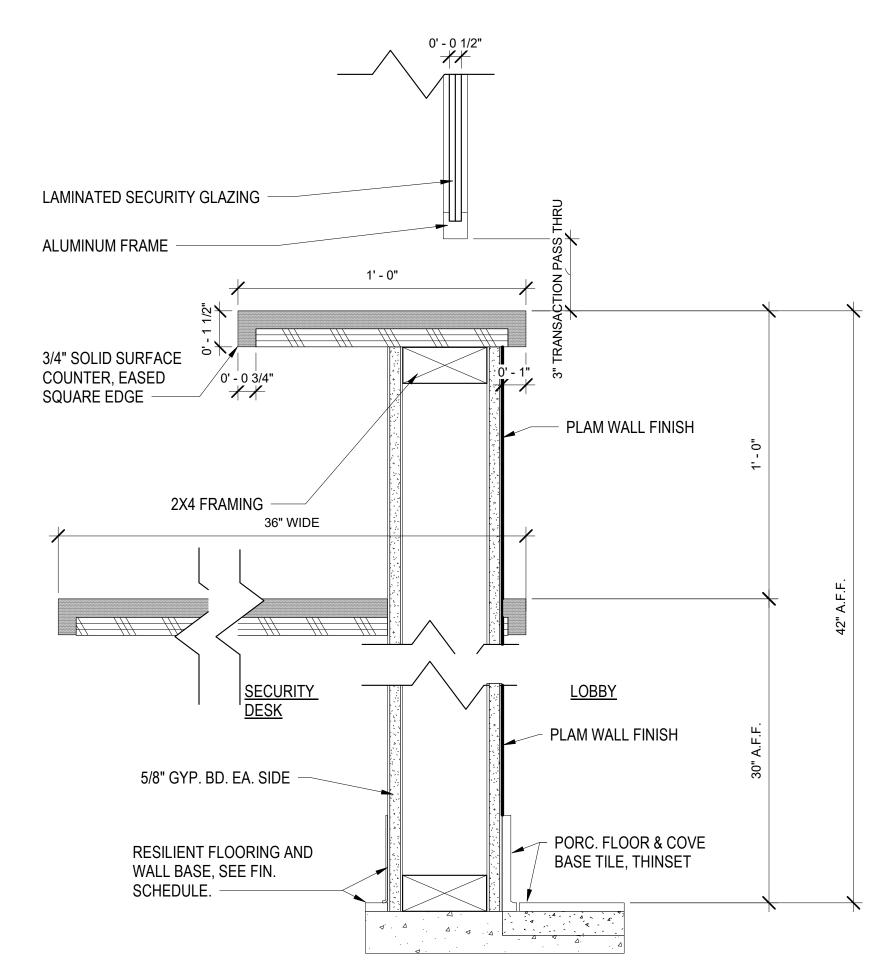

2 PSH1-LOBBY TRANSACTION COUNTER
3" = 1'-0"

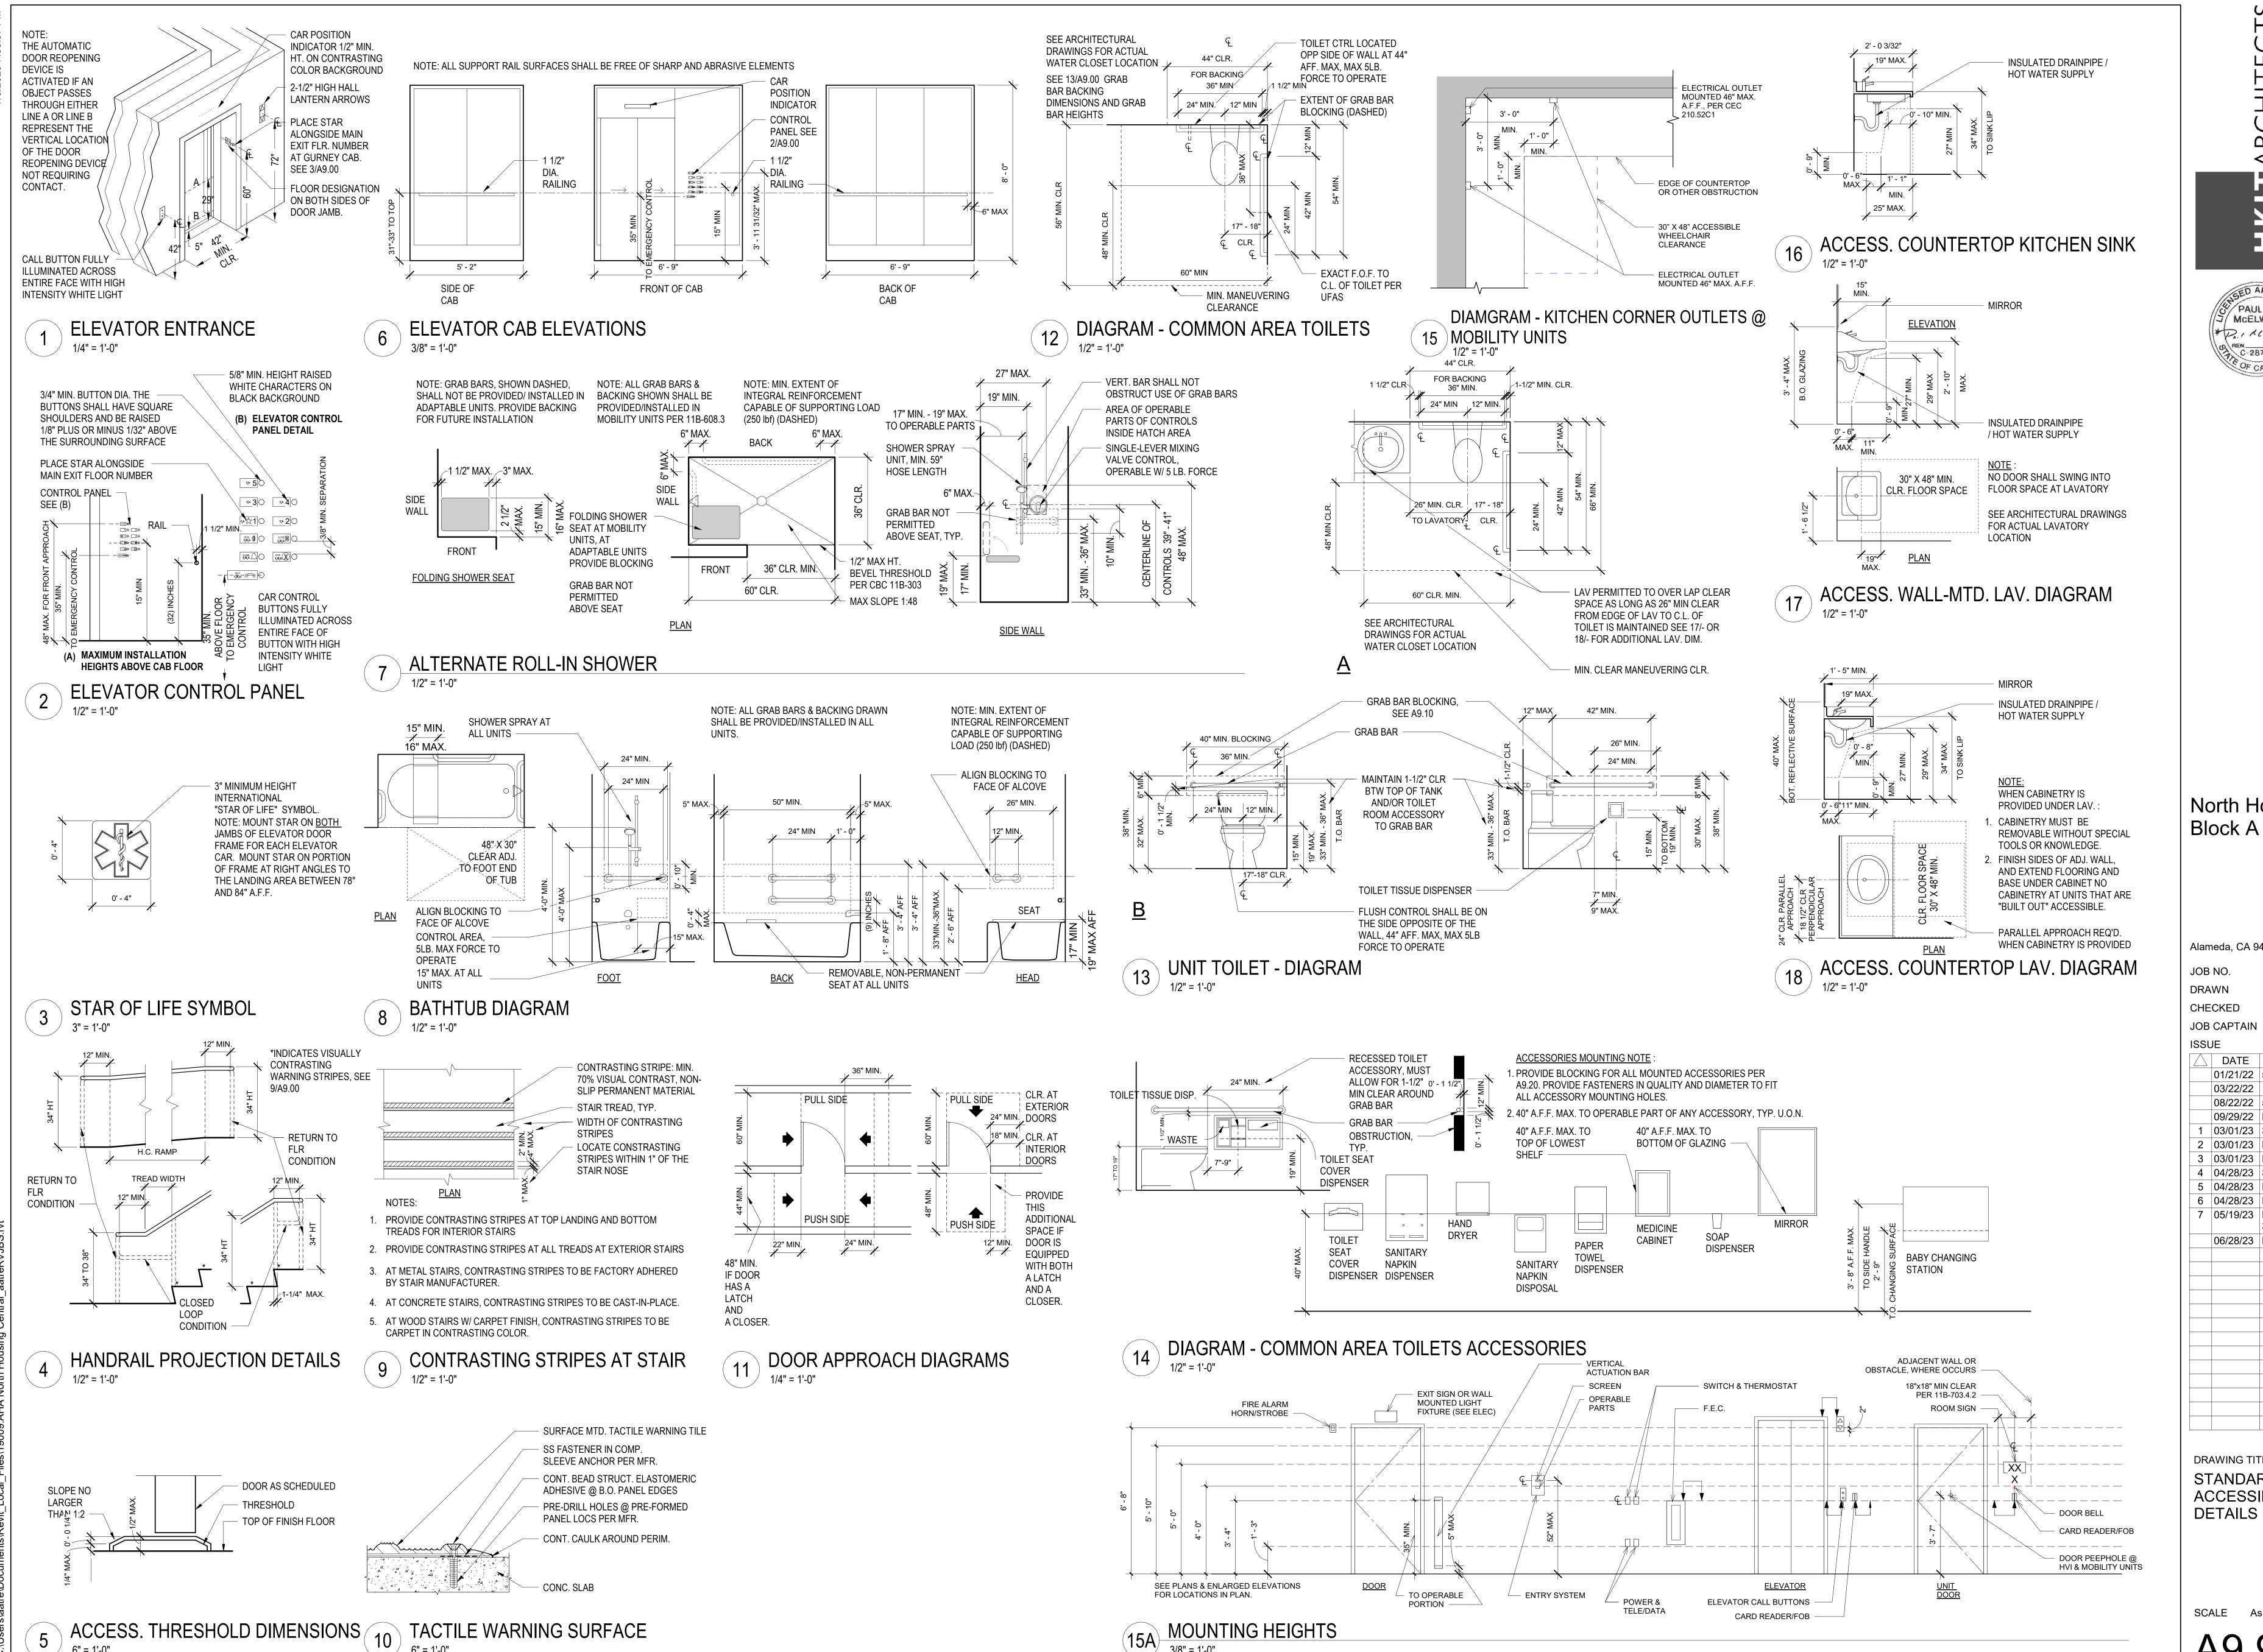

GED ARCH PAUL M J MCELWEE (\*P3.1 xcc OF CALIFOR

North Housing,

Alameda, CA 94501

JOB NO. **DRAWN** 

JOB CAPTAIN

DESCRIPTION

01/21/22 | 50% DD SET 03/22/22 | 100% DD SET 08/22/22 50% CD SET

09/29/22 PERMIT SUBMITTAL

1 | 03/01/23 | Senior Resubmittal 1

2 | 03/01/23 | PSH 1 Resubmittal

3 | 03/01/23 | PSH 2 Resubmittal

4 | 04/28/23 | Senior Resubmittal 2


5 | 04/28/23 | PSH 1 Resubmittal 2

6 | 04/28/23 | PSH 2 Resubmittal 2 7 05/19/23 PSH 1&2 Resubmittal

06/28/23 BID SET

DRAWING TITLE STANDARD **ACCESSIBILITY** 

SCALE As indicated

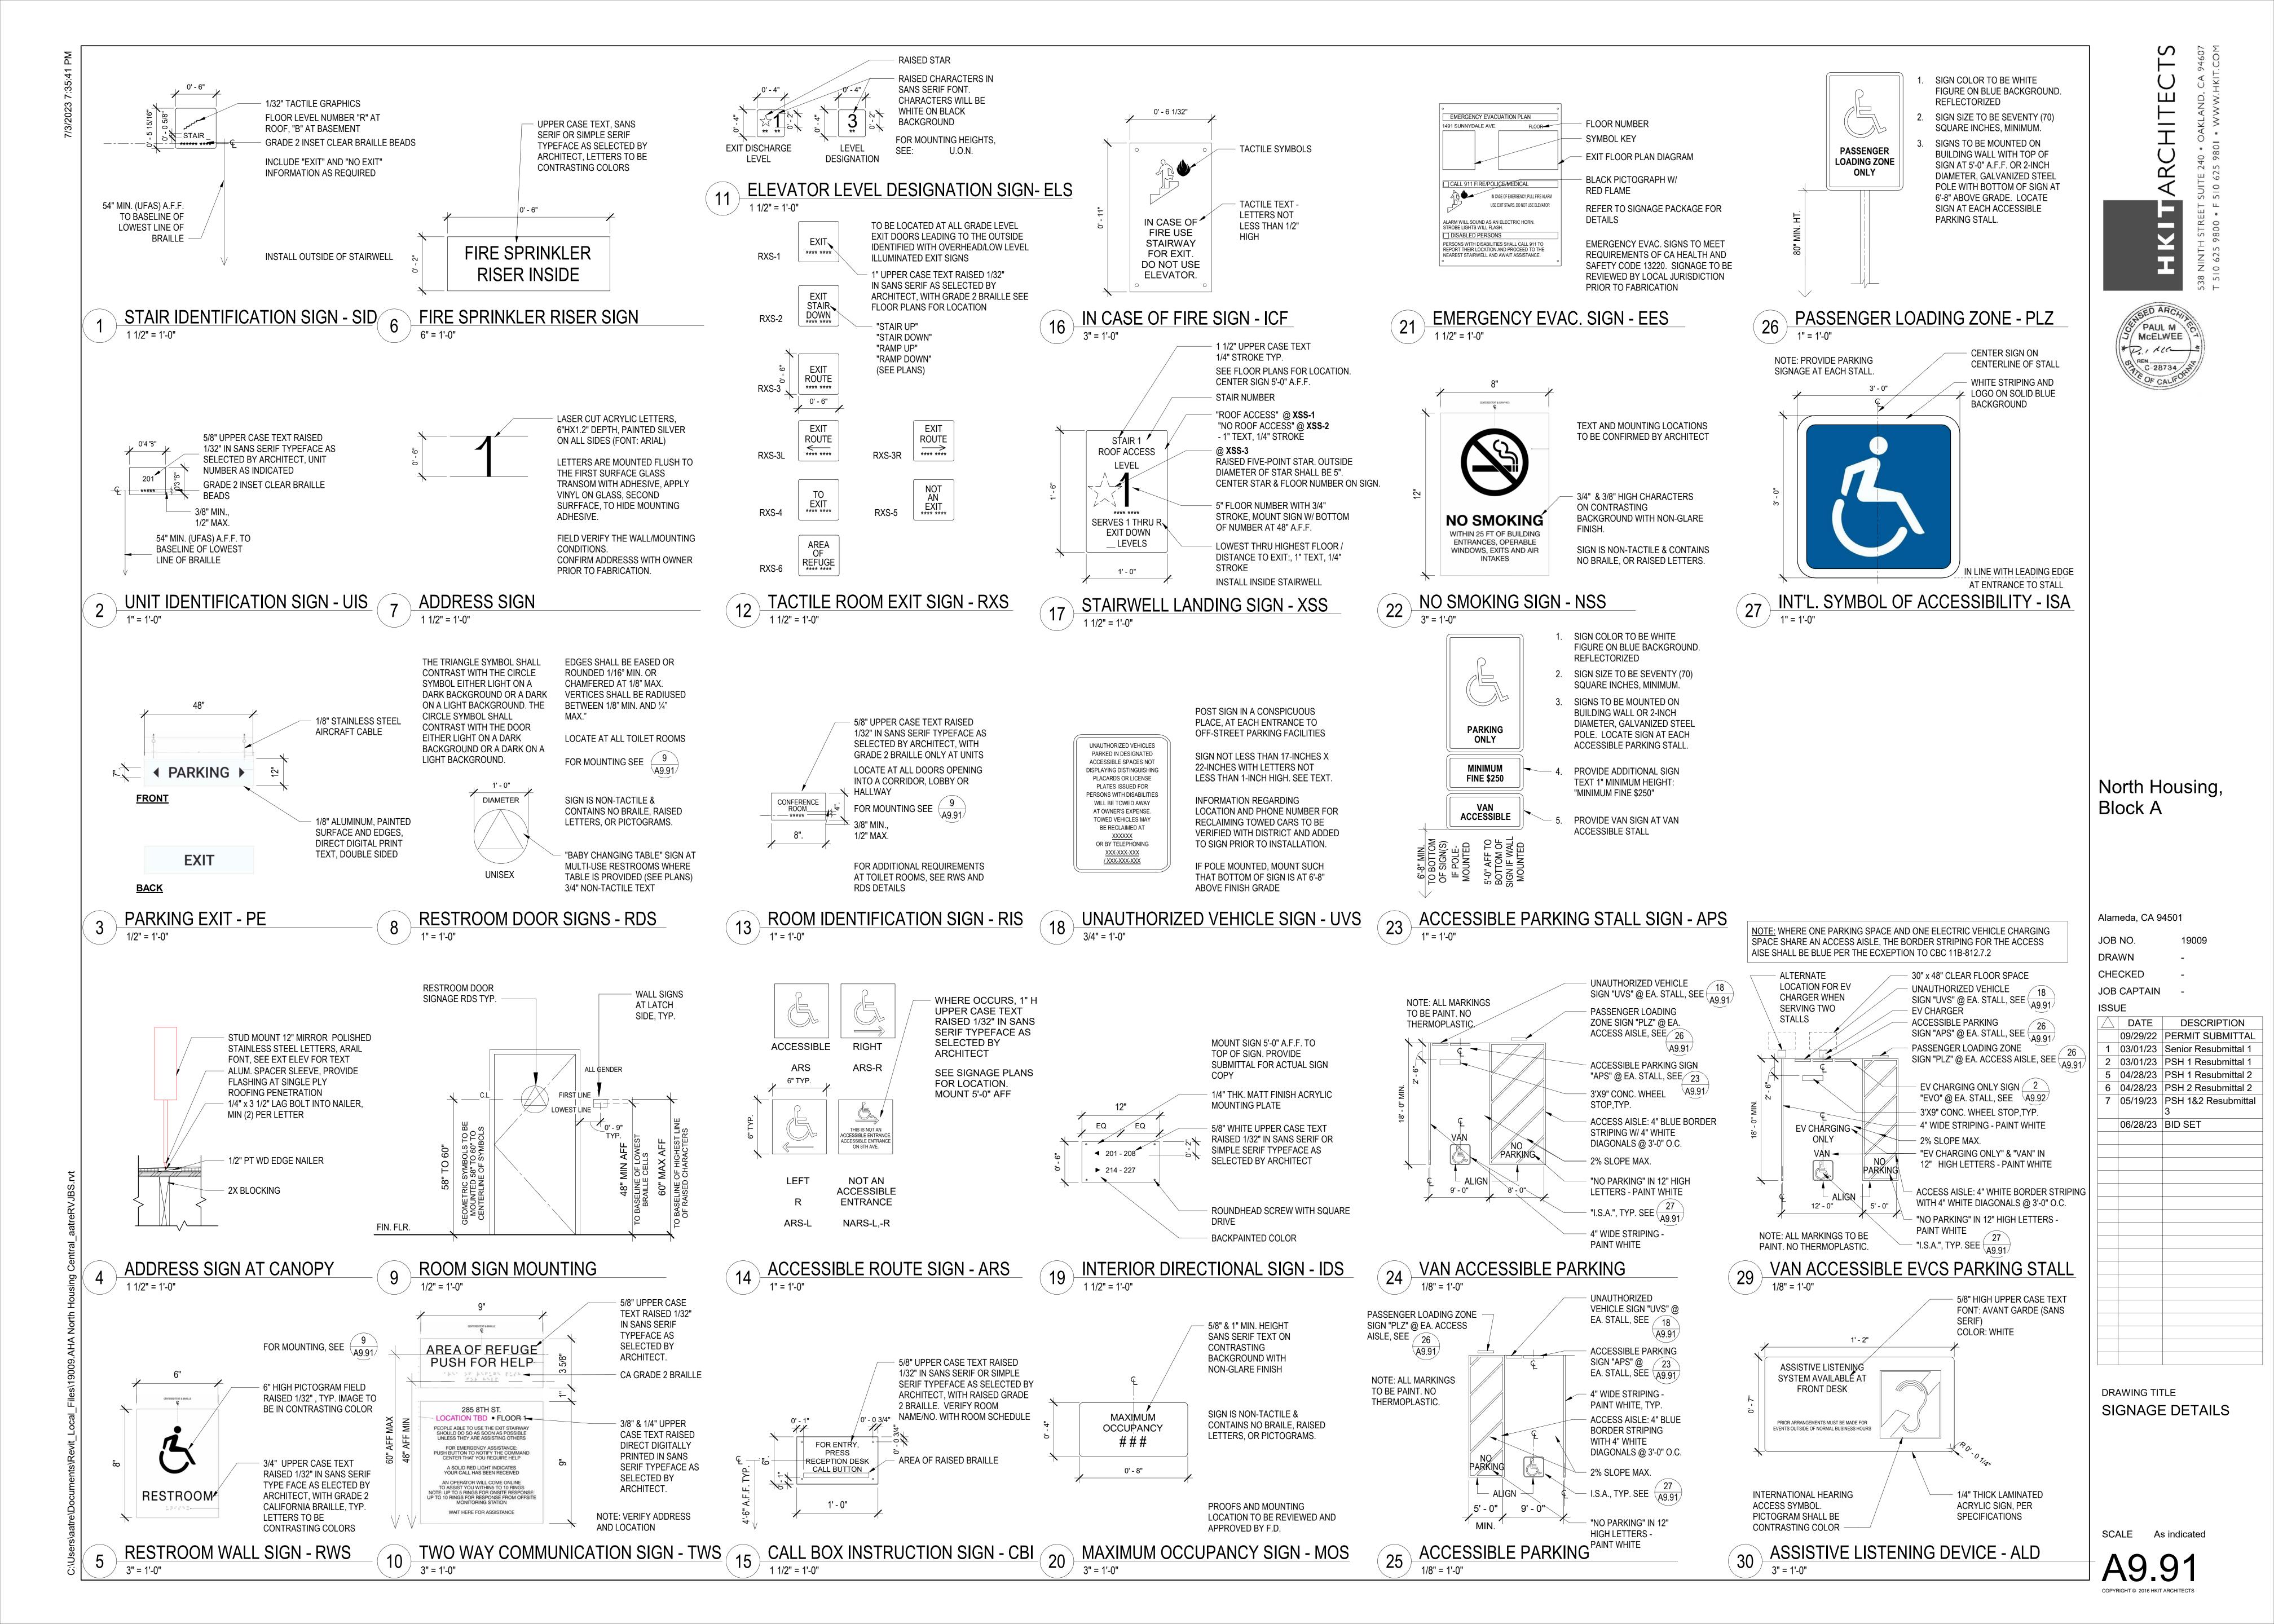



North Housing, Block A

Alameda, CA 94501

JOB NO. 19

DRAWN -

CHECKED -JOB CAPTAIN -

ISSUE

DATE DESCRIPTION
2 03/01/23 PSH 1 Resubmittal 1


7 05/19/23 PSH 1&2 Resubmittal 3 06/28/23 BID SET

06/28/23 BID SET

DRAWING TITLE
SIGNAGE DETAILS

SCALE As indicate



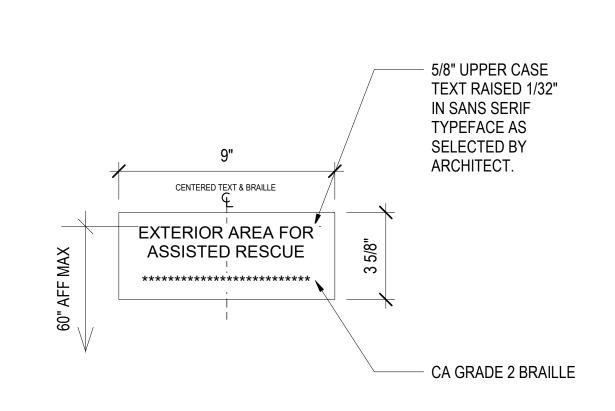

# EXTERIOR AREA FOR ASSISTED RESCUE SIGN -

1 EAR
3" = 1'-0"

ALIGN TOP WITH ADJACENT SIGNS WHERE OCCURS

1. SIGN COLOR TO BE BLACK TEXT ON WHITE BACKGROUND. REFLECTORIZED

2. SIGN SIZE TO BE SEVENTY (70) SQUARE INCHES, MINIMUM.

3. SIGNS TO BE MOUNTED ON BUILDING WALL OR 2-INCH DIAMETER, GALVANIZED STEEL POLE. LOCATE SIGN AT EACH EVCS PARKING STALL.

2 EV CHARGING ONLY SIGN - EVO 1" = 1'-0"

s\Revit\_Local\_Files\19009.AHA North Housing Central\_aatreR



North Housing, Block A

PSH PHASE 2

520 MOSLEY AVENUE ALAMEDA, CA 94501


JOB NO.

JOB CAPTAIN

DESCRIPTION 03/22/22 100% DD SET 08/22/22 50% CD SET 09/29/22 PERMIT SUBMITTAL 3 03/01/23 PSH 2 Resubmittal 1 06/28/23 BID SET


DRAWING TITLE PSH 2 - LEVEL 1 FINISH PLAN

SCALE 1/8" = 1'-0"

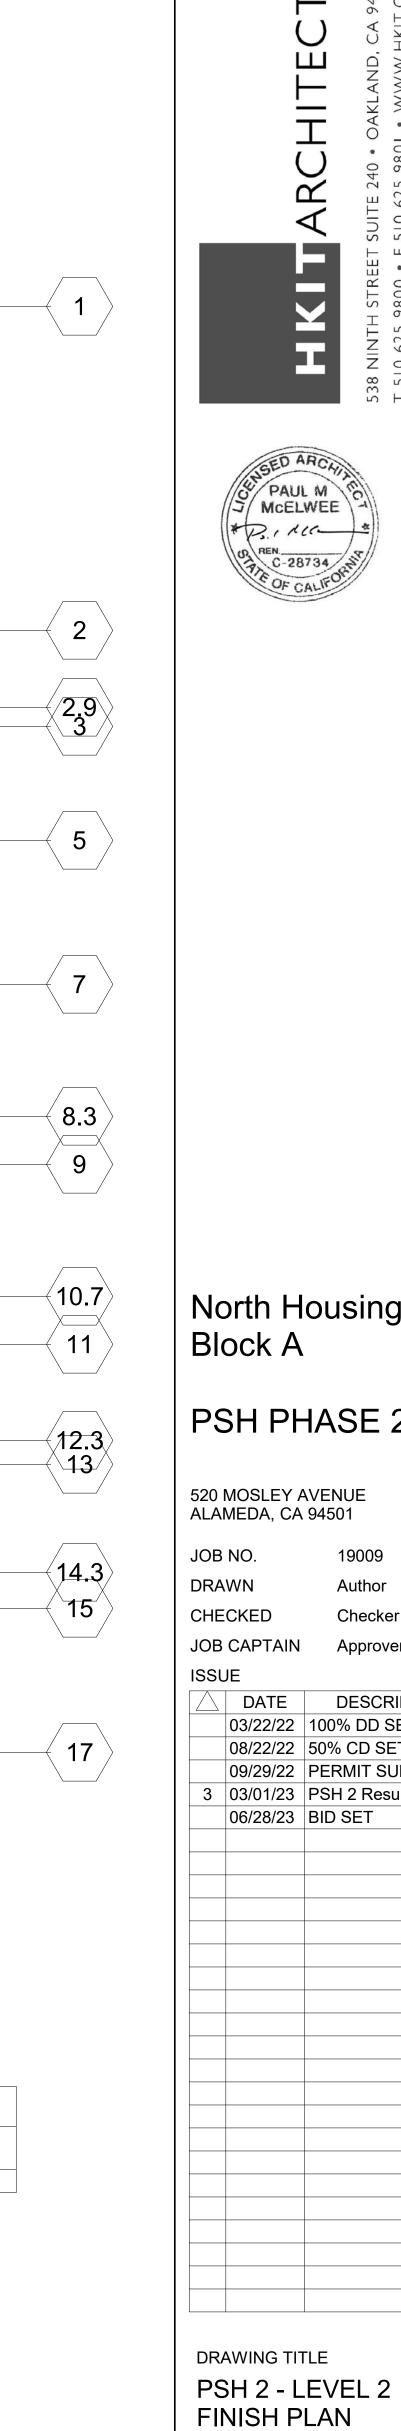

SCALE 1/8" = 1'-0"

DESCRIPTION

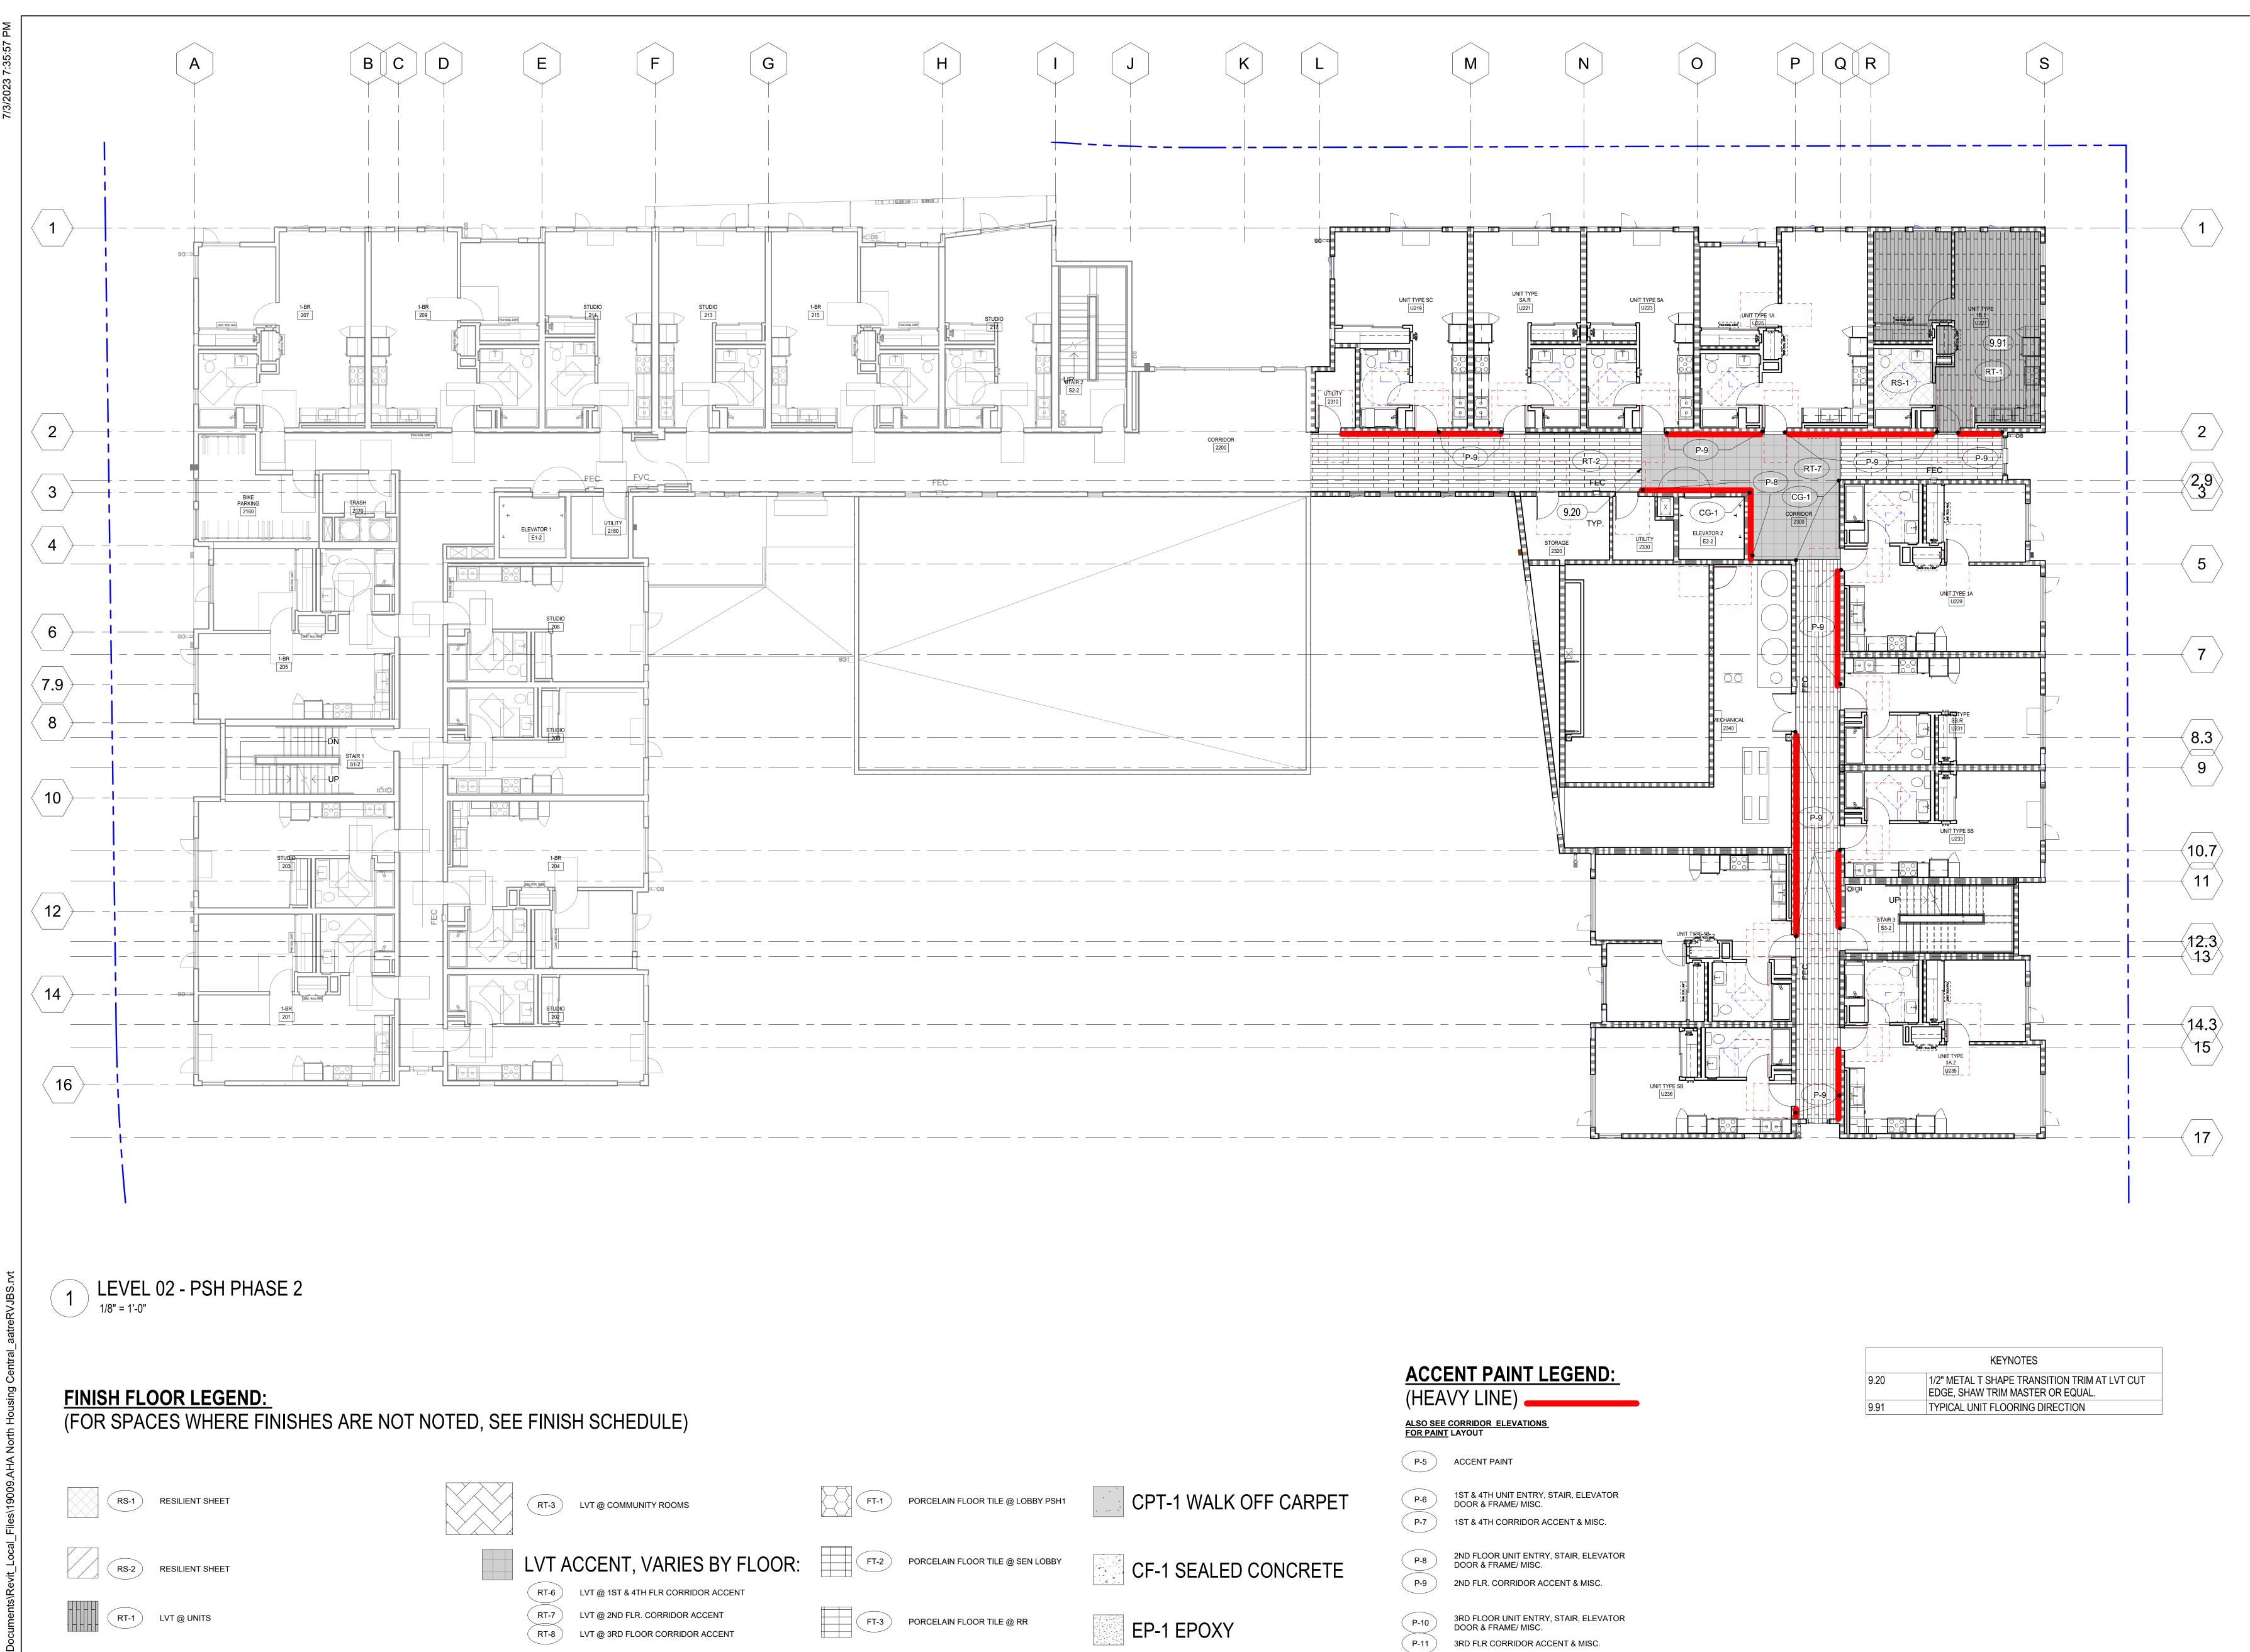

CPT-1 WALK-OFF CARPET

RECESSED WALK OFF MAT

(WM-1)

RT-2 LVT @ OFFICES & CORRIDORS



North Housing,

PSH PHASE 2

520 MOSLEY AVENUE ALAMEDA, CA 94501

DESCRIPTION 08/22/22 50% CD SET

09/29/22 PERMIT SUBMITTAL 3 03/01/23 PSH 2 Resubmittal 1 06/28/23 BID SET

DRAWING TITLE PSH 2 - LEVEL 3

SCALE 1/8" = 1'-0"

North Housing, Block A

PSH PHASE 2

520 MOSLEY AVENUE ALAMEDA, CA 94501

DESCRIPTION 08/22/22 50% CD SET

09/29/22 PERMIT SUBMITTAL 3 03/01/23 PSH 2 Resubmittal 1 06/28/23 BID SET

DRAWING TITLE PSH 2 - LEVEL 4

SCALE 1/8" = 1'-0"

ROOM NAME

CORRIDOR

CORRIDOR

BIKE PARKING

COMMUNITY ROOM

COMMUNITY ROOM

COMMUNITY ROOM

RESTROOM

STORAGE

ELECTRICAL

ELECTRICAL

MAINTENANCE

BREAKOUT ROOM

WORK AREA

PUMP ROOM

OFFICE

OFFICE

OFFICE

FILE ROOM

	DOOR SCHEDULE ABBRE\
DWARE (SEE DOOR HARDWARE KEY)	AL = ALUMINUM DOOR / FRAME HM = HOLLOW METAL DOOR / FRAME HM-G = GALVANIZED HOLLOW METAL DOOR / FRAME STL = STEEL DOOR / FRAME STL-G = GALVANIZED STEEL DOOR/FRAME SC WD = SOLID CORE WOOD HC WD = HOLLOW CORE WOOD SS = STAINLESS STEEL AN-CL = ALUMINUM ANODIZED FINISH, CLEAR AN-DB = ALUMINUM ANODIZED FINISH, DARK BRON ST= STAIN GRADE MATERIAL WITH STAIN FINISH PA = PAINT GRADE MATERIAL WITH PAINT FINISH
	GENERAL NOTES- DOOR S
	1. PROVIDE ROOM IDENTIFICATION SIGNAGE, UNIT A DOORS, SEE A10.50 AND A10.51 FOR ADDITIONAL INI
	2. ALL EXIT DOORS SHALL OPEN FROM THE INSIDE V

SIGNAGE

RIS

RIS

A,B,J,E,I, S

C,N,E,L,P

A,C,N,E

C,N,E,L,P

A,C,N,E

P,L,E,K

P.L.E.K

MOS. RXS-1 A.B.I.J.R.E. S

REMARKS / DOOR HARD

GROUP | PULL SIDE | PUSH SIDE |

RIS

COLOR

(EXT/INT)

EXT/P-2

P-2

P-2

P-2

P-2

P-2

P-2

P-2

P-2

MATCH

EXT/P-2

MATCH

EXT/P-2

HARDWARE

34

	DOOR AND HARDWARE SCHEDULE - PSH 2 - LEVEL 2																	
		DC	OOR			DO	OR			DETAILS			FRAME		HARDWARE	SIGNA	GE	
ROOM NAME	DOOR NO.	WIDTH	HEIGHT	FIRE RATING	TYPE	MATERIAL	FINISH	COLOR	THRESHOL	D HEAD	JAMB	MATERIAL	FINISH	COLOR	GROUP	PULL SIDE   1	PUSH SIDE	REMARKS / DOOR HARDWARE (SEE DOOR HARDWARE KEY)
UTILITY	2310	3' - 0"	6' - 8"	20 MIN.	Α	SC WD	PA	P-2	19/A9.50	26/A9.50	27/A9.50	HM	PA	P-2	18		RIS	C,E,N,P,L
STORAGE	2320	3' - 0"	6' - 8"	20 MIN.	Α	SC WD	PA	P-2	19/A9.50	26/A9.50	27/A9.50	HM	PA	P-2	16		RIS	E,C,N
UTILITY	2330	3' - 0"	6' - 8"	20 MIN.	Α	SC WD	PA	P-2	19/A9.50	26/A9.50	27/A9.50	HM	PA	P-2	18		RIS	C,E,N,P,L
MECHANICAL	2340.1	5' - 0"	6' - 8"	20 MIN.	Α	HM-G	PA	P-2	19/A9.50	26/A9.50	27/A9.50	HM-G	PA	P-2	36		RIS	
MECHANICAL	12340.2	3' - 0"	3' - 0"	-	M	HM-G	PA	P-2				HM-G	PA	P-2	13	RIS		

DOOR AND HARDWARE SCHEDULE - PSH 2 - LEVEL 1

HEAD

26/A9.50

26/A9.50

26/A9.50

26/A9.50

6/A8.50

26/A9.50

26/A9.50

26/A9.50

26/A9.50

26/A9.50

19/A9.50 | 26/A9.50

11/A8.50

11&17/A8.51 | 13/A8.51

JAMB

27/A9.50

27/A9.50

27/A9.50

12/A8.50

27/A9.50

27/A9.50

7/A8.50

27/A9.50

27/A9.50

27/A9.50

27/A9.50

27/A9.50

27/A9.50

27/A9.50

27/A9.50

MATERIAL

AL

HM

HM

MFR

HM

HM

HM-G

 $\mathsf{HM}$ 

HM

HM

HM

HM

HM

HM

FINISH

DOOR

FINISH

PA

STAIN & SEAL

STAIN & SEAL

MFR

STAIN & SEAL

PA

PA

PA

PΑ

PA

STAIN & SEAL

FIRE RATING TYPE MATERIAL

SC WD

HM-G

MFR

20 MIN.

20 MIN.

45 MIN.

20 MIN.

20 MIN.

20 MIN.

-

-

-

COLOR

EXT/P-2

P-2

MATCH

EXT/P-2

MATCH

EXT/P-2

(EXT/INT) | THRESHOLD |

25/A8.50

19/A9.50

30/A8.50

19/A9.50

20/A9.50

30/A8.50

20/A9.50

19/A9.50

19/A9.50

19/A9.50

19/A9.50

DOOR

3' - 0 1/4" | 6' - 10 3/4"

3' - 0"

3' - 0"

3' - 0"

3' - 0"

9' - 0"

3' - 0"

3' - 0"

3' - 0"

3' - 0"

5' - 0"

3' - 0"

3' - 0"

3' - 0"

3' - 0"

3' - 0"

HEIGHT

6' - 8"

7' - 0"

6' - 8"

6' - 8"

DOOR NO.

1300.2

1300.3

1310

1320

1330.1

1330.2

1330.3

1330B

1350.1

1350.2

1360

1370

1380

1510.2

1520


1530

1540

1550

	DOOR AND HARDWARE SCHEDULE - PSH 2 - LEVEL 3																	
		DC	OOR			DO	OR			DETAILS			FRAME		HARDWARE	SIGN	NAGE	
ROOM NAME	DOOR NO.	WIDTH	HEIGHT	FIRE RATING	TYPE	MATERIAL	FINISH	COLOR	THRESHOLD	HEAD	JAMB	MATERIAL	FINISH	COLOR	GROUP	PULL SIDE	PUSH SIDE	REMARKS / DOOR HARDWARE (SEE DOOR HARDWARE KEY)
UTILITY	3310	3' - 0"	6' - 8"	20 MIN. A	1	SC WD	PA	P-2	19/A9.50	26/A9.50	27/A9.50	HM	PA	P-2	18		RIS	C,N,E,L,P
UTILITY	3320	3' - 0"	6' - 8"	90 MIN. A	1	SC WD	PA	P-2	19/A9.50	26/A9.50	27/A9.50	НМ	PA	P-2	18		RIS	C,N,E,L,P

	DOOR AND HARDWARE SCHEDULE - PSH 2 - LEVEL 4																	
		DC	OOR			DO	OR			DETAILS			FRAME		HARDWARE	SIGN	IAGE	
ROOM NAME	DOOR NO.	WIDTH	HEIGHT	FIRE RATING	TYPE	MATERIAL	FINISH	COLOR	THRESHOLD	HEAD	JAMB	MATERIAL	FINISH	COLOR	GROUP	PULL SIDE	PUSH SIDE	REMARKS / DOOR HARDWARE (SEE DOOR HARDWARE KEY)
UTILITY	4310	3' - 0"	6' - 8"	20 MIN.	Α	SC WD	PA	P-2	19/A9.50	26/A9.50	27/A9.50	HM	PA	P-2	18		RIS	C,N,E,L,P
STORAGE	4320	3' - 0"	6' - 8"	20 MIN.	Α	SC WD	PA	P-2	19/A9.50	26/A9.50	27/A9.50	HM	PA	P-2	16		RIS	E,C,N
ELEV. ROOM	4330	4' - 0"	7' - 0"	45 MIN.	Α	SC WD	PA	P-2	19/A9.50	26/A9.50	27/A9.50	HM	PA	P-2	19	RIS		A,C,E,N,P,L

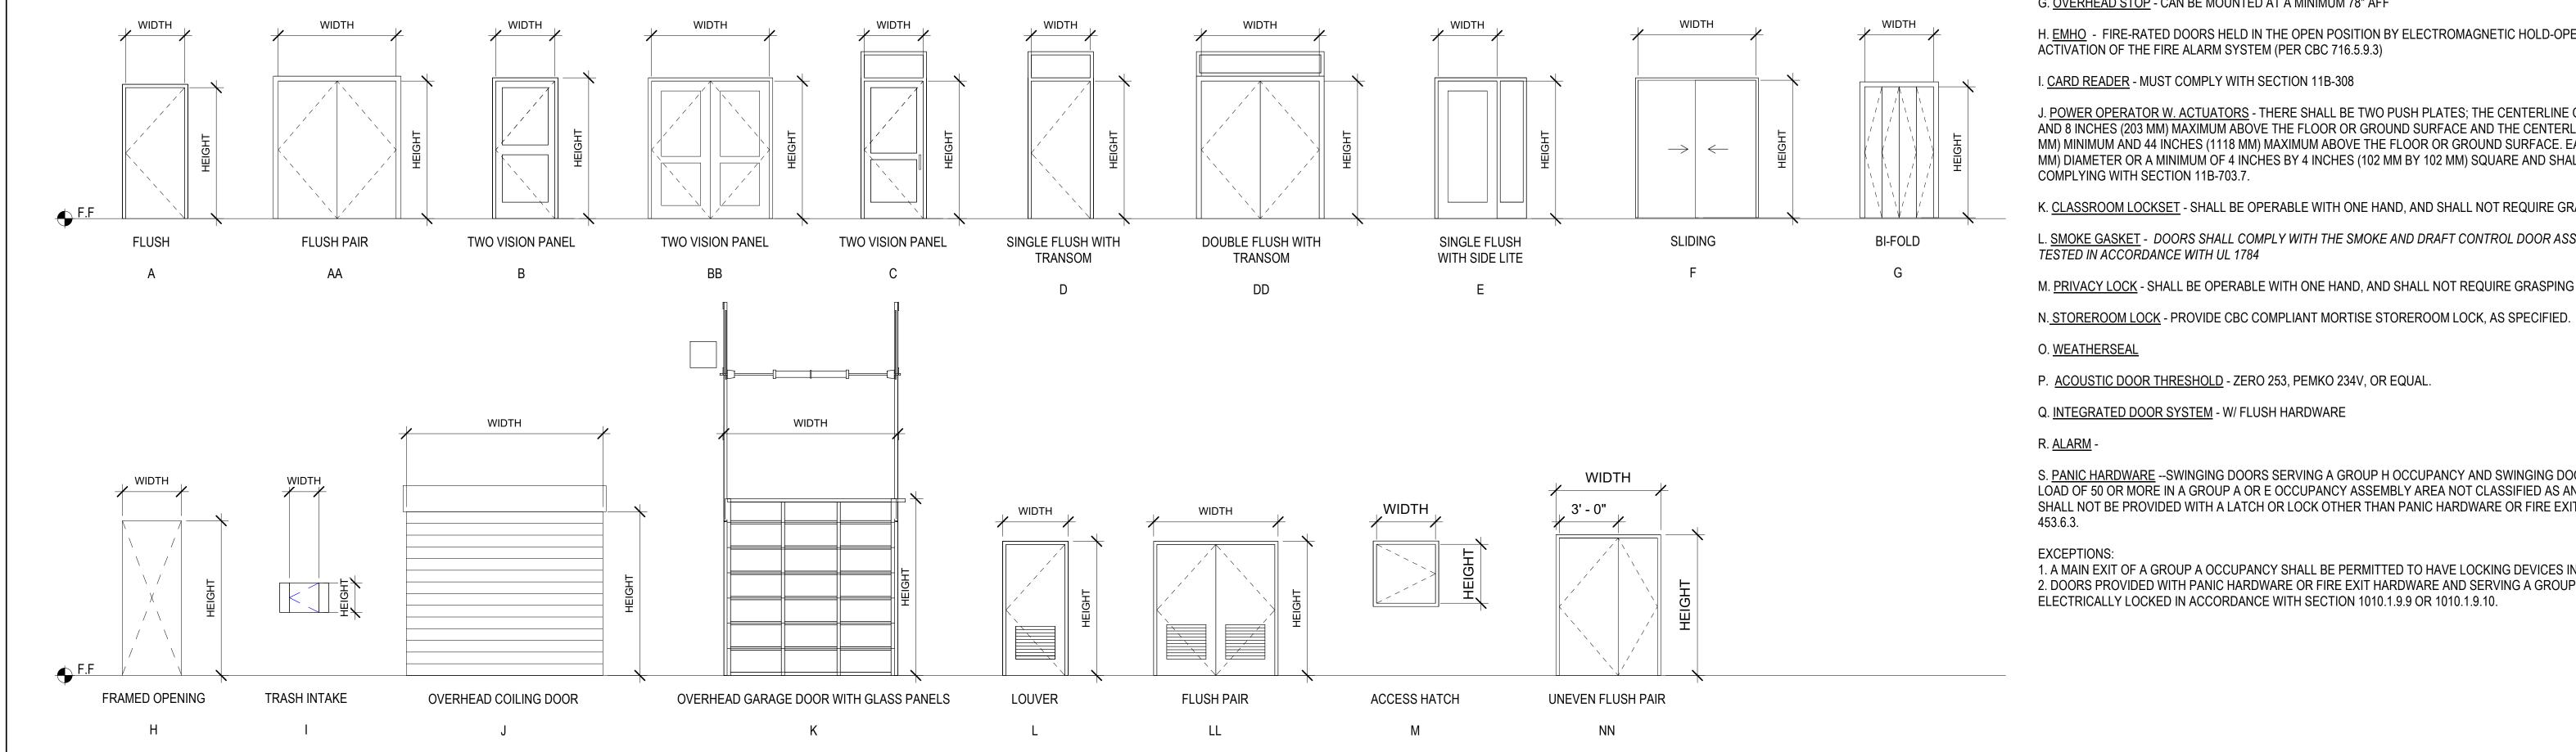

#### SCHEDULE ABBREVIATIONS

DOOR / FRAME METAL DOOR / FRAME ANIZED HOLLOW METAL DOOR / FRAME

OW CORE WOOD SS STEEL INUM ANODIZED FINISH, CLEAR INUM ANODIZED FINISH, DARK BRONZE DE MATERIAL WITH STAIN FINISH

MFR = MANUFACTURER / FACTORY FINISH SA = SATIN SHEEN SG = SEMI-GLOSS SHEEN = SEE GLAZING SCHEDULE

MA = MATCH ADJACENT WALL COLOR NR = NON-RATED = NOT APPLICABLE

EMHO = ELECTRO-MAGNETIC HOLD OPEN, TIED TO FIRE ALARM SYSTEM PVDF = FLUOROPOLYMER 70% PVDF 2-COAT

#### L NOTES-DOOR SCHEDULE

OM IDENTIFICATION SIGNAGE, UNIT ADDRESS SIGNAGE, AND CODE-REQUIRED EGRESS AND WAYFINDING SIGNAGE TYPICAL AT ALL 10.50 AND A10.51 FOR ADDITIONAL INFO

DRS SHALL OPEN FROM THE INSIDE WITHOUT A KEY OR SPECIAL KNOWLEDGE

3. THE MAXIMUM OPERATING FORCE OF DOORS SHALL NOT EXCEED 5.0 LB FOR EXTERIOR DOOR AND 5LB FOR INTERIOR DOORS, SUCH PULL OR PUSH EFFORT BEING APPLIED AT RIGHT ANGLES TO HINGED DOORS AND AT THE CENTER PLANE OF SLIDING OR FOLDING DOORS. COMPENSATING DEVICES OR AUTOMATIC DOOR OPERATORS MAY BE UTILIZED TO MEET THESE STANDARDS. WHEN FIRE DOORS ARE REQUIRED, THE MAX. EFFORT TO OPERATE THE DOOR MAY BE INCREASED TO THE MINIMUM ALLOWABLE BY THE APPROPRIATE ENFORCEMENT AGENCY, NOT TO EXCEED 15LB

4. DOOR LOCKING AND LATCHING HARDWARE INCLUDING SEPARATE BOLTS OR KEYHOLES SHALL BE LOCATED AT 36" A.F.F. AND SHALL NOT REQUIRE GRASPING OR TWISTING OF THE WRIST TO OPERATE

5. MAXIMUM THRESHOLD HEIGHT SHALL BE 1/2". SEE DETAIL ON A9.00 FOR THRESHOLD PROFILE REQUIREMENTS

6. PROVIDE ILLUMINATED EXIT SIGNAGE, S.E.D.

OF THE FIRE ALARM SYSTEM (PER CBC 716.5.9.3)

7. ALL EXT. AND WET AREA H.M. DOORS AND FRAMES TO BE GALVANIZED, SEE SPECIFICATIONS

8. PROVIDE COMPRESSION SEALS ALL SIDES AT EXTERIOR DOORS

9. SEE SHEET A8.40 FOR TYPICAL EXTERIOR DOOR DETAILS. SEE SHEET A9.40 FOR TYPICAL INTERIOR DOOR DETAILS

10. PAINTED DOOR, DOOR FRAME AND MANUFACTURER FINISHED PAINTED SURFACES TO BE SEMI-GLOSS FINISH, U.O.N. \*COLOR TO MATCH PAINT ACCENT COLOR AT CORRIDOR SIDE. UNIT SIDE TO BE 'P-1'

11. PROVIDE A 10" SMOOTH, UNINTURRUPTED SURFACE AT BASE OF SWINGING DOORS OR GATES (AT PUSH SIDE), EXTENDING THE FULL WIDTH OF DOOR OR GATE.

12. FIRE-RATED DOORS HELD IN THE OPEN POSITION BY ELECTROMAGNETIC HOLD-OPEN DEVICES SHALL BE AUTOMATIC CLOSING UPON ACTIVATION

13. ALL DOORS, EXCEPT BI-PASS AND BI-FOLD CLOSET DOORS, SHALL HAVE A LATCH OR LOCK SET WITH LEVER HARDWARE

14. SMOKE AND DRAFT CONTROL TESTED PER CBC 716.5.3.1 IN ACCORDANCE WITH UL1784 WITHOUT ARTIFICIAL BOTTOM SEAL. DOOR DESIGN COMPLIES WITH CBC SECTION 3002.6, PENDING FIELD VERIFICATION BY FIELD INSPECTOR

15. ENTRY UNIT LOCKS SHALL BE PROVIDED WITH A COMBINATION 1/2-INCH (12.7 MM) THROW DEADLATCH WITH A MINIMUM 1-INCH (25.4 MM) THROW DEADBOLT, AND SO CONSTRUCTED THAT BOTH THE DEADLATCH AND DEADBOLT RETRACT SIMULTANEOUSLY BY KNOB OR LEVER.

16. HANDLES, PULLS, LATCHES, LOCKS AND OTHER OPERABLE PARTS ON DOORS TO BE LOCATED AT 36" (34" MIN AND 44 " MAX.) ABOVE THE FINISH FLOOR OR GROUND. DOOR HARDWARE SHALL NOT REQUIRE GRASPING OR TWISTING TO OPERATE.

17. DOOR CLOSERS AND GATE CLOSERS SHALL BE ADJUSTED SO THAT FROM AN OPEN POSITION OF 90 DEGREES, THE TIME REQUIRED TO MOVE THE DOOR TO A POSITION OF 12 DEGREES FROM THE LATCH IS 5 SECONDS MINIMUM

18. REFER TO GLAZING SCHEDULE ON WINDOW SCHEDULE SHEET. PROVIDE FIRE RATING AS INDICATED ON SCHEDULE

19. FIRE DOORS IN HORIZONTAL EXITS SHALL BE SELF- CLOSING OR AUTOMATIC-CLOSING WHEN ACTIVATED BY A SMOKE DETECTOR IN ACCORDANCE WITH SECTION 716.2.6.6. DOORS, WHERE LOCATED IN A CROSS-CORRIDOR CONDITION, SHALL BE AUTOMATIC-CLOSING BY ACTIVATION OF A SMOKE DETECTOR INSTALLED IN ACCORDANCE WITH SECTION 716.2.6.6. (1026.3 CBC)

## DOOR HARDWARE KEY

A. <u>CLOSER</u> - DOOR CLOSERS AND GATE CLOSERS SHALL BE ADJUSTED SO THAT FROM AN OPEN POSITION OF 90 DEGREES, THE TIME REQUIRED TO MOVE THE DOOR TO A POSITION OF 12 DEGREES FROM THE LATCH IS 5 SECONDS MINIMUM. MOUNTED AT MINIMUM 78" AFF.

B. <u>EXIT DEVICE</u> - ALL EXIT DOORS SHALL OPEN FROM THE INSIDE WITHOUT A KEY OR SPECIAL KNOWLEDGE.

C. <u>KICK PLATE</u> - PROVIDE A 10" SMOOTH, UNINTURRUPTED SURFACE AT BASE OF SWINGING DOORS OR GATES (AT PUSH SIDE), EXTENDING THE FULL WIDTH OF DOOR OR GATE.

D. ENTRY UNIT LOCK - ENTRY UNIT LOCKS SHALL BE PROVIDED WITH A COMBINATION 1/2-INCH (12.7 MM) THROW DEADLATCH WITH A MINIMUM 1-INCH (25.4 MM) THROW DEADBOLT, AND SO CONSTRUCTED THAT BOTH THE DEADLATCH AND DEADBOLT RETRACT SIMULTANEOUSLY BY KNOB OR LEVER.

E. <u>THRESHOLD</u> - MAXIMUM THRESHOLD HEIGHT SHALL BE 1/2". SEE DETAIL ON A9.00 FOR THRESHOLD PROFILE REQUIREMENTS

F. COORDINATOR - CAN BE MOUNTED AT A MINIMUM 80" AFF

G. OVERHEAD STOP - CAN BE MOUNTED AT A MINIMUM 78" AFF

H. <u>EMHO</u> - FIRE-RATED DOORS HELD IN THE OPEN POSITION BY ELECTROMAGNETIC HOLD-OPEN DEVICES SHALL BE AUTOMATIC CLOSING UPON ACTIVATION OF THE FIRE ALARM SYSTEM (PER CBC 716.5.9.3)

I. <u>CARD READER</u> - MUST COMPLY WITH SECTION 11B-308

J. <u>POWER OPERATOR W. ACTUATORS</u> - THERE SHALL BE TWO PUSH PLATES; THE CENTERLINE OF ONE PUSH PLATE SHALL BE 7 INCHES (178 MM) MINIMUM AND 8 INCHES (203 MM) MAXIMUM ABOVE THE FLOOR OR GROUND SURFACE AND THE CENTERLINE OF THE SECOND PUSH PLATE SHALL BE 30 INCHES (762 MM) MINIMUM AND 44 INCHES (1118 MM) MAXIMUM ABOVE THE FLOOR OR GROUND SURFACE. EACH PUSH PLATE SHALL BE A MINIMUM OF 4 INCHES (102 MM) DIAMETER OR A MINIMUM OF 4 INCHES BY 4 INCHES (102 MM BY 102 MM) SQUARE AND SHALL DISPLAY THE INTERNATIONAL SYMBOL OF ACCESSIBILITY

K. CLASSROOM LOCKSET - SHALL BE OPERABLE WITH ONE HAND, AND SHALL NOT REQUIRE GRASPING OR TWISTING OF THE WRIST TO OPERATE

L. <u>SMOKE GASKET</u> - DOORS SHALL COMPLY WITH THE SMOKE AND DRAFT CONTROL DOOR ASSEMBLY REQUIREMENTS IN SECTION 716.2.2.1.1 WHEN TESTED IN ACCORDANCE WITH UL 1784

M. PRIVACY LOCK - SHALL BE OPERABLE WITH ONE HAND, AND SHALL NOT REQUIRE GRASPING OR TWISTING OF THE WRIST TO OPERATE

O. <u>WEATHERSEAL</u>

P. <u>ACOUSTIC DOOR THRESHOLD</u> - ZERO 253, PEMKO 234V, OR EQUAL.

Q. <u>INTEGRATED DOOR SYSTEM</u> - W/ FLUSH HARDWARE

S. PANIC HARDWARE -- SWINGING DOORS SERVING A GROUP H OCCUPANCY AND SWINGING DOORS SERVING ROOMS OR SPACES WITH AN OCCUPANT LOAD OF 50 OR MORE IN A GROUP A OR E OCCUPANCY ASSEMBLY AREA NOT CLASSIFIED AS AN ASSEMBLY OCCUPANCY E, I-2 OR I-2.1 OCCUPANCIES SHALL NOT BE PROVIDED WITH A LATCH OR LOCK OTHER THAN PANIC HARDWARE OR FIRE EXIT HARDWARE. FOR GROUP L OCCUPANCIES SEE SECTION

**EXCEPTIONS:** 

1. A MAIN EXIT OF A GROUP A OCCUPANCY SHALL BE PERMITTED TO HAVE LOCKING DEVICES IN ACCORDANCE WITH SECTION 1010.1.9.4, ITEM 2. 2. DOORS PROVIDED WITH PANIC HARDWARE OR FIRE EXIT HARDWARE AND SERVING A GROUP A OR E OCCUPANCY SHALL BE PERMITTED TO BE ELECTRICALLY LOCKED IN ACCORDANCE WITH SECTION 1010.1.9.9 OR 1010.1.9.10.

North Housing, Block A

GED ARCH

MCELWEE

\*PS. 1 ACC

OF CALIFOR

PAUL M

PSH PHASE 2

520 MOSLEY AVENUE ALAMEDA, CA 94501

JOB NO. DRAWN CHECKED Checker

JOB CAPTAIN ISSUE

DESCRIPTION 12/8/21 | SD SET 03/22/22 | 100% DD SET 08/22/22 | 50% CD SET 09/29/22 PERMIT SUBMITTAL 3 | 03/01/23 | PSH 2 Resubmittal 1 06/28/23 | BID SET

Approver

DRAWING TITLE PSH 2 - DOOR SCHEDULE AND **DOOR TYPES** 

SCALE 1/4" = 1'-0"

**ROOM NAME** 

**ROOM NAME** 

**ROOM NAME** 

**ELEVATOR 2** 

ELEVATOR 2

**ELEVATOR 2** 

STAIR 3

STAIR 3

STAIR 3

STAIR 3

CLOSET

UNIT ENTRY

BATHROOM

CLOSET

DOOR NO.

E2-2

E2-3

E2-4

DOOR NO.

S3-1.1

S3-3

S3-4

S3-R

S3100.5

DOOR NO.

U1

U5.1

XU9IIII

WIDTH

3' - 6"

3' - 6"

3' - 6"

WIDTH

3' - 0"

3' - 0"

3' - 0"

3' - 0"

3' - 0"

8' - 0"

WIDTH

3' - 0"

6' - 0"

6' - 0"

DOOR

DOOR

HEIGHT

7' - 0"

7' - 0"

7' - 0"

HEIGHT

6' - 8"

6' - 8"

6' - 8"

6' - 8"

**HEIGHT** 

6' - 8"

6' - 8"

6' - 8"

TYPE

TYPE

GLAZING

FIRE RATING

90 MIN.

90 MIN.

FIRE RATING

90 MIN.

90 MIN.

90 MIN.

90 MIN.

90 MIN.

MATERIAL

HM

HM

COLOR

COLOR

**DOOR** 

**FINISH** 

PΑ

PA

FINISH

PA

PA

FINISH

PA

PΑ

PA

PA

PA

SC WD

HC WD

HC WD

DOOR

FIRE RATING | MATERIAL

20 MIN.

-

MATERIAL

HM

HM

# DOOR SCHEDULE ABBREVIATIONS AL= ALUMINUM DOOR / FRAME

REMARKS / DOOR HARDWARE (SEE DOOR HARDWARE KEY)

REMARKS / DOOR HARDWARE (SEE DOOR HARDWARE KEY)

A,C,E,P,L,D, DOOR VIEWER 43" A.F.F. @ HVI & MOBILITY

HM = HOLLOW METAL DOOR / FRAME
HM-G = GALVANIZED HOLLOW METAL DOOR / FRAME
STL = STEEL DOOR / FRAME
STL-G = GALVANIZED STEEL DOOR/FRAME
SC WD = SOLID CORE WOOD
HC WD = HOLLOW CORE WOOD

SC WD = SOLID CORE WOOD

HC WD = HOLLOW CORE WOOD

SS = STAINLESS STEEL

AN-CL = ALUMINUM ANODIZED FINISH, CLEAR

AN-DB = ALUMINUM ANODIZED FINISH, DARK BRONZE

ST= STAIN GRADE MATERIAL WITH STAIN FINISH

PA = PAINT GRADE MATERIAL WITH PAINT FINISH

MFR = MANUFACTURER / FACTORY FINISH
SA = SATIN SHEEN
SG = SEMI-GLOSS SHEEN
= SEE GLAZING SCHEDULE

= SEE GLAZING SCHEDULE

MA = MATCH ADJACENT WALL COLOR

NR = NON-RATED

- = NOT APPLICABLE

- = NOT APPLICABLE

EMHO = ELECTRO-MAGNETIC HOLD OPEN, TIED TO FIRE ALARM SYSTEM

PVDF = FLUOROPOLYMER 70% PVDF 2-COAT

#### GENERAL NOTES- DOOR SCHEDULE

1. PROVIDE ROOM IDENTIFICATION SIGNAGE, UNIT ADDRESS SIGNAGE, AND CODE-REQUIRED EGRESS AND WAYFINDING SIGNAGE TYPICAL AT ALL DOORS. SEE A10.50 AND A10.51 FOR ADDITIONAL INFO

2. ALL EXIT DOORS SHALL OPEN FROM THE INSIDE WITHOUT A KEY OR SPECIAL KNOWLEDGE

3. THE MAXIMUM OPERATING FORCE OF DOORS SHALL NOT EXCEED 5.0 LB FOR EXTERIOR DOOR AND 5LB FOR INTERIOR DOORS, SUCH PULL OR PUSH EFFORT BEING APPLIED AT RIGHT ANGLES TO HINGED DOORS AND AT THE CENTER PLANE OF SLIDING OR FOLDING DOORS. COMPENSATING DEVICES OR AUTOMATIC DOOR OPERATORS MAY BE UTILIZED TO MEET THESE STANDARDS. WHEN FIRE DOORS ARE REQUIRED, THE MAX. EFFORT TO OPERATE THE DOOR MAY BE INCREASED TO THE MINIMUM ALLOWABLE BY THE APPROPRIATE ENFORCEMENT AGENCY, NOT TO EXCEED 15LB

4. DOOR LOCKING AND LATCHING HARDWARE INCLUDING SEPARATE BOLTS OR KEYHOLES SHALL BE LOCATED AT 36" A.F.F. AND SHALL NOT REQUIRE GRASPING OR TWISTING OF THE WRIST TO OPERATE

5. MAXIMUM THRESHOLD HEIGHT SHALL BE 1/2". SEE DETAIL ON A9.00 FOR THRESHOLD PROFILE REQUIREMENTS

6. PROVIDE ILLUMINATED EXIT SIGNAGE, S.E.D.

7. ALL EXT. AND WET AREA H.M. DOORS AND FRAMES TO BE GALVANIZED, SEE SPECIFICATIONS

8. PROVIDE COMPRESSION SEALS ALL SIDES AT EXTERIOR DOORS

9. SEE SHEET A8.40 FOR TYPICAL EXTERIOR DOOR DETAILS. SEE SHEET A9.40 FOR TYPICAL INTERIOR DOOR DETAILS

10. PAINTED DOOR, DOOR FRAME AND MANUFACTURER FINISHED PAINTED SURFACES TO BE SEMI-GLOSS FINISH, U.O.N. \*COLOR TO MATCH PAINT ACCENT COLOR AT CORRIDOR SIDE. UNIT SIDE TO BE 'P-1'

11. PROVIDE A 10" SMOOTH, UNINTURRUPTED SURFACE AT BASE OF SWINGING DOORS OR GATES (AT PUSH SIDE), EXTENDING THE FULL WIDTH OF DOOR OR GATE.

12. FIRE-RATED DOORS HELD IN THE OPEN POSITION BY ELECTROMAGNETIC HOLD-OPEN DEVICES SHALL BE AUTOMATIC CLOSING UPON ACTIVATION OF THE FIRE ALARM SYSTEM (PER CBC 716.5.9.3)

13. ALL DOORS, EXCEPT BI-PASS AND BI-FOLD CLOSET DOORS, SHALL HAVE A LATCH OR LOCK SET WITH LEVER HARDWARE

14. SMOKE AND DRAFT CONTROL TESTED PER CBC 716.5.3.1 IN ACCORDANCE WITH UL1784 WITHOUT ARTIFICIAL BOTTOM SEAL. DOOR DESIGN COMPLIES WITH CBC SECTION 3002.6, PENDING FIELD VERIFICATION BY FIELD INSPECTOR

15. ENTRY UNIT LOCKS SHALL BE PROVIDED WITH A COMBINATION 1/2-INCH (12.7 MM) THROW DEADLATCH WITH A MINIMUM 1-INCH (25.4 MM) THROW DEADBOLT, AND SO CONSTRUCTED THAT BOTH THE DEADLATCH AND DEADBOLT RETRACT SIMULTANEOUSLY BY KNOB OR LEVER.

16. HANDLES, PULLS, LATCHES, LOCKS AND OTHER OPERABLE PARTS ON DOORS TO BE LOCATED AT 36" (34" MIN AND 44 " MAX.) ABOVE THE FINISH FLOOR OR GROUND. DOOR HARDWARE SHALL NOT REQUIRE GRASPING OR TWISTING TO OPERATE."

17. DOOR CLOSERS AND GATE CLOSERS SHALL BE ADJUSTED SO THAT FROM AN OPEN POSITION OF 90 DEGREES, THE TIME REQUIRED TO MOVE THE DOOR TO A POSITION OF 12 DEGREES FROM THE LATCH IS 5 SECONDS MINIMUM

18. REFER TO GLAZING SCHEDULE ON WINDOW SCHEDULE SHEET. PROVIDE FIRE RATING AS INDICATED ON SCHEDULE

19. FIRE DOORS IN HORIZONTAL EXITS SHALL BE SELF- CLOSING OR AUTOMATIC-CLOSING WHEN ACTIVATED BY A SMOKE DETECTOR IN ACCORDANCE WITH SECTION 716.2.6.6. DOORS, WHERE LOCATED IN A CROSS-CORRIDOR CONDITION, SHALL BE AUTOMATIC-CLOSING BY ACTIVATION OF A SMOKE DETECTOR INSTALLED IN ACCORDANCE WITH SECTION 716.2.6.6. (1026.3 CBC)

## **DOOR HARDWARE KEY**

A. <u>CLOSER</u> - DOOR CLOSERS AND GATE CLOSERS SHALL BE ADJUSTED SO THAT FROM AN OPEN POSITION OF 90 DEGREES, THE TIME REQUIRED TO MOVE THE DOOR TO A POSITION OF 12 DEGREES FROM THE LATCH IS 5 SECONDS MINIMUM. MOUNTED AT MINIMUM 78" AFF.

B. <u>EXIT DEVICE</u> - ALL EXIT DOORS SHALL OPEN FROM THE INSIDE WITHOUT A KEY OR SPECIAL KNOWLEDGE.

C. <u>KICK PLATE</u> - PROVIDE A 10" SMOOTH, UNINTURRUPTED SURFACE AT BASE OF SWINGING DOORS OR GATES (AT PUSH SIDE), EXTENDING THE FULL WIDTH OF DOOR OR GATE.

D. <u>ENTRY UNIT LOCK</u> - ENTRY UNIT LOCKS SHALL BE PROVIDED WITH A COMBINATION 1/2-INCH (12.7 MM) THROW DEADLATCH WITH A MINIMUM 1-INCH (25.4 MM) THROW DEADBOLT, AND SO CONSTRUCTED THAT BOTH THE DEADLATCH AND DEADBOLT RETRACT SIMULTANEOUSLY BY KNOB OR LEVER.

E. THRESHOLD - MAXIMUM THRESHOLD HEIGHT SHALL BE 1/2". SEE DETAIL ON A9.00 FOR THRESHOLD PROFILE REQUIREMENTS

F. <u>COORDINATOR</u> - CAN BE MOUNTED AT A MINIMUM 80" AFF

G. OVERHEAD STOP - CAN BE MOUNTED AT A MINIMUM 78" AFF

H. <u>EMHO</u> - FIRE-RATED DOORS HELD IN THE OPEN POSITION BY ELECTROMAGNETIC HOLD-OPEN DEVICES SHALL BE AUTOMATIC CLOSING UPON ACTIVATION OF THE FIRE ALARM SYSTEM (PER CBC 716.5.9.3)

I. <u>CARD READER</u> - MUST COMPLY WITH SECTION 11B-308

J. <u>POWER OPERATOR W. ACTUATORS</u> - THERE SHALL BE TWO PUSH PLATES; THE CENTERLINE OF ONE PUSH PLATE SHALL BE 7 INCHES (178 MM) MINIMUM AND 8 INCHES (203 MM) MAXIMUM ABOVE THE FLOOR OR GROUND SURFACE AND THE CENTERLINE OF THE SECOND PUSH PLATE SHALL BE 30 INCHES (762 MM) MINIMUM AND 44 INCHES (1118 MM) MAXIMUM ABOVE THE FLOOR OR GROUND SURFACE. EACH PUSH PLATE SHALL BE A MINIMUM OF 4 INCHES (102 MM) DIAMETER OR A MINIMUM OF 4 INCHES BY 4 INCHES (102 MM BY 102 MM) SQUARE AND SHALL DISPLAY THE INTERNATIONAL SYMBOL OF ACCESSIBILITY COMPLYING WITH SECTION 11B-703.7.

K. <u>CLASSROOM LOCKSET</u> - SHALL BE OPERABLE WITH ONE HAND, AND SHALL NOT REQUIRE GRASPING OR TWISTING OF THE WRIST TO OPERATE

L. <u>SMOKE GASKET</u> - DOORS SHALL COMPLY WITH THE SMOKE AND DRAFT CONTROL DOOR ASSEMBLY REQUIREMENTS IN SECTION 716.2.2.1.1 WHEN TESTED IN ACCORDANCE WITH UL 1784

M. <u>PRIVACY LOCK</u> - SHALL BE OPERABLE WITH ONE HAND, AND SHALL NOT REQUIRE GRASPING OR TWISTING OF THE WRIST TO OPERATE

O. <u>WEATHERSEAL</u>

P. <u>ACOUSTIC DOOR THRESHOLD</u> - ZERO 253, PEMKO 234V, OR EQUAL.

N. <u>STOREROOM LOCK</u> - PROVIDE CBC COMPLIANT MORTISE STOREROOM LOCK, AS SPECIFIED.

Q. <u>INTEGRATED DOOR SYSTEM</u> - W/ FLUSH HARDWARE

R. <u>ALARM</u> -

S. <u>PANIC HARDWARE</u> --SWINGING DOORS SERVING A GROUP H OCCUPANCY AND SWINGING DOORS SERVING ROOMS OR SPACES WITH AN OCCUPANT LOAD OF 50 OR MORE IN A GROUP A OR E OCCUPANCY ASSEMBLY AREA NOT CLASSIFIED AS AN ASSEMBLY OCCUPANCY E, I-2 OR I-2.1 OCCUPANCIES SHALL NOT BE PROVIDED WITH A LATCH OR LOCK OTHER THAN PANIC HARDWARE OR FIRE EXIT HARDWARE. FOR GROUP L OCCUPANCIES SEE SECTION 453.6.3.

EXCEPTIONS:

1. A MAIN EXIT OF A GROUP A OCCUPANCY SHALL BE PERMITTED TO HAVE LOCKING DEVICES IN ACCORDANCE WITH SECTION 1010.1.9.4, ITEM 2. 2. DOORS PROVIDED WITH PANIC HARDWARE OR FIRE EXIT HARDWARE AND SERVING A GROUP A OR E OCCUPANCY SHALL BE PERMITTED TO BE ELECTRICALLY LOCKED IN ACCORDANCE WITH SECTION 1010.1.9.9 OR 1010.1.9.10.

North Housing, Block A

PSH PHASE 2

520 MOSLEY AVENUE

JOB NO. 19009
DRAWN Author

JOB CAPTAIN

6 | 04/28/23 | PSH 2 Resubmittal 2

06/28/23 | BID SET


Checker

Approver

DRAWING TITLE
PSH 2 - DOOR
SCHEDULE AND
DOOR TYPES

SCALE 1/4" = 1'-0"

A10.26

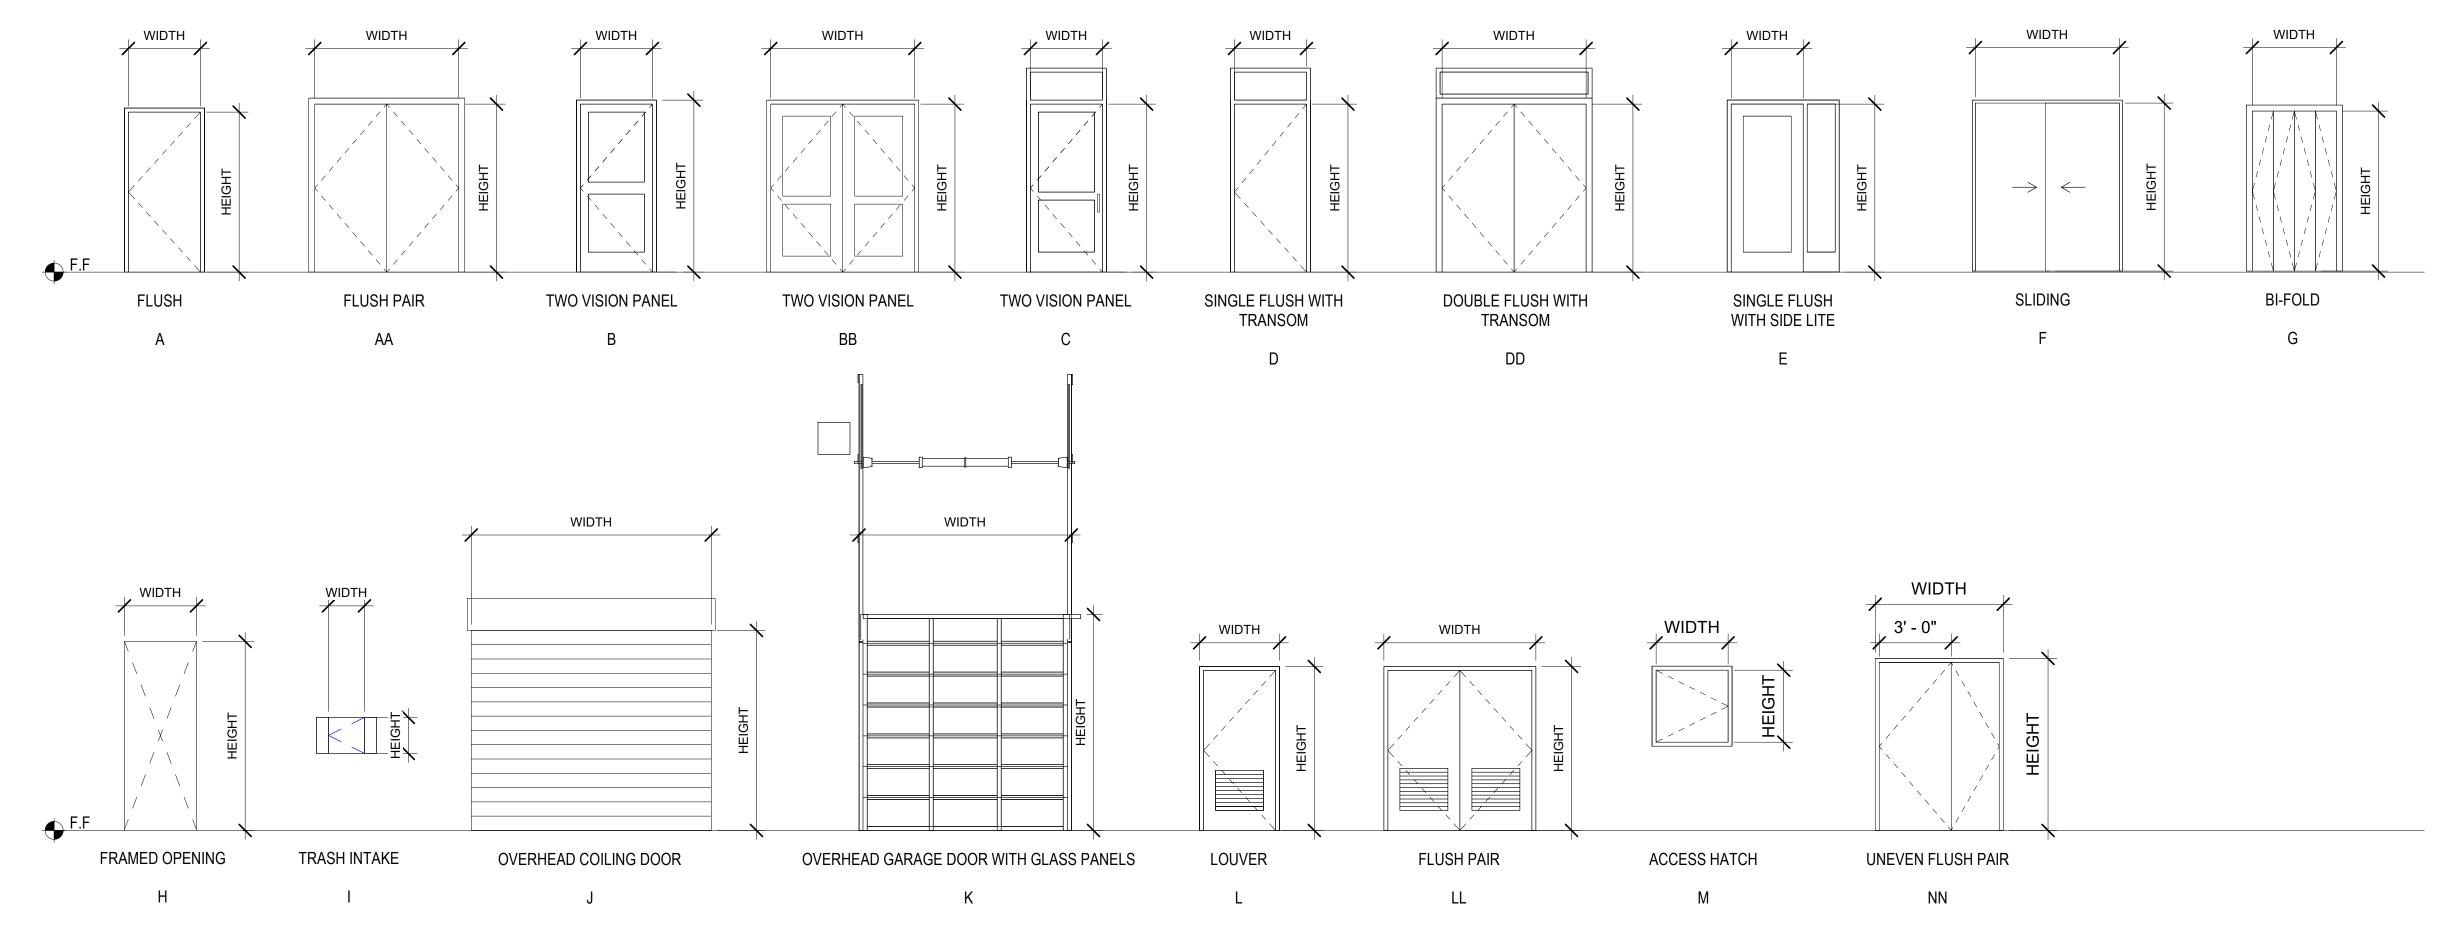

DOOR AND HARDWARE SCHEDULE - PSH 2 - ELEVATORS

DOOR AND HARDWARE SCHEDULE - PSH 2 - STAIRS

JAMB

JAMB

27/A9.50

27/A8.50

27/A9.50

27/A9.50

27/A9.50

27/A8.50

**DETAILS** 

HEAD

9/A9.50

2/A9.50

9/A9.50

16/A9.50

1/A9.50

2/A9.50

DOOR AND HARDWARE SCHEDULE - PSH 2 - UNITS

7/A9.50

7/A9.50

MATERIAL

HM

HM

MATERIAL

HM

HM

HM

HM-G PA

HM PA

HM-G PA

FINISH

FINISH

**MATERIAL** 

HM

WD

PA

HM PA

COLOR

COLOR

**FINISH** 

40

**HARDWARE** 

GROUP

COLOR

HEAD

**DETAILS** 

HEAD

26/A9.50

26/A8.50

26/A9.50

26/A9.50

26/A9.50

26/A8.50

1/A9.50

THRESHOLD

3/A9.50

6/A9.50

6/A9.50

6/A9.50

THRESHOLD

8/A9.50

8/A9.50

THRESHOLD

30/A8.50

19/A9.50

19/A9.50

19/A9.50

2/A8.50

3/A9.50

COLOR

SIGNAGE

SIGNAGE

PULL SIDE | PUSH SIDE

XSS

XSS

XSS

XS

XSS

-UNIT DOOR & FRAME PAINT COLOR NOTES:-

**HARDWARE** 

1. ALL DOORS AND FRAMES IN THE UNITS PAINT COLOR P-1

A,H,L

A,H,L

A,H,L

SID, EES, A,B,L, S

RXS-1, XSS A,B,L,R,E, S

SID, EES A.B.L

SID, EES A,B,L

SID, EES A,B,L

SIGNAGE

A,B,L,R,E

2. UNIT ENTRY DOOR AND FRAME, P-# VARIES BY FLOOR AT CORRIDOR SIDE, SEE FINISH FLOOR PLANS, P-1 INSIDE OF UNIT

GROUP PULL SIDE PUSH SIDE REMARKS / DOOR HARDWARE (SEE DOOR HARDWARE KEY)

ARS. RXS-1

GROUP | PULL SIDE | PUSH SIDE

H-1 2' - 0" Grand total: 123

TYPE MAR

Grand total: 2

B.2-3 7' - 0"

D.1-1 7' - 0"

D.2-1 7' - 0"

E.1-3 3' - 0"

\*\* FOR TYPE E-1 WINDOWS, SILL HEIGHT IS 3' - 0" ABOVE STAIR LANDINGS. SEE A7.20

3' - 0"

3' - 0" 3' - 0"

3' - 0"

1' - 4"

1' - 4"


5' - 6"

3' - 0"

	ı	PSH 2 -	LOUVER S	CHEDU	LE
TYPE MARK	WIDTH (W)	HEIGHT (H)	SILL HEIGHT (SH)	Count	COMMENTS
LV2	2' - 0"	2' - 0"	6' - 6"	1	PAINT TO MATCH ADJ. FINIS
LV6A	2' - 0"	1' - 0"	7' - 6"	47	PAINT TO MATCH ADJ. FINIS
LV6B	2' - 0"	1' - 0"	9' - 0"	4	PAINT TO MATCH ADJ. FINIS
LV9A	1' - 6"	1' - 0"	7' - 6"	46	PAINT TO MATCH ADJ. FINIS
LV10B	2' - 6"	1' - 0"	9' - 0"	4	PAINT TO MATCH ADJ. FINIS
LV-13	5' - 0"	4' - 6"	4' - 0"	1	PAINT TO MATCH ADJ. FINIS
LV-14	8' - 0"	3' - 0"	5' - 6"	1	PAINT TO MATCH ADJ. FINIS
LV-18	1' - 6"	1' - 0"	8' - 0"	1	PAINT TO MATCH ADJ. FINIS
LV-18 Grand total: 10		1' - 0"	8' - 0"	1	PAINT TO MATCH ADJ

**PSH 2 - WINDOW SCHEDULE** 

	PSH 2 - VENT CAP SCHEDULE										
RK	WIDTH (W)	HEIGHT (H)	SILL HEIGHT (SH)	Count	COMMENTS						
	0' - 8"	0' - 8"	7' - 9"	1	PAINT TO MATCH ADJ. FIN						
	0' - 9"	0' - 9"	7' - 10"	1	PAINT TO MATCH ADJ. FIN						

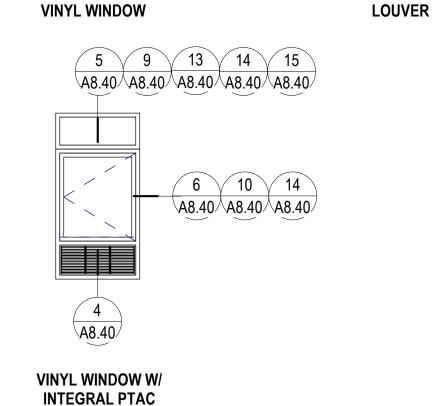

5 9 13 14 15 A8.40 A8.40 A8.40 A8.40 A8.40


6 10 14 A8.40 A8.40 A8.40

	TYPICAL	WINDOW	DETAILS
Г	1/4" = 1'-0"		

	GLAZING SCHEDULE									
	MARKINGS									
MARK	GLAZING TYPE	FIRE RATING	MAX U FACTOR	MAX SHGC	MIN VT	VISION PANEL	SIDELIGHT	WINDOW	GLAZING COMMENTS	
Α	1" CLEAR INSULATED									
В	1" CLEAR INSULATED TEMPERED									
С	SPANDREL									
D	5/16" CLEAR TEMPERED	45 MIN.				D-20	D-H-OH-45	CH-45 OR W-60	PER CBC TABLE 716.1(2)	
E	5/16" CLEAR TEMPERED	90 MIN.				D-H-T-W-90			PER CBC TABLE 716.1(2)	
F	1" SPANDREL INSULATED TEMPERED									
LS	1/4" LAMINATED SECURITY GLAZING	NR								
Т	TEMPERED GLASS									

#### **GENERAL NOTES - OPENING TYPES**

#### WINDOW NAMING

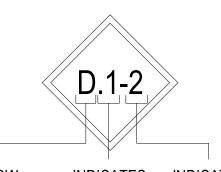

EXAMPLE:

WINDOW D-2 IS A TYPE D FIXED WINDOW WITH DIMENSIONS OF 2' - 0" x


WINDOW D.1-2 IS A TYPE D CASEMENT WINDOW WITH DIMENSIONS OF 2' - 0" x 5' - 6"


SEE WINDOW LEGEND AND WINDOW SCHEDULE FOR BALANCE OF


(INDICATED ON ELEVATIONS & PLANS


- A. ALL MULLIONS SHOWN ON VINYL WINDOW ASSEMBLIES TO BE FACTORY MULLED OR T-BAR CONNECTIONS. MUNITIN BARS ARE NOT ACCEPTABLE.
- B. NOTE: ALL WINDOWS HAVE FIBER CEMENT SURROUND AND DETAILS CAN BE FOUND ON A8.40, SEE ELEVATIONS FOR MATERIAL TYPES.
- C. REFER ALSO TO WALL SECTIONS FOR ADDITIONAL DETAIL REFERENCES
- D. PROVIDE WINDOW OPENING CONTROL DEVICES (LIMITERS) AT ALL OPERABLE PANES. OPENING CONTROL DEVICES TO COMPLY WITH ASTM F2090 AND LIMIT OPERATION TO 4" MAX.
- E. REFER TO STRUCTURAL GENERAL NOTES FOR REQUIRED WIND DESIGN, DEFLECTION AND STORY DRIFT CRITERIA.
- F. PROVIDE ACCESSIBLE LATCHES AND OPERATORS PER 1/A10.1. ACCESSIBLE HEIGHT AT ALL UNITS, ACCESSIBLE OPERATION FORCE AT ACCESSIBLE UNITS ONLY.
- G. REFER TO ELEVATIONS FOR ORIENTATION OF ASYMMETRICAL PANES (LEFT HAND / RIGHT HAND) & DIRECTION OF WINDOW OUTSWING.
- H. ALL GLAZING TO BE TYPE "A" U.O.N. REFER TO WINDOW TYPES AND GLAZING SCHEDULE.
- I. SEE ALSO ELEVATIONS FOR LOUVER TAGS (NOT ALL SHOWN IN PLAN)
- J. ALL WINDOWS ARE COLOR "WHITE"
- K. FIRE-RATED ASSEMBLIES WITH GLAZING TO BEAR A LABEL MARKED IN ACCORDANCE WITH 2016 CBC SECTION 703.6. SEE GLAZING TYPES ON A10.21.
- L. RESIDENTIAL GLAZING SHALL HAVE A MINIMUM U-VALUE OF 0.36, AN SHGC OF 0.25, AND A VT OF 0.50 STOREFRONT GLAZING SHALL HAVE A MINIMUM U-VALUE OF 0.41, AN SHGC OF 0.26, AND A VT OF 0.50 GLAZING IN DOORS SHALL HAVE A MINIMUM U-VALUE OF 0.45, AN SHGC OF 0.23, AND A VT OF 0.50
- M. PER SECTION 1714.5.1: MANUFACTURED EXTERIOR WINDOWS AND SLIDING GLASS DOORS SHALL BE LABELED AS CONFORMING WITH AAMA/ WDMA/ CSA 101/ I.S.2/ A440. THE LABEL SHALL STATE THE NEMA OF THE MANUFACTURER, THE APPROVED LABELING AGENCY, AND PRODUCT DESIGNATION. MANUFACTURED EXTERIOR SIDE-HINGED DOORS SHALL BE LABELED AS CONFORMING WITH AAMA/ WDMA/ CSA 101/ I.S.2/ A440 OR COMPLY WITH SECTION 1714.5.2
- N. PROVIDE TEMPERED GLAZING WHERE INDICATED IN ACCORDANCE WITH CBC 2406.3.
- O. EMERGENCY ESCAPE AND RESCUE OPENINGS SHALL HAVE A MINIMUM NET CLEAR OPENING OF 5.7 SQUARE FEET (0.53 m2). THE MINIMUM NET CLEAR OPENING WIDTH DIMENSION SHALL BE 20 INCHES. EMERGENCY ESCAPE AND RESCUE OPENINGS SHALL HAVE THE BOTTOM OF THE CLEAR OPENING NOT GREATER THAN 44 INCHES (1118 mm) MEASURED FROM THE FLOOR PER 2019 CBC 1030.



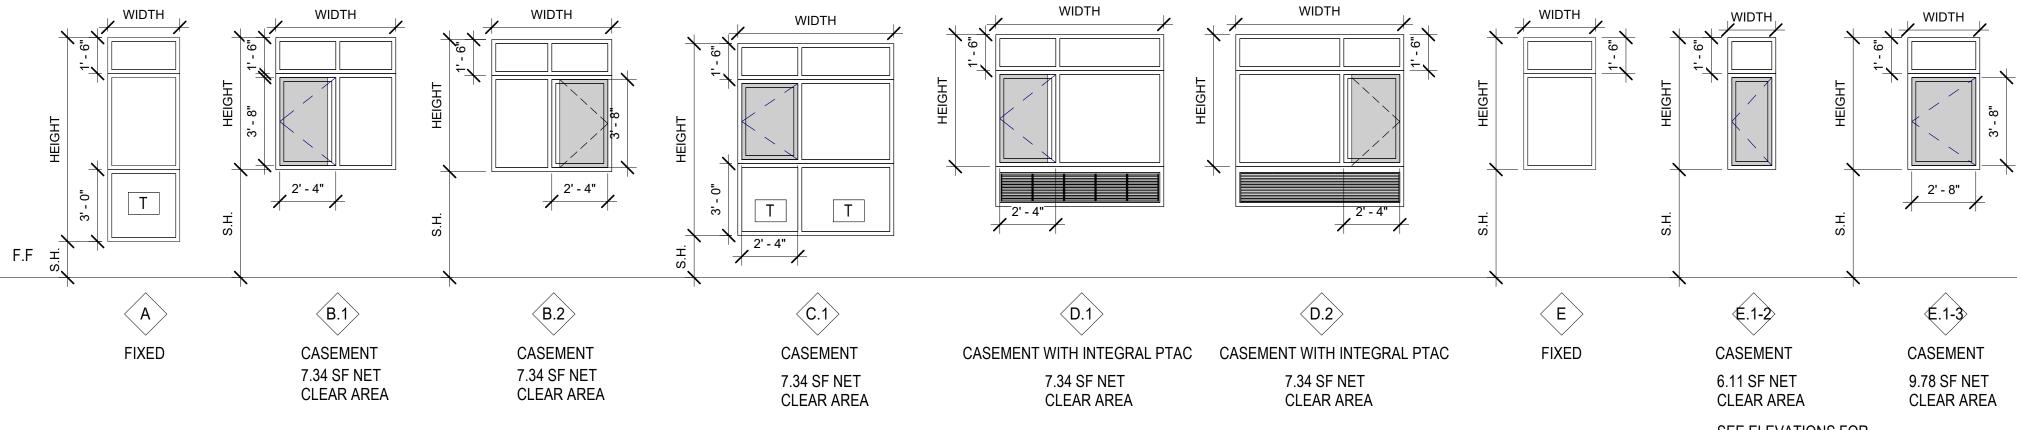


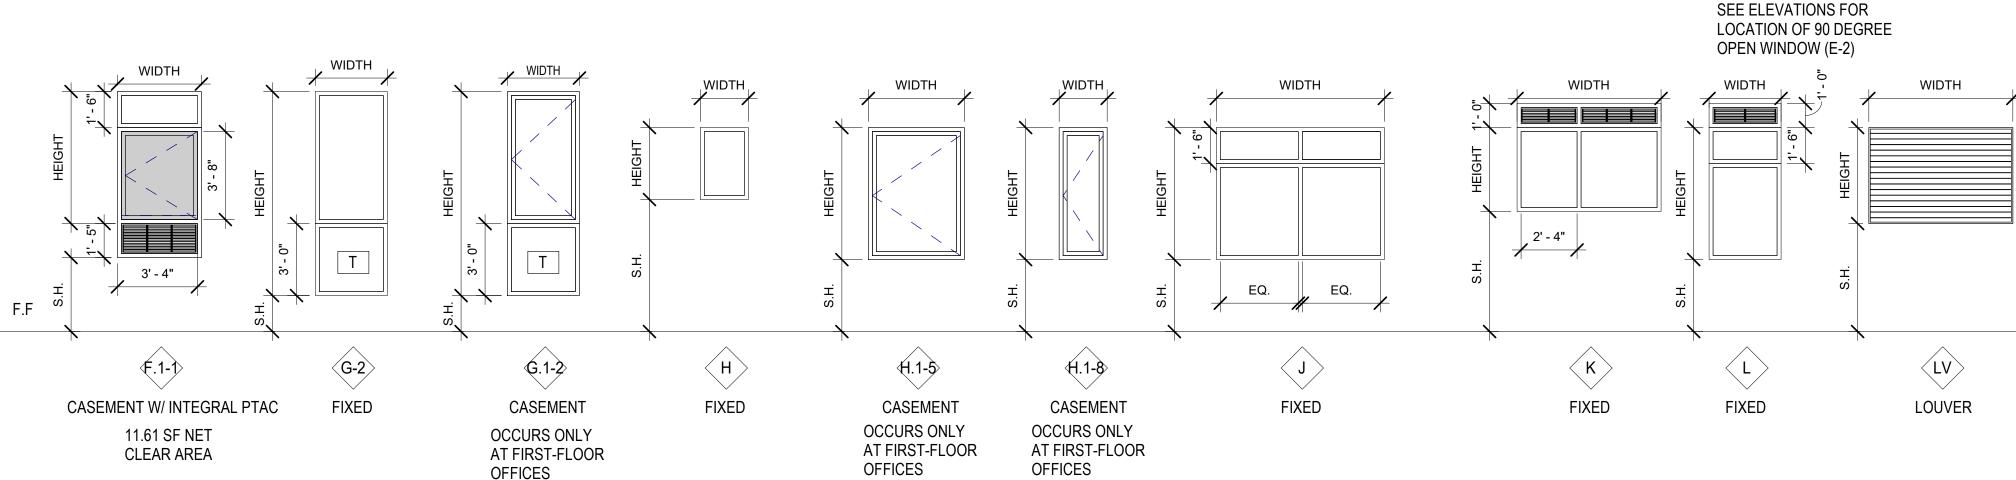


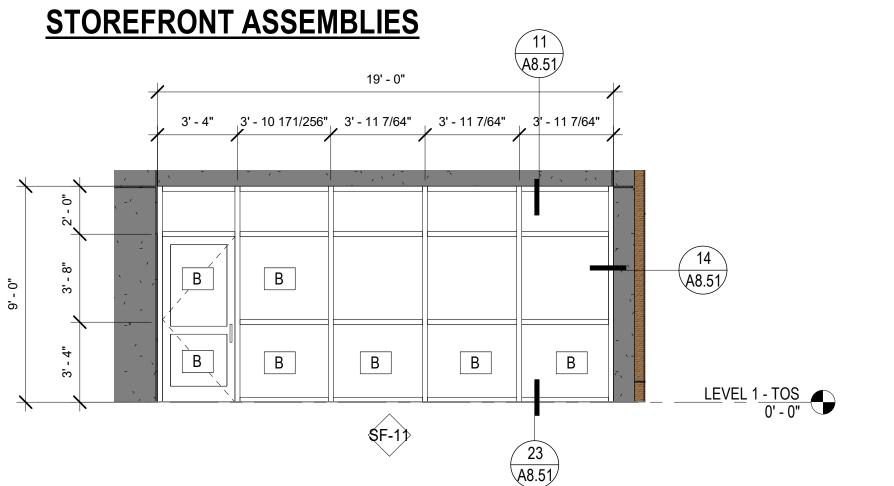

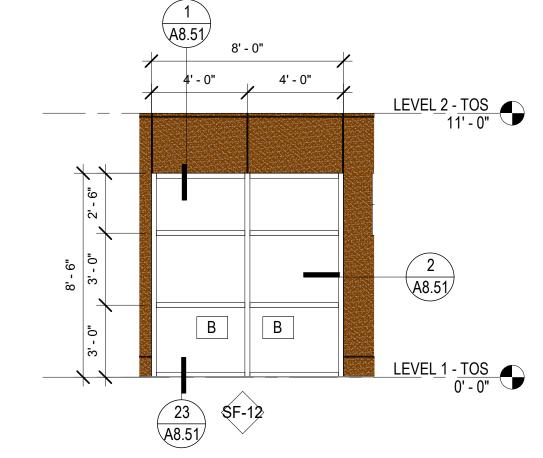




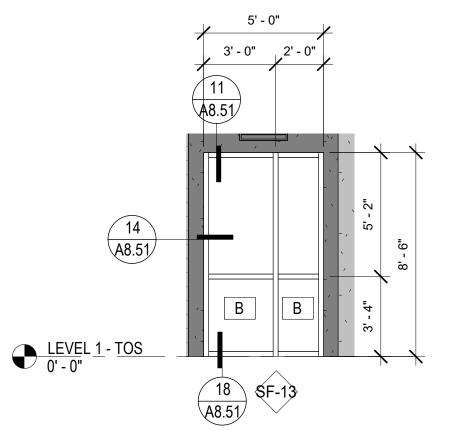

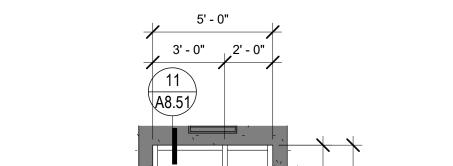


6 PSH 2 - COMMUNITY ROOM

1/4" = 1'-0"

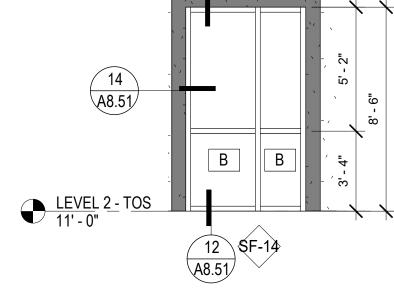



2 PSH 2 - LEVEL 1 - EAST CORRIDOR

1/4" = 1'-0"

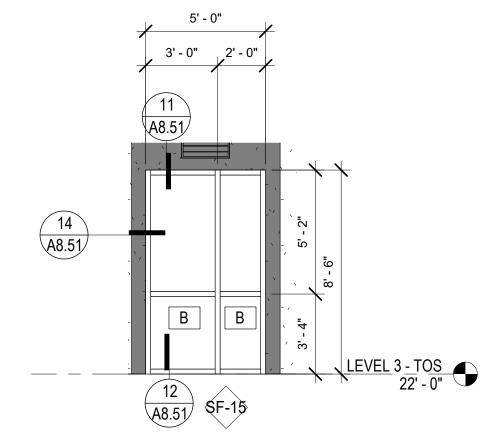

PSH 2 - LEVEL 3 - EAST CORRIDOR 1/4" = 1'-0"

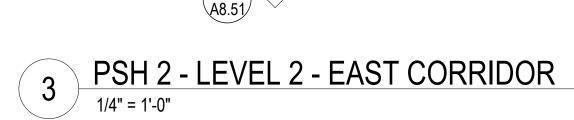

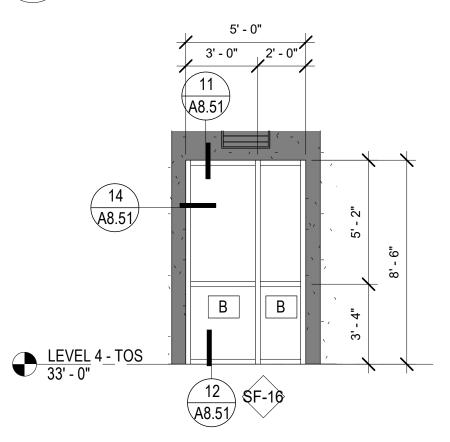

5 PSH 2 - LEVEL 4 - EAST CORRIDOR

North Housing, Block A

PAUL M

J MCELWEE

PSH PHASE 2

520 MOSLEY AVENUE ALAMEDA, CA 94501

CHECKED Checker JOB CAPTAIN

**ISSUE** DESCRIPTION 12/8/21 SD SET

03/22/22 | 100% DD SET 08/22/22 | 50% CD SET 09/29/22 PERMIT SUBMITTAL 3 | 03/01/23 | PSH 2 Resubmittal 1

06/28/23 | BID SET

DRAWING TITLE PSH 2 - WINDOW, LOUVER, & STOREFRONT SCHEDULE

SCALE 1/4" = 1'-0"

North	Housing,
Block	_

Alameda, CA 94501

JOB NO. 19009

DRAWN Author

CHECKED Checker

JOB CAPTAIN Approver

ISSUE

DATE	DESCRIPTION
12/8/21	SD SET
03/22/22	100% DD SET
08/22/22	50% CD SET
09/29/22	PERMIT SUBMITTA
03/01/23	PSH 2 Resubmittal 1
05/19/23	PSH 1&2 Resubmitta

06/28/23 BID SET

DRAWING TITLE
PSH 2 - INTERIOR
FINISH SCHEDULE

SCALE

<b>A</b> 1	0.	.28	)
COPYRIGHT © 20	16 HKIT ARC	HITECTS	

	INTERIOR FINISH SCHEDULE - PSH 2																		
ROO	FLOOR BASE WALL CEILING			CA	CABINETS			LANEOUS											
M NO. ROOM NAME	MATERIAL	FINISH	COLOR MARK	MATERIAL	FINISH	COLOR	MATERIAL	FINISH	COLOR MARK	MATERIAL	FINISH	COLOR MARK	ITEM	MATERIAL	COLOR MARK	ITEM	MATERIAL	COLOR MARK	REMARKS
1300 CORRIDOR	VINYL PLANK	-	RT-2, RT-6	WD	PA SG	WB-2, P-3	GYP BD	PA ES	P-3, P-7	GYP BD	PAES	P-4							
1310 BIKE PARKING	RESIL SHEET	_	RS-2	RUBBER	-	B-2	GYP BD	PA ES	P-4	GYP BD	PA SG	P-4							
1320 RESTROOM	POR TILE	_	FT-3	CER TILE	_	TB-1	CER TILE / GYP BD	- / PA SG	WT-3, P-4	GYP BD	PA SG	P-4							
1330 COMMUNITY ROOM	VINYL PLANK	-	RT-3	WD	PA SG	WB-2, P-4	CER TILE / GYP BD	- / PA ES	WT-1, P-4, P-10, P-11	WD / ACT/ GYP	-/-	WDC-1, AC-2/ P-4	COUNTERTOP/CASEWORK	QUARTZ SOLID SURFACE/ WD	SS-1/CAB-1				
I330 STORAGE 3	CONCRETE	SEALED	CF-1	RUBBER	-	B-2	GYP BD	PA ES	P-4	GYP BD	PA ES	P-4							
1350 ELECTRICAL	CONCRETE	SEALED	CF-1	RUBBER	-	B-2	GYP BD	PA ES	P-4	GYP BD	PA SG	P-4							
1370 MAINTENANCE	CONCRETE	SEALED	CF-1	RUBBER	-	B-2	GYP BD	PA ES	P-4	GYP BD	PA SG	P-4							
1380 MDF	CONCRETE	SEALED	CF-1	RUBBER	-	B-2	GYP BD	PA ES	P-4	GYP BD	PA SG	P-4							
1500 CORRIDOR	VINYL PLANK	-	RT-2, RT-6	WD	PA SG	WB-2, P-3	GYP BD	PA ES	P-3, P-7	GYP BD	PA ES	P-4							
1510 OFFICE	VINYL PLANK	-	RT-2	RUBBER	-	B-2	GYP BD	PA ES	P-4	ACT	-	AC-1				MANUAL ROLLER BLINDS		WS-3	
1520 BREAKOUT ROOM	VINYL PLANK	-	RT-2	RUBBER	-	B-2	GYP BD	PA ES	P-4	ACT	-	AC-1				MANUAL ROLLER BLINDS		WS-3	
1530 WORK AREA	VINYL PLANK	-	RT-2	RUBBER	-	B-2	GYP BD	PA ES	P-4	ACT	-	AC-1				MANUAL ROLLER BLINDS		WS-3	
1540 OFFICE	VINYL PLANK	-	RT-2	RUBBER	-	B-2	GYP BD	PA ES	P-4	ACT	-	AC-1				MANUAL ROLLER BLINDS		WS-3	
1550 FILE ROOM	VINYL PLANK	-	RT-2	RUBBER	-	B-2	GYP BD	PA ES	P-4	ACT	-	AC-1							
2160 BIKE PARKING	RESIL SHEET	-	RS-2	RUBBER	-	B-2	GYP BD	PA ES	P-4	GYP BD	PA SG	P-4							
2170 TRASH	RESIL SHEET	-	RS-2	RS-2	SELF COVE		GYP BD/ FRP	PA SG/	P-3, FRP-1	GYP BD	PA SG	P-4							
2180 UTILITY	RESIL SHEET	-	RS-2	RUBBER	-	B-2	GYP BD	PA ES	P-4	GYP BD	PA SG	P-4							
2200 CORRIDOR	VINYL PLANK	-	RT-2, RT-7	WD	PA SG	WB-2, P-3	GYP BD	PA ES	P-3, P-9	GYP BD	PA ES	P-4							
2300 CORRIDOR	VINYL PLANK	-	RT-2, RT-7	WD	PA SG	WB-2, P-3	GYP BD	PA ES	P-3, P-9	GYP BD	PA ES	P-4							
2310 UTILITY	RESIL SHEET	-	RS-2	RUBBER	-	B-2	GYP BD	PA ES	P-4	GYP BD	PA ES	P-4							
2320 STORAGE	RESIL SHEET	-	RS-2	RUBBER	-	B-2	GYP BD	PA ES	P-4	GYP BD	PA ES	P-4							
2330 UTILITY	RESIL SHEET	-	RS-2	RUBBER	-	B-2	GYP BD	PA ES	P-4	GYP BD	PA SG	P-4							
2340 MECHANICAL	RESIL SHEET	-	RS-2	RUBBER	-	B-2	GYP BD	PA ES	P-4	GYP BD	PA ES	P-4							
3100 CORRIDOR	VINYL PLANK	-	RT-2, RT-8	WD	PA SG	WB-2, P-3	GYP BD	PA ES	P-3, P-11	GYP BD	PA ES	P-4							
3160 BIKE PARKING	RESIL SHEET	-	RS-2	RUBBER	-	B-2	GYP BD	PA ES	P-4	GYP BD	PA SG	P-4							
3170 TRASH ROOM	RESIL SHEET	-	RS-2	RS-2	SELF COVE		GYP BD/ FRP	PA SG/	P-3, FRP-1	GYP BD	PA SG	P-4							
3180 UTILITY	RESIL SHEET	-	RS-2	RUBBER	-	B-2	GYP BD	PA ES	P-4	GYP BD	PA SG	P-4							
3200 CORRIDOR	VINYL PLANK	-	RT-2, RT-8	WD	PA SG	WB-2, P-3	GYP BD	PA ES	P-3, P-11	GYP BD	PA ES	P-4							
3300 CORRIDOR	VINYL PLANK	-	RT-2, RT-8	WD	PA SG	WB-2, P-3	GYP BD	PA ES	P-3, P-11	GYP BD	PA ES	P-4							
3310 UTILITY	RESIL SHEET	-	RS-2	RUBBER	-	B-2	GYP BD	PA ES	P-4	GYP BD	PA ES	P-4							
3320 UTILITY	RESIL SHEET	-	RS-2	RUBBER	-	B-2	GYP BD	PA ES	P-4	GYP BD	PA SG	P-4							
100 CORRIDOR	VINYL PLANK	-	RT-2, RT-6	WD	PA SG	WB-2, P-3	GYP BD	PA ES	P-3, P-7	GYP BD	PA ES	P-4							
1160 BIKE PARKING	RESIL SHEET	-	RS-2	RUBBER	-	B-2	GYP BD	PA ES	P-4	GYP BD	PA SG	P-4							
170 TRASH ROOM	RESIL SHEET	-	RS-2	RS-2	SELF COVE		GYP BD/ FRP	PA SG/	P-3, FRP-1	GYP BD	PA SG	P-4							
H180 UTILITY	RESIL SHEET	-	RS-2	RUBBER	-	B-2	GYP BD	PA ES	P-4	GYP BD	PA ES	P-4							
4200 CORRIDOR	VINYL PLANK	-	RT-2, RT-6	WD	PA SG	WB-2, P-3	GYP BD	PA ES	P-3, P-7	GYP BD	PA ES	P-4							
4300 CORRIDOR	VINYL PLANK	-	RT-2, RT-6	WD	PA SG	WB-2, P-3	GYP BD	PA ES	P-3, P-7	GYP BD	PA ES	P-4							
4310 UTILITY	RESIL SHEET	-	RS-2	RUBBER	-	B-2	GYP BD	PA ES	P-4	GYP BD	PA ES	P-4							
4320 UTILITY	RESIL SHEET	-	RS-2	RUBBER	-	B-2	GYP BD	PA ES	P-4	GYP BD	PA ES	P-4							

									INTERIO	R FINISH S	CHEDUL	E - PSH 2 EL	EVATOR						
ROO	FLOOR		BASE		WALL			CEILING		CABINETS			MISCELLANEOUS						
M			COLOR												COLOR			COLOR	
NO. ROOM NAME	MATERIAL	FINISH	MARK	MATERIAL	FINISH	COLOR	MATERIAL	FINISH	COLOR MARK	MATERIAL	FINISH	COLOR MARK	ITEM	MATERIAL	MARK	ITEM	MATERIAL	MARK	REMARKS
E1-2 ELEVATOR 1	VINYL PLANK	-	RT-2				PLASTIC LAMINATE	-	EL-1										
E1-3 ELEVATOR 1																			
1-4 ELEVATOR 1																			
2-1 ELEVATOR 2	VINYL PLANK	-	RT-2				PLASTIC LAMINATE	-	EL-1										
2-2 ELEVATOR 2																			
2-3 ELEVATOR 2																			
2-4 ELEVATOR 2																			

									INTERIO	OR FINISH	SCHED	ULE - PSH 2 S	TAIRS						
00		FLOOR		BASE			WALL			CEILING				CABINETS			CELLANEOUS		
M NO. ROOM NAME	MATERIAL	FINISH	COLOR MARK	MATERIAL	FINISH	COLOR	MATERIAL	FINISH	COLOR MARK	MATERIAL	FINISH	COLOR MARK	ITEM	MATERIAL	COLOR MARK	ITEM	MATERIAL	COLOR MARK	REMARKS
-2 STAIR 1	RESIL SHEET	-	RB-1	RUBBER	-	B-3	GYP BD	PA ES	P-4	GYP BD	PA ES	P-4				STAIR RAILINGS & HANDRAIL	PA SG	P-2	
-3 STAIR 1	RESIL SHEET		RB-1	RUBBER	-	B-3	GYP BD	PA ES	P-4	GYP BD	PA ES	P-4				STAIR RAILINGS & HANDRAIL	PA SG	P-2	
-4 STAIR 1	RESIL SHEET		RB-1	RUBBER	-	B-3	GYP BD	PA ES	P-4	GYP BD	PA ES	P-4				STAIR RAILINGS & HANDRAIL	PA SG	P-2	
2-2 STAIR 2	RESIL SHEET		RB-1	RUBBER	-	B-3	GYP BD	PA ES	P-4	GYP BD	PA ES	P-4				STAIR RAILINGS & HANDRAIL	PA SG	P-2	
2-3 STAIR 2	RESIL SHEET		RB-1	RUBBER	-	B-3	GYP BD	PA ES	P-4	GYP BD	PA ES	P-4				STAIR RAILINGS & HANDRAIL	PA SG	P-2	
2-4 STAIR 2	RESIL SHEET		RB-1	RUBBER	-	B-3	GYP BD	PA ES	P-4	GYP BD	PA ES	P-4				STAIR RAILINGS & HANDRAIL	PA SG	P-2	
3-1 STAIR 3	RESIL SHEET		RB-1	RUBBER	-	B-3	GYP BD	PA ES	P-4	GYP BD	PA ES	P-4				STAIR RAILINGS & HANDRAIL	PA SG	P-2	
3-2 STAIR 3	RESIL SHEET		RB-1	RUBBER	-	B-3	GYP BD	PA ES	P-4	GYP BD	PA ES	P-4				STAIR RAILINGS & HANDRAIL	PA SG	P-2	
3-3 STAIR 3	RESIL SHEET		RB-1	RUBBER	-	B-3	GYP BD	PA ES	P-4	GYP BD	PA ES	P-4				STAIR RAILINGS & HANDRAIL	PA SG	P-2	
3-4 STAIR 3	RESIL SHEET		RB-1	RUBBER	-	B-3	GYP BD	PA ES	P-4	GYP BD	PA ES	P-4				STAIR RAILINGS & HANDRAIL	PA SG	P-2	
3-R STAIR 3	RESIL SHEET		RB-1	RUBBER	-	B-3	GYP BD	PA ES	P-4	GYP BD	PA ES	P-4				STAIR RAILINGS & HANDRAIL	PA SG	P-2	

No									INT	<b>ERIOR FINIS</b>	H SCHEDL	ILE - UN	IT							
∮		FLOOR BASE						WALL			CEILING			C	CABINETS			MISCELLANEOUS		
009.⊿	ROOM NAME	MATERIAL	FINISH	COLOR MARK	MATERIAL	FINISH	COLOR	MATERIAL	FINISH	COLOR MARK	MATERIAL	FINISH	COLOR MARK	ITEM	MATERIAL	COLOR MARK	ITEM	MATERIAL	COLOR MARK	REMARKS
es\15	UNIT KITCHEN	VINYL PLANK		RT-1	RUBBER	-	B-1	GYP BD	PA SG	P-1	GYP BD	PA SG	P-1	COUNTERTOP/CASEWORK	QUARTZ SOLID SURFACE/ WD	SS-1/CAB-1				
드니	UNIT LIVING ROOM	VINYL PLANK		RT-1	WD	PA SG	WB-1, P-1	GYP BD	PA ES	P-1	GYP BD	PA ES	P-1				VERTICAL PVC BLINDS		WS-1	
Local	UNIT BATHROOM	RESIL SHEET	-/-	RS-1	RUBBER	-	B-1	GYP BD	PA SG	P-1	GYP BD	PA SG	P-1	COUNTERTOP/CASEWORK	CULTURED MARBLE, WD	/ SS-3/CAB-1				
Sevit_	UNIT BEDROOM	VINYL PLANK		RT-1	WD	PA SG	WB-1, P-1	GYP BD	PA ES	P-1	GYP BD	PA ES	P-1							

FINISH TAG 03 CONCR	DESCRIPTION	MANUFACTURER	PRODUCT NAME	COLOR NAME / NO.	SIZE	INSTALLATION	GREEN POINT RATING	NOTES
06 WOOD,	SEALED CONCRETE PLASTICS, AND COMPOSITES NTERIOR FINISHED CARPENTS	SEE SPECS					L2 Low Emitting; L3 Durable flooring	
PLAM-1 VB-1	PLASTIC LAMINATE FINGER JOINTED PINE WOOD BASE	WILSONART	STANDARD HPL  1 EASED EDGE CRAFTSMAN BASE	BRITTANY BLUE D321 PR387FJ-3	3 1/2" H X 7/16" T		K4.2 - yes, fingerjointed; K5.3 No added Formaldehyde	
	FINGER JOINTED PINE WOOD BASE	EL & EL WOOD PRODUCTS	CORONADO / #620 BASE PINE PRIMED	PR314FJ-4	4 1/4" H X 9/16" T		K4.2 - yes, fingerjointed; K5.3 No added Formaldehyde	
09 30 00 - <sup>-</sup> FT-1	PORCELAIN FLOOR TILE @	DALTILE	BEEHIVE	TAUPE	HEXAGON 20" X 24"X 3/8"		L2 Low Emitting; L3 Durable flooring	
-T-2	LOBBY PSH1 PORCELAIN FLOOR TILE @	ATLAS CONCORDE	PATH	SILVER PEARL	30CM X 60CM X 9MM		L2 Low Emitting; L3 Durable flooring	
	SEN LOBBY PORCELAIN FLOOR TILE @	DALTILE	ARTICULO	COLUMN GREY AR09	12" X 24"X 5/16"		L2 Low Emitting; L3 Durable flooring	
TB-1	RR CERAMIC WALL TILE BASE @	DALTILE	COLOR WHEEL CLASSIC	WHITE 0100	3" X 6"			
	RR CERAMIC WALL TILE @ PSH2	DALTILE	COVE BASE COLOR WHEEL RETRO,	WATERFALL 0169	2 X 3 X 1/4" (12" X 13"			
WT-2	COMM. RM. CERAMIC WALL TILE, @ SEN.	DALTILE	CUBE MOSAIC COLRO WHEEL CLASSIC	SPA 0148	SHEET) 2 X 3 X 1/4 (10 1/2" X 13"			
WT-3	COMM. RM. CERAMIC WALL TILE & BULLNOSE TRIM @ RR	DALTILE	CHEVRON MOSAIC COLOR WHEEL CLASSIC	WHITE 0100	SHEET) 3" X 6"			
09 51 00 - <i>1</i> AC-1	ACOUSTIC PANEL CEILINGS ACOUSTIC PANEL CEILING	ARMSTRONG	ULTIMA 1912	BEVELED TEGULAR	24" X 24" X 3/4"	9/16" SUPRAFINE		NRC .75, CAC .35, LIGH
AC-2	ACOUSTIC PANEL CEILING	ARMSTRONG	OPTIMA	WHITE	48" X 48"X 7/8"	SUSPENSION 9/16" SUPRAFINE		REF. 0.88 SQUAR TEGULAR; NRO
	NEAR WOOD CEILINGS					SUSPENSION		.95
WDC-1	LINEAR WOOD CEILING	9WOOD	2100 SERIES PANELIZED LINEAR	WESTERN HEMLOCK, OAK STAIN	3/4" THICK X 5 1/4" SQUARE EDGE	INSTALL WITH ACOUSTIC BACKING, DIRECT ATTACH TO 15/16" HEAVY DUTY T BAR MAIN RUNNERS		FAST>TRACK, PEFC CERTIFIED
WDP-1	WOOD WALL PLANKS	9WOOD	2600 SERIES TONGUE AND GROOVE	WESTERN HEMLOCK, OAK STAIN	3/4" THICK X 5 1/4" TONGUE AND GROOVE			FAST>TRACK, PEFC CERTIFIED
	RESILIENT FLOORING RESILIENT SHEET	TARKETT JOHNSONITE	ACCZENT	83016 TISSE WARM BEIGE	SHEET	GLUE-DOWN. AD ALT FOR SELF COVING BASE	L2 Low Emitting; L3 Durable flooring	OLIVIII ILD
RS-2	RESILIENT SHEET	TARKETT JOHNSONITE	ACCZENT	82022 ZEN GRAY	SHEET	DETAIL. GLUE-DOWN, SELF COVE	L2 Low Emitting; L3 Durable flooring	
RT-1	LVT @ UNITS	INTERFACE	LEVEL SET TEXTURED	A00415 ANTIQUE OAK	25CM X 1M	AT TRASH GLUE DOWN, ASHLAR	L2 Low Emitting; L3 Durable flooring	22 MIL WEAR LAYER,
RT-2	LVT @ OFFICES &	INTERFACE	WOODGRAINS LEVEL SET TEXTURED	A00416 ANTIQUE DARK	25CM X 1M	GLUE-DOWN, ASHLAR	L2 Low Emitting; L3 Durable flooring	ACOUSTIC 22 MIL WEAR LAYER,
RT-3	CORRIDORS  LVT @ COMMUNITY ROOMS	INTERFACE	WOODGRAINS LEVEL SET TEXTURED	OAK A00427 HEMLOCK	25CM X 1M	GLUE DOW,	L2 Low Emitting; L3 Durable flooring	ACOUSTIC  22 MIL WEAR LAYER,
RT-6	LVT @ 1ST & 4TH FLR	INTERFACE	WOODGRAINS NATIVE FABRIC	A00804 STRAW	50CM X 50CM	HERRINGBONE GLUE-DOWN	L2 Low Emitting; L3 Durable flooring	ACOUSTIC
RT-7	CORRIDOR ACCENT LVT @ 2ND FLR. CORRIDOR	INTERFACE	NATIVE FABRIC	FLAX	50CM X 50CM	GLUE DOWN LVT	L2 Low Emitting; L3 Durable flooring	
RT-8	ACCENT LVT @ 3RD FLOOR	INTERFACE	NATIVE FABRIC	A00807 BLUEGRASS	50CM X 50CM	GLUE-DOWN	L2 Low Emitting; L3 Durable flooring	
	CORRIDOR ACCENT RESILIIENT BASE & STAIR ACCE	ESSORIES						
3-2	RESILIENT BASE @ UNIT  RESILIENT BASE @ COMM.  KITCH/OFFICES/LAUNDRY/UTI	ROPPE	PINNACLE RUBBER BASE STANDARD TOE PINNACLE RUBBER BASE STANDARD TOE	191 CAMEL  114 LUNAR DUST	4"			
B-3	RESILIENT BASE @ STAIRS	ROPPE	PINNACLE RUBBER BASE	665 HORIZON	4"			
RB-1	RUBBER STAIR & TREADS	ROPPE	RUBBER TREAD WITH INTEGRATED RISER #99 HAMMERED DESIGN, CONTRASTING STRIPE FOR THE VISUALLY IMPAIRED AS DETAILED	665 HORIZON				
	RESINOUS FLOOR EPOXY	KRETUS	COLOR QUARTZ SYSTEM	SALT & PEPPER				
09 68 00 C	ARPETING							
	WALK-OFF CARPET	INTERFACE	STEP REPEAT	ONYX	24" X 24"		K5.2 CARB definition of No added formaldehyde	
FRP-1	FIBERGLASS REINFORCED PAN FRP OUND-ABSORPING WALL PANE	CRANE	GLASBORD	SMOOTH WHITE 85				
	ACOUSTIC WALL PANEL NTERIOR PAINTING	AUTEX	GROOVE	SENADO	48" X 96"			
P-1	UNITS COMMON AREA DOORS &	SHERWIN WILLIAMS (SW) SHERWIN WILLIAMS (SW)		SW7102 WHITE FLOUR SW76325 PALISADE			K2.1 Low-VOC paints and coatings 5g/L K2.1 Low-VOC paints and coatings 5g/L	
	FRAMES  CORRIDOR WALLS BODY	SHERWIN WILLIAMS (SW)		SW9109 NATURAL LINEN			K2.1 Low-VOC paints and coatings 5g/L	
P-4	CORRIDOR CEILING, OFFICE WALLS	SHERWIN WILLIAMS (SW)		SW 7009 PEARLY WHITE			K2.1 Low-VOC paints and coatings 5g/L	
P-6	ACCENT PAINT  1ST & 4TH UNIT ENTRY,  STAIR, ELEVATOR DOOR & FRAME/ MISC.	SHERWIN WILLIAMS (SW) SHERWIN WILLIAMS (SW)		SW 6488 GRAND CANAL SW6361 AUTUMNAL			K2.1 Low-VOC paints and coatings 5g/L K2.1 Low-VOC paints and coatings 5g/L	
P-7	1ST & 4TH CORRIDOR ACCENT & MISC.	SHERWIN WILLIAMS (SW)		SW9012 POLVO DE ORO			K2.1 Low-VOC paints and coatings 5g/L	
P-8	2ND FLOOR UNIT ENTRY, STAIR, ELEVATOR DOOR & FRAME/ MISC.	SHERWIN WILLIAMS (SW)		SW6194 BASIL			K2.1 Low-VOC paints and coatings 5g/L	
	2ND FLR. CORRIDOR ACCENT & MISC.	SHERWIN WILLIAMS (SW)		SW9129 JADE DRAGON			K2.1 Low-VOC paints and coatings 5g/L	
	= = +		+	SW9059 SILKEN PEACOCK			K2.1 Low-VOC paints and coatings 5g/L	
P-10	3RD FLOOR UNIT ENTRY, STAIR, ELEVATOR DOOR & FRAME/ MISC.	SHERWIN WILLIAMS (SW)		SW9039 SILKLIN F LACOUR				

INTERIOR FINISH LEGEND

FINISH	DECODIDATION	MANUEACTURER		COLOD MARKE (NO	0175	INIOTALLATION	ODEEN DOINT DATING	NOTEO
TAG ACCES	DESCRIPTION SSORIES	MANUFACTURER	PRODUCT NAME	COLOR NAME / NO.	SIZE	INSTALLATION	GREEN POINT RATING	NOTES
26 00 0	CORNER GUARDS	1	1	1				1
G-1	CORNER GUARDS	INPRO	CLEAR CORNER GUARDS	TBD	1 1/8" X 1 1/8" X 48"	AT CORRIDOR EXPOSED CORNERS		
) SPECI	ALTIES	<u> </u>				O O I II I I I I I I I I I I I I I I I		
	DISPLAY CASES AND MARKER I	T	CONTEMPODADY CEDICS	LUNCED DOOD 2044	3'X 4'			T
C-1	LOCKING DISPLAY CASE BULLETIN BOARD	CLARIDGE	CONTEMPORARY SERIES	HINGED DOOR 2041	3 X 4		-	
OC-2	WHITE BOARD	CLARIDGE	TRIMLINE PLUS (TL2048-75)	WRITING SURFACE: LCS3 PORCELAIN TRIM: SATIN ANODIZED	48" X 72"		-	
0 14 00 - SN-1	SIGNAGE  BACK PAINTED ACRYLIC SIGNAGE	BEST SIGN SYSTEMS	LUCENT	BACKPAINT COLOR: RAINWASHED SW6211			-	
	TOILET BATH AND JANITORIAL		T=. =					ı
8A-1A 8A-1B	ROBE HOOKS @ UNITS GRAB BAR @ UNITS	GATCO MOEN	BLEU - MINIMALIST 34715 1 1/4" GRAB BAR-	POLISHED CHROME WHITE	24", 36", 42" SEE	48" A.F.F.	-	
			CONCEALED SCREW 8700		DRAWINGS			
BA-1C	TOWEL BAR @ UNITS	GATCO	BLEU - MINIMALIST 34715	STAINLESS STEEL POLISHED CHROME	24"	34" AND 64" A.F.F.	-	
A-1D	TOILET PAPER DISPENSER @ UNITS		01-201S	POLISHED CHROME		2011 4 5 5	-	
BA-1E	SHOWER CURTAIN ROD @ UNITS	GATCO	MODERN MINIMALIST CURVED SHOWER ROD SET	STAINLESS STEEL POLISHED CHROME	ADJUSTABLE ROD 72"	80" A.F.F.	-	
8A-1F 8A-1G	SHOWER CURTAIN HOOKS  MEDECINE CABINET	MOEN JENSEN	SHOWER CURTAIN ROLLER RINGS SR2100 STYLELINE B772193	CHROME POLISHED STAINLESS	12 PACK EA. SHOWER  16 1/8" X 26 1/8" X 3 7/8"		-	
A-10	INIEDECINE CABINET	JEINOEIN	STILELINE B//2193	STEEL & WHITE	10 1/0 Λ 20 1/0 Λ 3 //δ"			
3A-2	RECESSED-MOUNTED TOILET TISSUE, SEAT-COVER DISPENSER AND WASTE DISPOSAL	BOBRICK	CLASSIC SERIES RECESSED-MOUNTED TOILET TISSUE, SEATCOVER DISPENSER AND WASTE DISPOSAL (B-3091)	SATIN-FINISH STAINLESS STEEL	-	-	-	-
3A-3	RECESSED PAPER TOWEL DISPENSER AND WASTE RECEPTACLE	BOBRICK	RECESSED CONVERTIBLE PAPER TOWEL DISPENSER / WASTE RECEPTACLE (B-3944)				-	
3A-4	HAT AND COAT HOOK	BOBRICK	HAT AND COAT HOOK	SATIN-FINISH STAINLESS			-	
BA-7	SURFACE MOUNTED SOAP DISPENSER	BOBRICK	(B-6827) SURFACE MOUNTED SOAP DISPENSER (B-4112)	STEEL SATIN-FINISH STAINLESS STEEL			-	
8A-8	GRAB BARS	BOBRICK	STRAIGHT GRAB BAR	SATIN-FINISH STAINLESS			-	
3A-9	MIRROR	BOBRICK	(B-5806) WELDED FRAME MIRROR (B-290)	STEEL SATIN-FINISH STAINLESS STEEL	24" X 48"		-	
	POSTAL SPECIALTIES	EL ODENOE	40 DECECCED MOUNT	ANODIZED ALLIMINIUM				1
/IL-1	USPS MAILBOX	FLORENCE	4C RECESSED MOUNT 4CADD-10	ANODIZED ALUMINUM			-	
	USPS MAILBOX	FLORENCE	4C RECESSED MOUNT 4CADS-04				-	
ИL-3 ИL-4	PARCEL LOCKER PARCEL LOCKER	LUXER ONE LUXER ONE	MAIN UNIT ADD-ON	TBD TBD			-	
лс- <del>ч</del> ЛL-5	THROUGH THE WALL RENT DROP BOX	DURABOX	D700 ADJUSTABLE THROUGH-WALL DROP BOX	GREY			-	
12 FURNI								
12 21 16 - NS-1	VERTICAL LOUVER BLINDS VERTICAL PVC BLINDS	GRABER	G-85, DURA-VUE ONE	WHITE	3 1/2" PVC VANES			CONTROLS 42" AFF
			TOUCH WAND CONTROL		5 1 70 V/ UVLO			555E0 12 FN 1
VS-3	MANUAL ROLLER WINDOW SHAI MANUAL ROLLER BLINDS	DRAPER	CLUTCH OPERATED FLEXHADE NEXD	PHIFFER SHEERWEAVE SERIES SW2701				CONTROLS 42" AFF
12 32 13 - CAB-1	WOOD VENEER FACED CASEW HDWD VENEER PLYWOOD CASEWORK	GRANDVIEW CABINETS	MAPLE	SLATE	23"D		K5.2 CARB definition of No added formaldehyde	
1W-1	CABINET PULLS	AMEROCK	BAR PULL	STERLING NICKEL	3 3/4" CENTER TO CENTER		-	
W-2	CABINET PULLS	AMEROCK	BAR PULL	STERLING NICKEL	5 1/16" CENTER TO CENTER		-	
2 36 61 - S-1	QUARTZ AGGLOMERATE COUN SOLID SURFACE- UNITS,	ITERTOPS CAESERSTONE	QUARTZ BLDR LINE	7601 ROCK SALT	2 CM		K5.2 CARB definition of No added	
S-2	COMMUNITY RM, & STAFF KITCHENS SOLID SURFACE- LOBBY	CAESERSTONE	QUARTZ	5000P LONDON FOG,	2 CM		formaldehyde  K5.2 CARB definition of No added	
S-3	SOLID SURFACE	CULTURED MARBLE		POLISHED TBD			formaldehyde K5.2 CARB definition of No added	
12 48 13 - VM-1	RECESSED ENTRY MAT RECESSED WALK OFF MAT	BALCO INC.	FG 1 1/2A	TBD		RECESSED	K1.2, 1 point Building Entryway Health	6'-0" IN DIRECTION OF
	EYING EQUIPMENT MACHINE ROOM-LESS ELECTRIC PLASTIC LAMINATE WALL FINISH IN ELEV.	C TRACTION PASSENGER ELEV	/ATORS TBD				Point, 6'-0" long permanent walk off mat at every main entrance	IKAVEL

HKIT ARCHITECTS
38 NINTH STREET SUITE 240 • OAKLAND, CA 94607



North Housing, Block A

Alameda, CA 94501

JOB NO. 19009 DRAWN Author

CHECKED Checker

JOB CAPTAIN Approver

06/28/23 BID SET

DRAWING TITLE
PSH 2 - INTERIOR
FINISH LEGEND

SCALE


A10.29

# **GENERAL NOTES - SIGNAGE PLAN**

- 1. ALL SIGNS SHALL BE SENT TO THE LIGHT HOUSE OF THE BLIND FOR REVIEW AND APPROVAL PRIOR TO FABRICATION.
- 2. SIGNS CONTAINING TACTILE CHARACTERS SHALL BE LOCATED SO THAT A CLEAR FLOOR SPACE OF 18"X18" MIN. CENTERED ON THE TACTILE CHARACTERS AT THE LATCH SIDE OF THE DOOR IS PROVIDED.
- 3. SEE ALSO SIGNAGE PLANS, DOOR SCHEDULES, SITE PLAN, FLOOR PLANS, ACCESSIBILITY DETAILS AND FINISH SCHEDULES FOR SIGNAGE INFORMATION.
- 4. ALL SIGNS TO BE 0.25" NON-GLARE ACRYLIC WITH SUB-SURFACE PAINT AND STANDARD EDGES, U.O.N. NO APPLIED CHARACTERS WILL BE ACCEPTED. FONT AND COLOR SELECTION BY ARCHITECT FROM MIDPEN SIGNAGE STANDARDS OPTIONS.
- 5. FOR TYPICAL MOUNTING SEE SHEET A9.91

## SIGNAGE SCHEDULE

CODE	TYPE	DETAIL	TACTILE	REMARKS
<u>ALD</u>	ASISTIVE LISTENING DEVICE	30 / A9.91	NO	
ARS (-L,-R, -N)	ACCESSIBLE ROUTE SIGN	14 / A9.91	NO	COORDINATE IN FIELD
<u>APS</u>	ACCESSIBLE PARKING SIGN	23 / A9.91	NO	SEE CIVIL DWGS
<u>CBI</u>	CALL BOX INSTRUCTION	15 / A9.91	YES	
<u>CGG</u>	CEILING CLEARANCE GUARD	4 / A9.91	NO	
<u>EES</u>	EMERGENCY EVACUATION SIGN	21 / A9.91	NO	
<u>ELS</u>	ELEVATOR LEVEL DESIGNATION SIGN	11 / A9.91	NO	
<u>ISA</u>	INT'L SYMBOL OF ACCESSIBILITY	27 / A9.91	YES	
<u>ICF</u>	IN CASE OF FIRE SIGN	16 / A9.91	YES	
<u>IDS</u>	INTERIOR DIRECTIONAL SIGN	21 /A9.91	NO	
<u>MOS</u>	MAXIMUM OCCUPANCY SIGN	20 / A9.91	NO	REVIEW BY FIRE DEPT
<u>NSS</u>	NO SMOKING SIGN	22 / A9.91	NO	CONFIRM W/LOCAL JURISDICTIC
<u>PLZ</u>	PASSENGER LOADING ZONE SIGN	26 / A9.91	NO	
RDS - 1 (2,3)	RESTROOM DOOR SIGN	8 / A9.91	NO	
<u>RIS</u>	ROOM IDENTIFICATION SIGN	13 / A9.91	YES	
RWS - 1 (2,3)	RESTROOM WALL SIGN	5 / A9.91	YES	
RXS - 1 (2-4)	TACTILE ROOM EXIT SIGN	12 / A9.91	YES	
<u>SID</u>	STAIR IDENTIFICATION SIGN	1 / A9.91	YES	
<u>TWS</u>	TWO WAY COMMUNICATION SIGN	10 / A9.91	NO	
<u>UIS</u>	UNIT IDENTIFICATION SIGN	2 / A9.91	NO	
<u>UVS</u>	UNAUTHORIZED VEHICLE	18 / A9.91	NO	SEE CIVIL DWGS
<u>XSS</u>	STAIRWELL LANDING SIGN	17 / A9.91	YES	
<u>EAR</u>	EXTERIOR AREA FOR ASSISTED RESCUE SIGN	1 / A9.92	YES	
	1			1

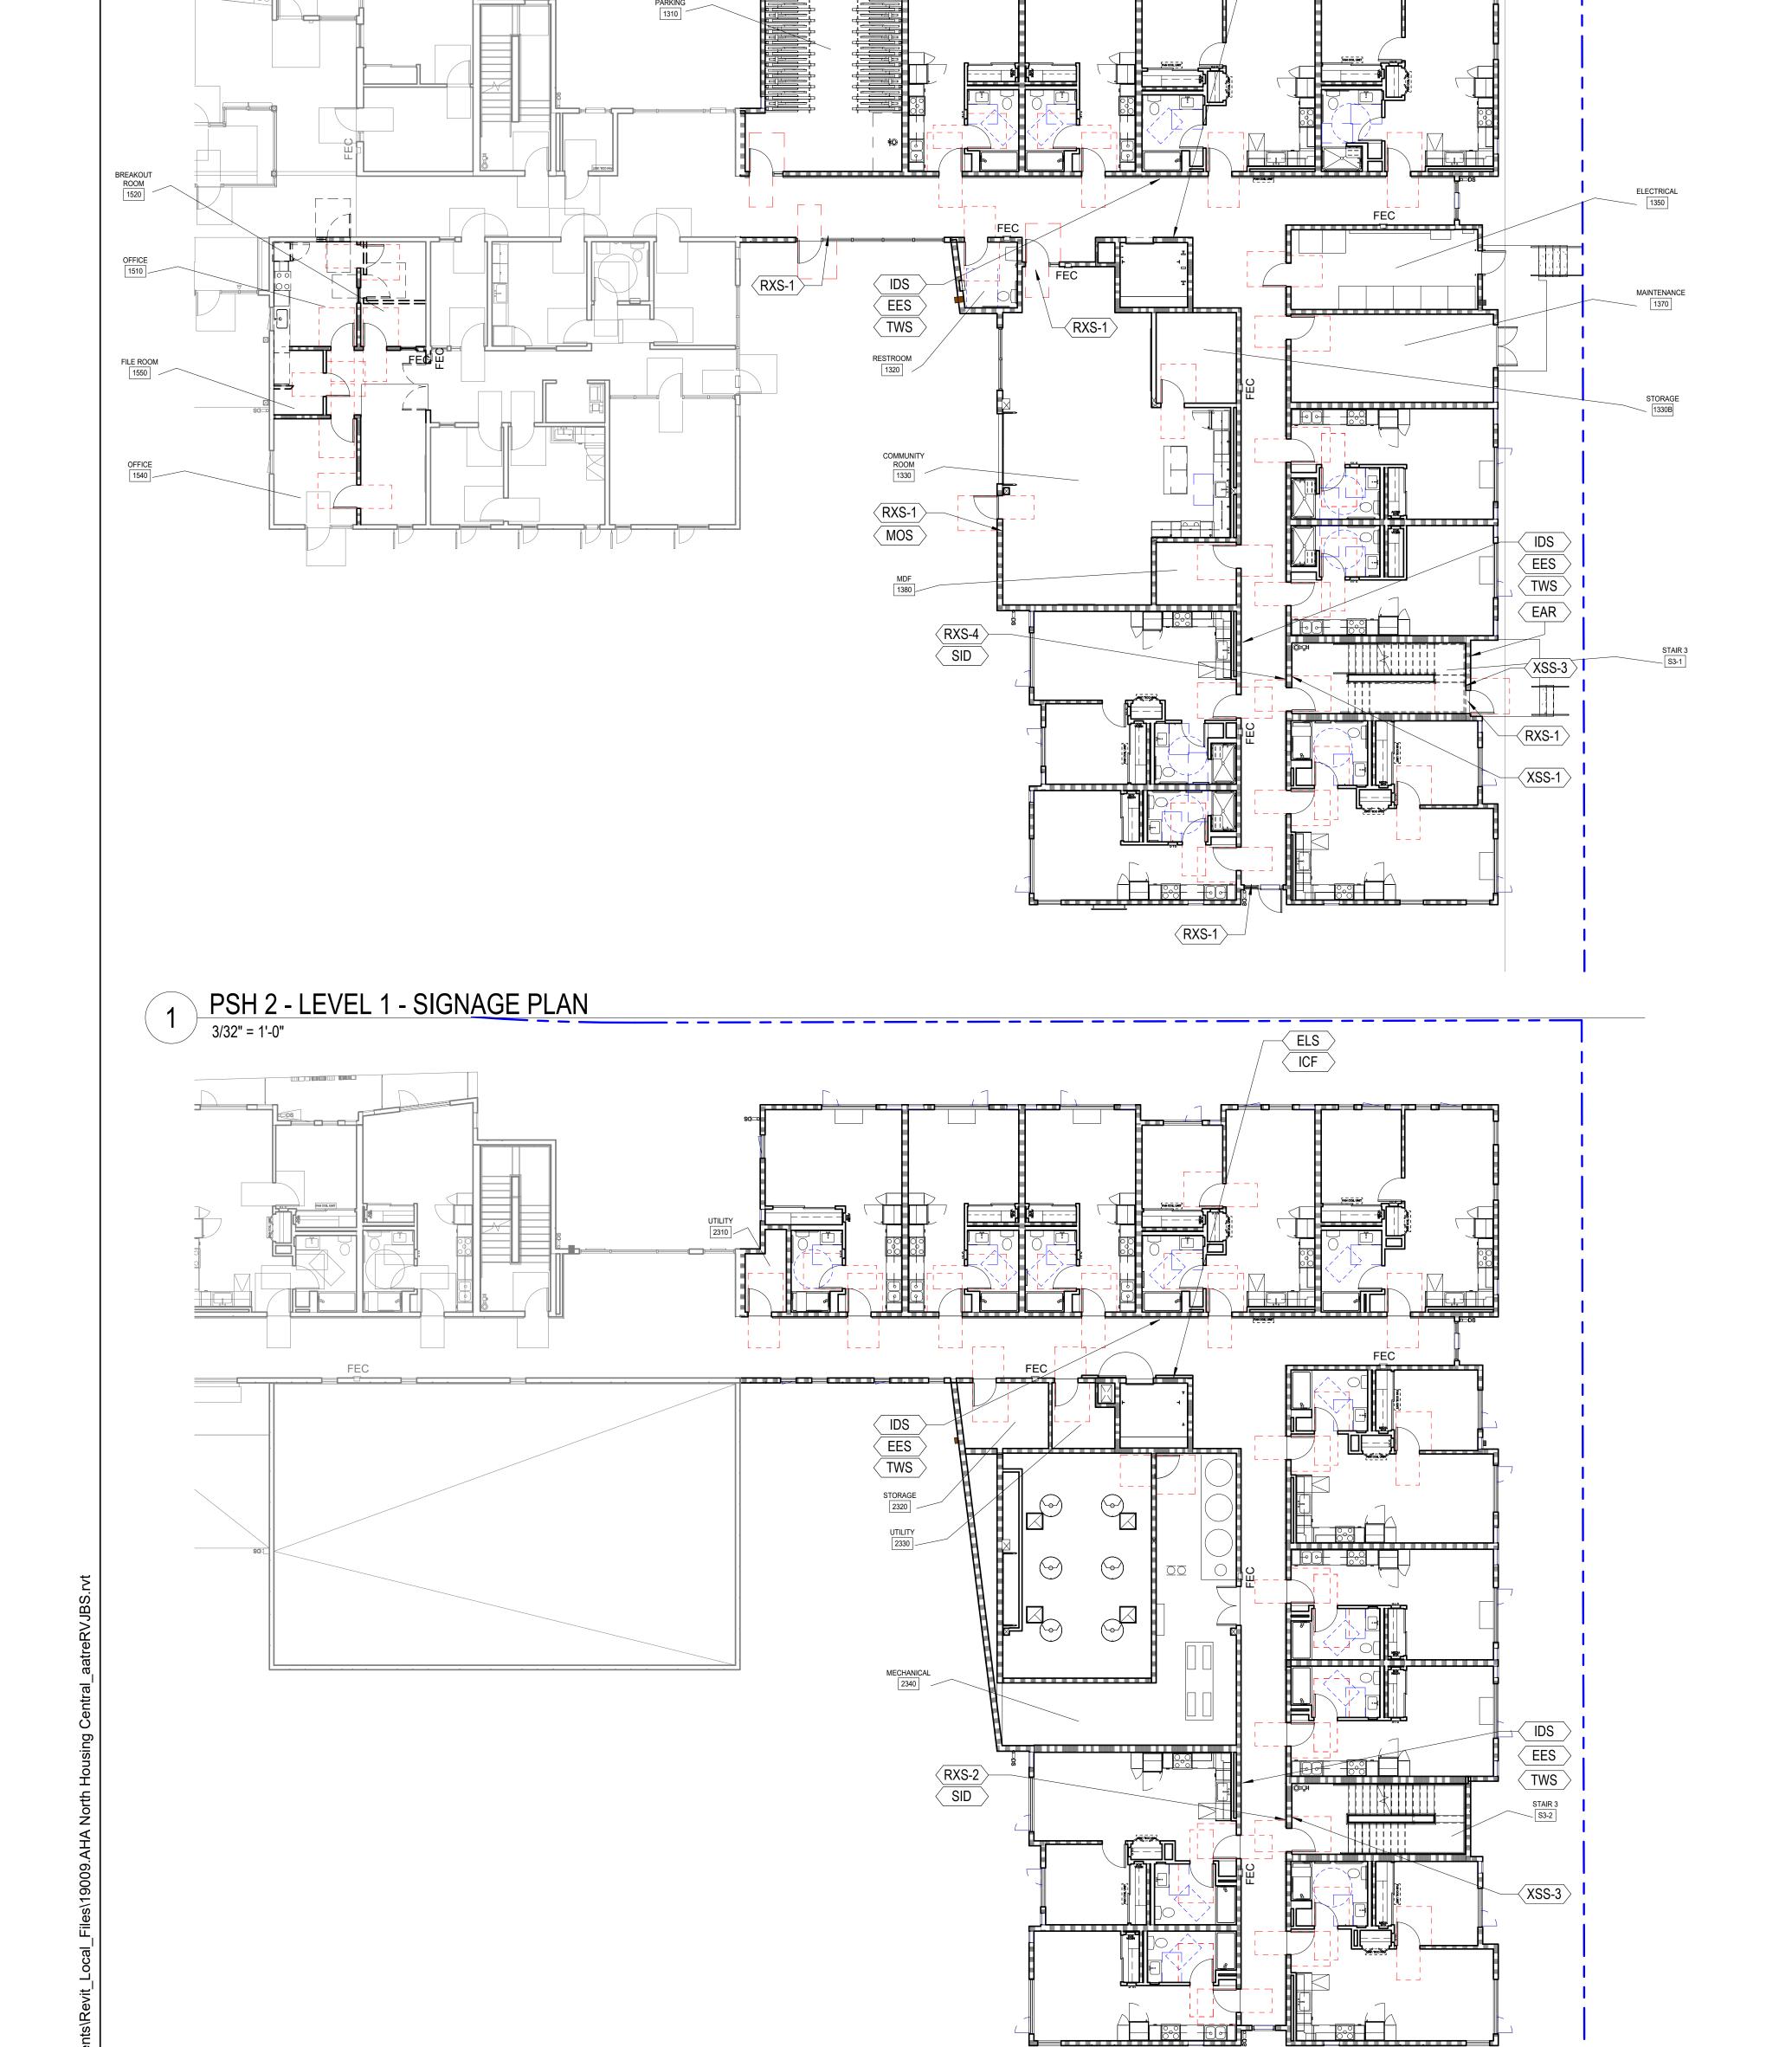

2 PSH 2 - LEVEL 2 - SIGNAGE PLAN
3/32" = 1'-0"

ELS ICF

North Housing, Block A

PSH PHASE 2

520 MOSLEY AVENUE ALAMEDA, CA 94501

JOB NO. DRAWN CHECKED Checker

JOB CAPTAIN

ISSUE DESCRIPTION 08/22/22 50% CD SET 09/29/22 PERMIT SUBMITTAL 3 03/01/23 PSH 2 Resubmittal 1

06/28/23 BID SET

DRAWING TITLE PSH 2 - SIGNAGE PLAN

**GENERAL NOTES - SIGNAGE PLAN** 

1. ALL SIGNS SHALL BE SENT TO THE LIGHT HOUSE OF THE BLIND FOR REVIEW AND APPROVAL PRIOR TO FABRICATION.

2. SIGNS CONTAINING TACTILE CHARACTERS SHALL BE LOCATED SO THAT A CLEAR FLOOR SPACE OF 18"X18" MIN. CENTERED ON THE TACTILE CHARACTERS AT THE LATCH SIDE OF THE DOOR IS PROVIDED.


3. SEE ALSO SIGNAGE PLANS, DOOR SCHEDULES, SITE PLAN, FLOOR PLANS, ACCESSIBILITY DETAILS AND FINISH SCHEDULES FOR SIGNAGE INFORMATION.

4. ALL SIGNS TO BE 0.25" NON-GLARE ACRYLIC WITH SUB-SURFACE PAINT AND STANDARD EDGES, U.O.N. NO APPLIED CHARACTERS WILL BE ACCEPTED. FONT AND COLOR SELECTION BY ARCHITECT FROM MIDPEN SIGNAGE STANDARDS OPTIONS.


5. FOR TYPICAL MOUNTING SEE SHEET A9.91

# SIGNAGE SCHEDULE

CODE	TYPE	DETAIL	TACTILE	REMARKS
<u>ALD</u>	ASISTIVE LISTENING DEVICE	30 / A9.91	NO	
<u>ARS (-L,-R, -N)</u>	ACCESSIBLE ROUTE SIGN	14 / A9.91	NO	COORDINATE IN FIELD
<u>APS</u>	ACCESSIBLE PARKING SIGN	23 / A9.91	NO	SEE CIVIL DWGS
<u>CBI</u>	CALL BOX INSTRUCTION	15 / A9.91	YES	
<u>CGG</u>	CEILING CLEARANCE GUARD	4 / A9.91	NO	
<u>EES</u>	EMERGENCY EVACUATION SIGN	21 / A9.91	NO	
<u>ELS</u>	ELEVATOR LEVEL DESIGNATION SIGN	11 /A9.91	NO	
<u>ISA</u>	INT'L SYMBOL OF ACCESSIBILITY	27 / A9.91	YES	
<u>ICF</u>	IN CASE OF FIRE SIGN	16 / A9.91	YES	
<u>IDS</u>	INTERIOR DIRECTIONAL SIGN	21 / A9.91	NO	
<u>MOS</u>	MAXIMUM OCCUPANCY SIGN	20 / A9.91	NO	REVIEW BY FIRE DEPT
<u>NSS</u>	NO SMOKING SIGN	22 / A9.91	NO	CONFIRM W/LOCAL JURISDICTION
<u>PLZ</u>	PASSENGER LOADING ZONE SIGN	26 / A9.91	NO	
RDS - 1 (2,3)	RESTROOM DOOR SIGN	8 / A9.91	NO	
<u>RIS</u>	ROOM IDENTIFICATION SIGN	13 / A9.91	YES	
RWS - 1 (2,3)	RESTROOM WALL SIGN	5 / A9.91	YES	
RXS - 1 (2-4)	TACTILE ROOM EXIT SIGN	12 / A9.91	YES	
<u>SID</u>	STAIR IDENTIFICATION SIGN	1 / A9.91	YES	
<u>TWS</u>	TWO WAY COMMUNICATION SIGN	10 / A9.91	NO	
<u>UIS</u>	UNIT IDENTIFICATION SIGN	2 / A9.91	NO	
<u>UVS</u>	UNAUTHORIZED VEHICLE	18 / A9.91	NO	SEE CIVIL DWGS
<u>XSS</u>	STAIRWELL LANDING SIGN	17 / A9.91	YES	
<u>EAR</u>	EXTERIOR AREA FOR ASSISTED RESCUE SIGN	1 /A9.92	YES	

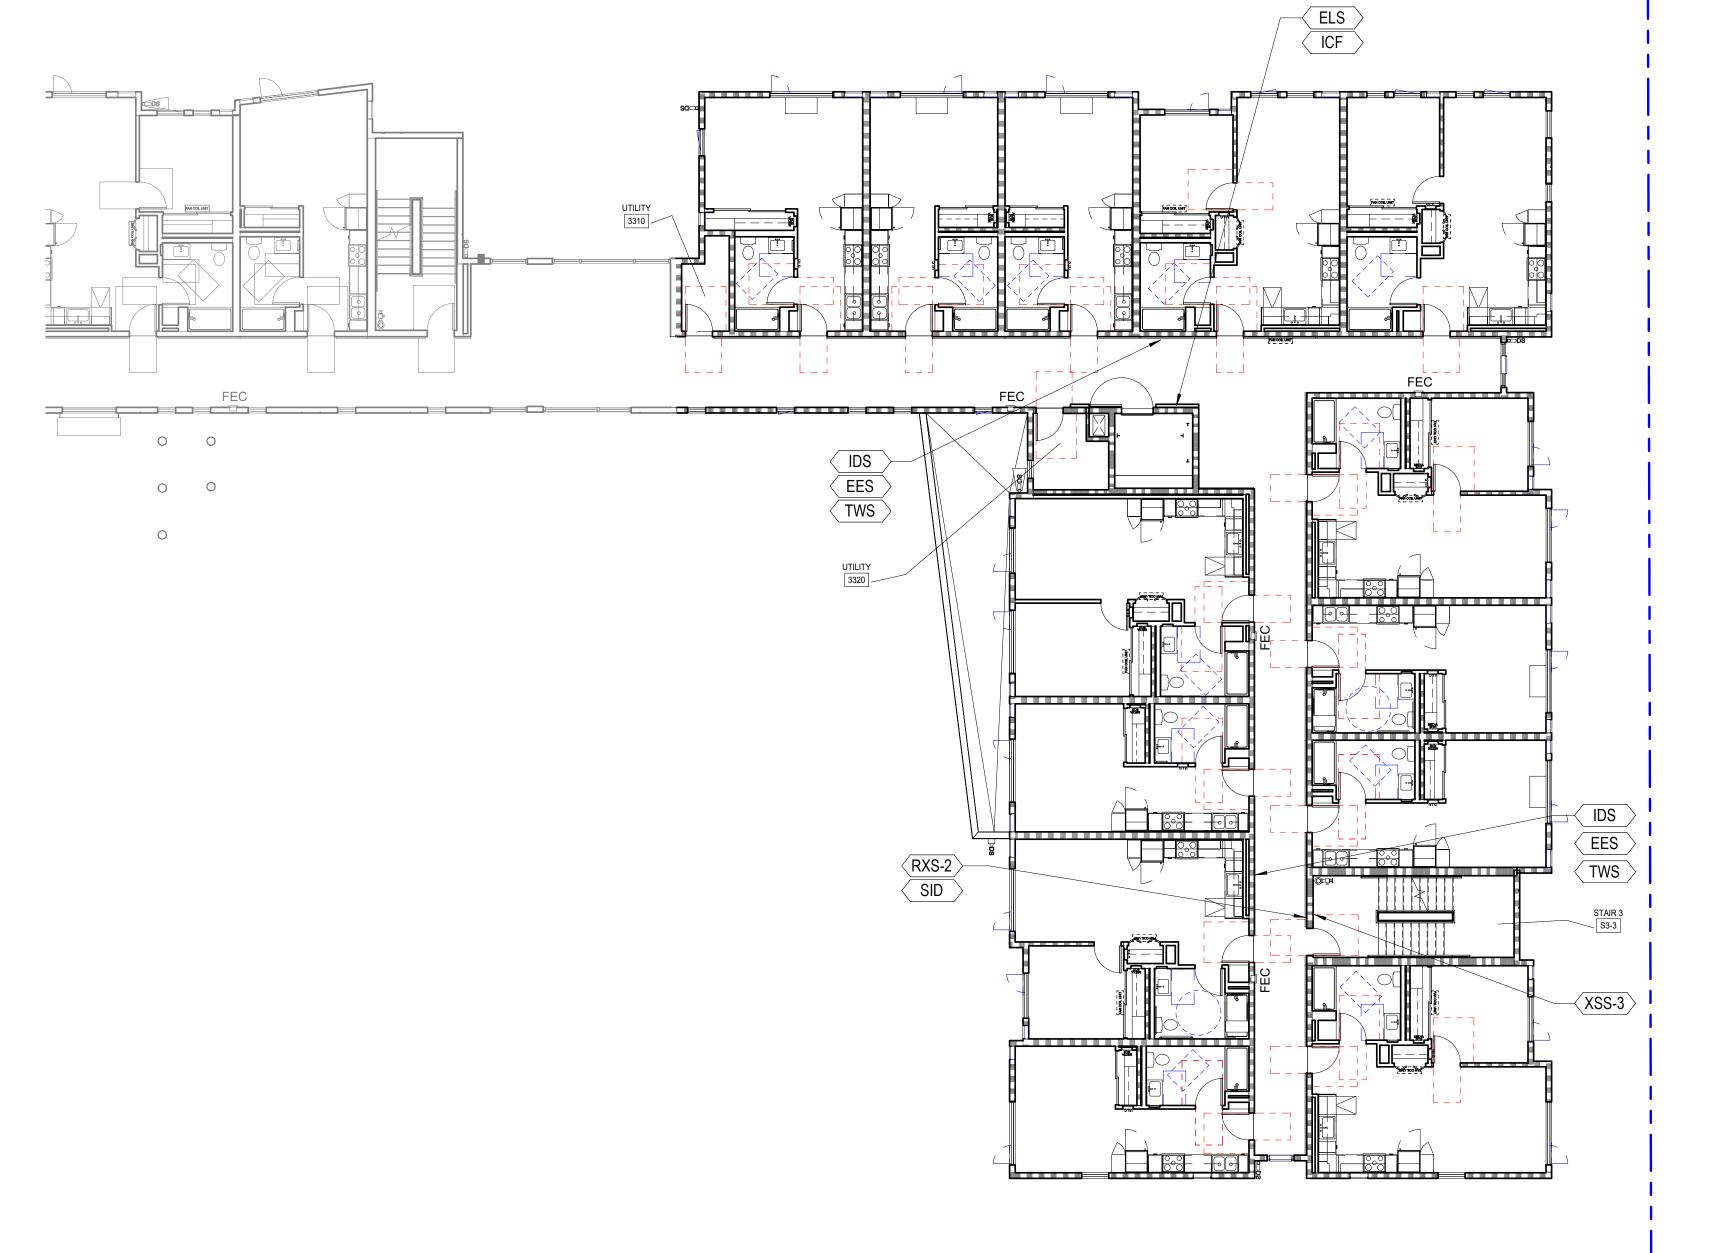

2 PSH 2 - LEVEL 4 - SIGNAGE PLAN
3/32" = 1'-0"

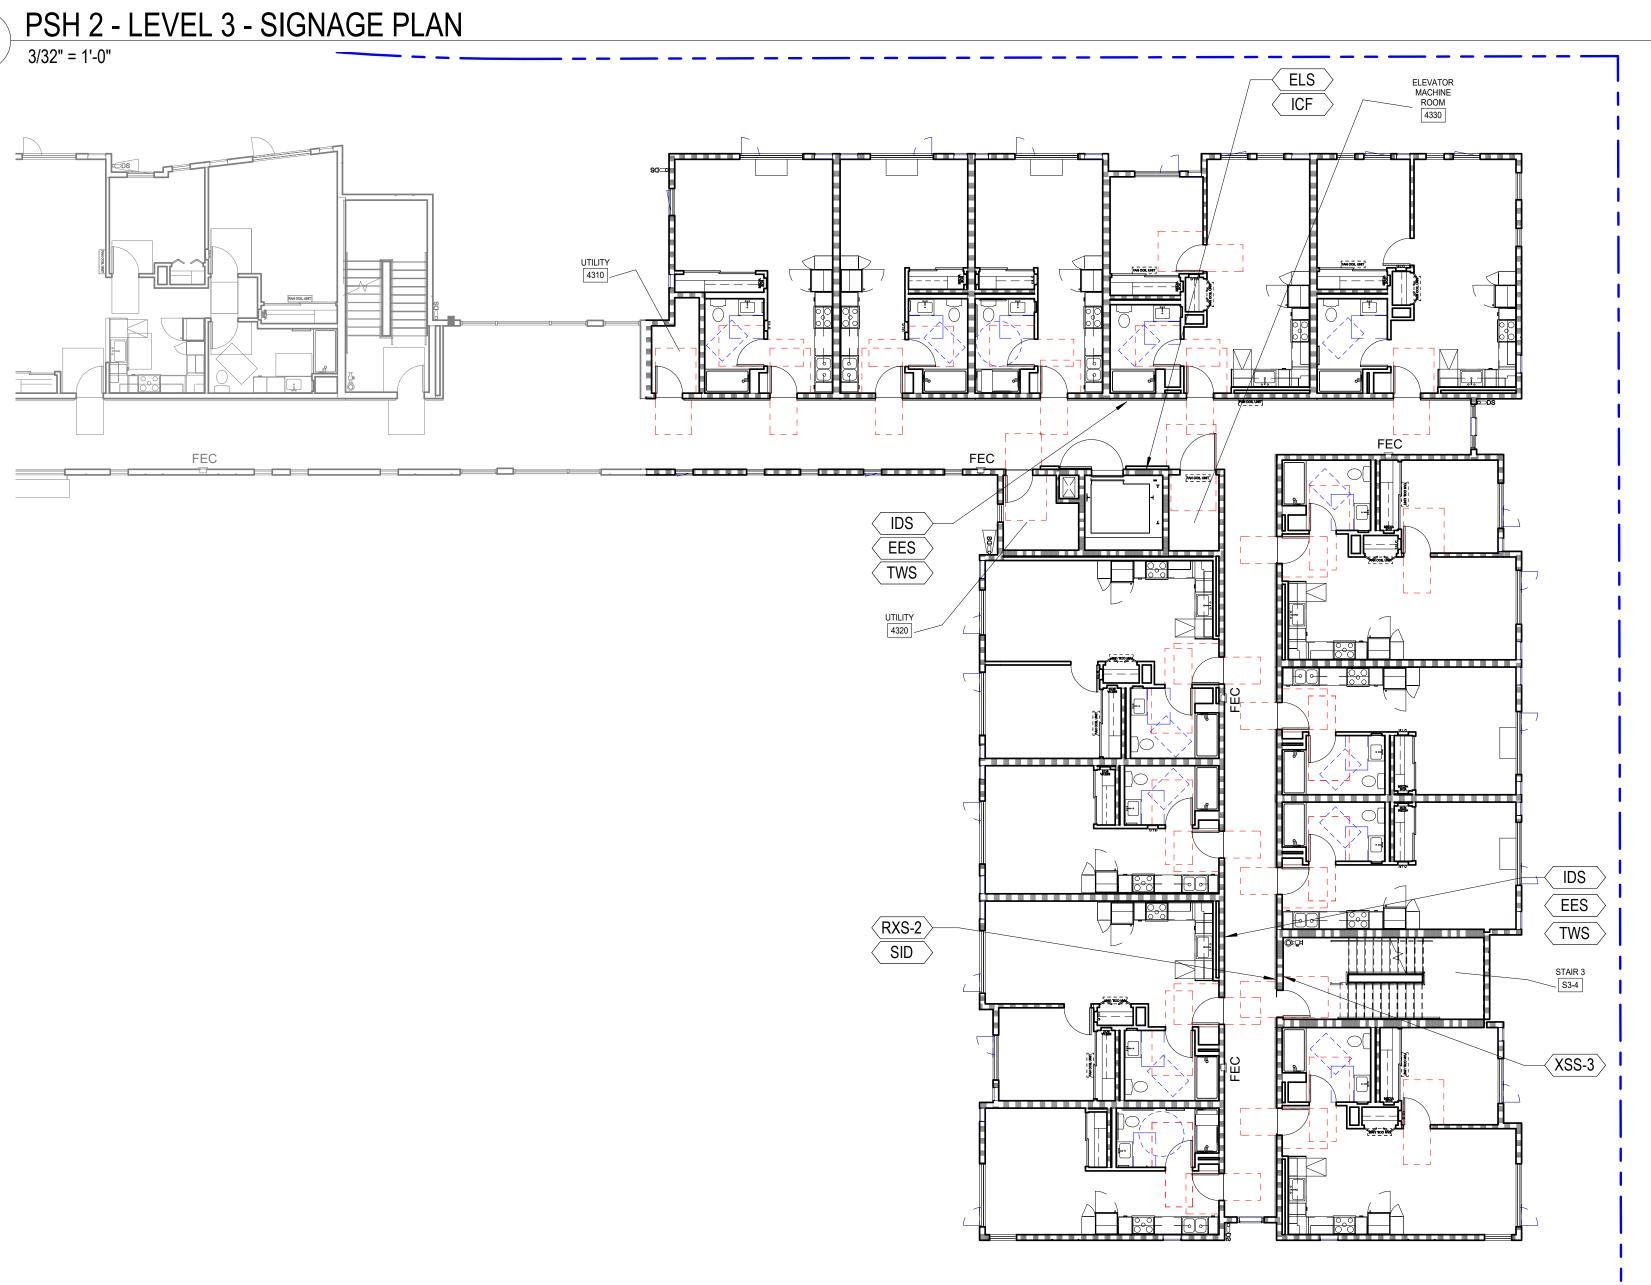

North Housing, Block A

PSH PHASE 2

520 MOSLEY AVENUE ALAMEDA, CA 94501

JOB NO. DRAWN CHECKED Checker

06/28/23 BID SET

JOB CAPTAIN

ISSUE DESCRIPTION 08/22/22 50% CD SET 09/29/22 PERMIT SUBMITTAL 3 03/01/23 PSH 2 Resubmittal 1

DRAWING TITLE PSH 2 - SIGNAGE PLAN